
A New Warehouse for Builders FirstSource

PROPOSED

DOOR

PRESCOTT VALLEY, ARIZONA

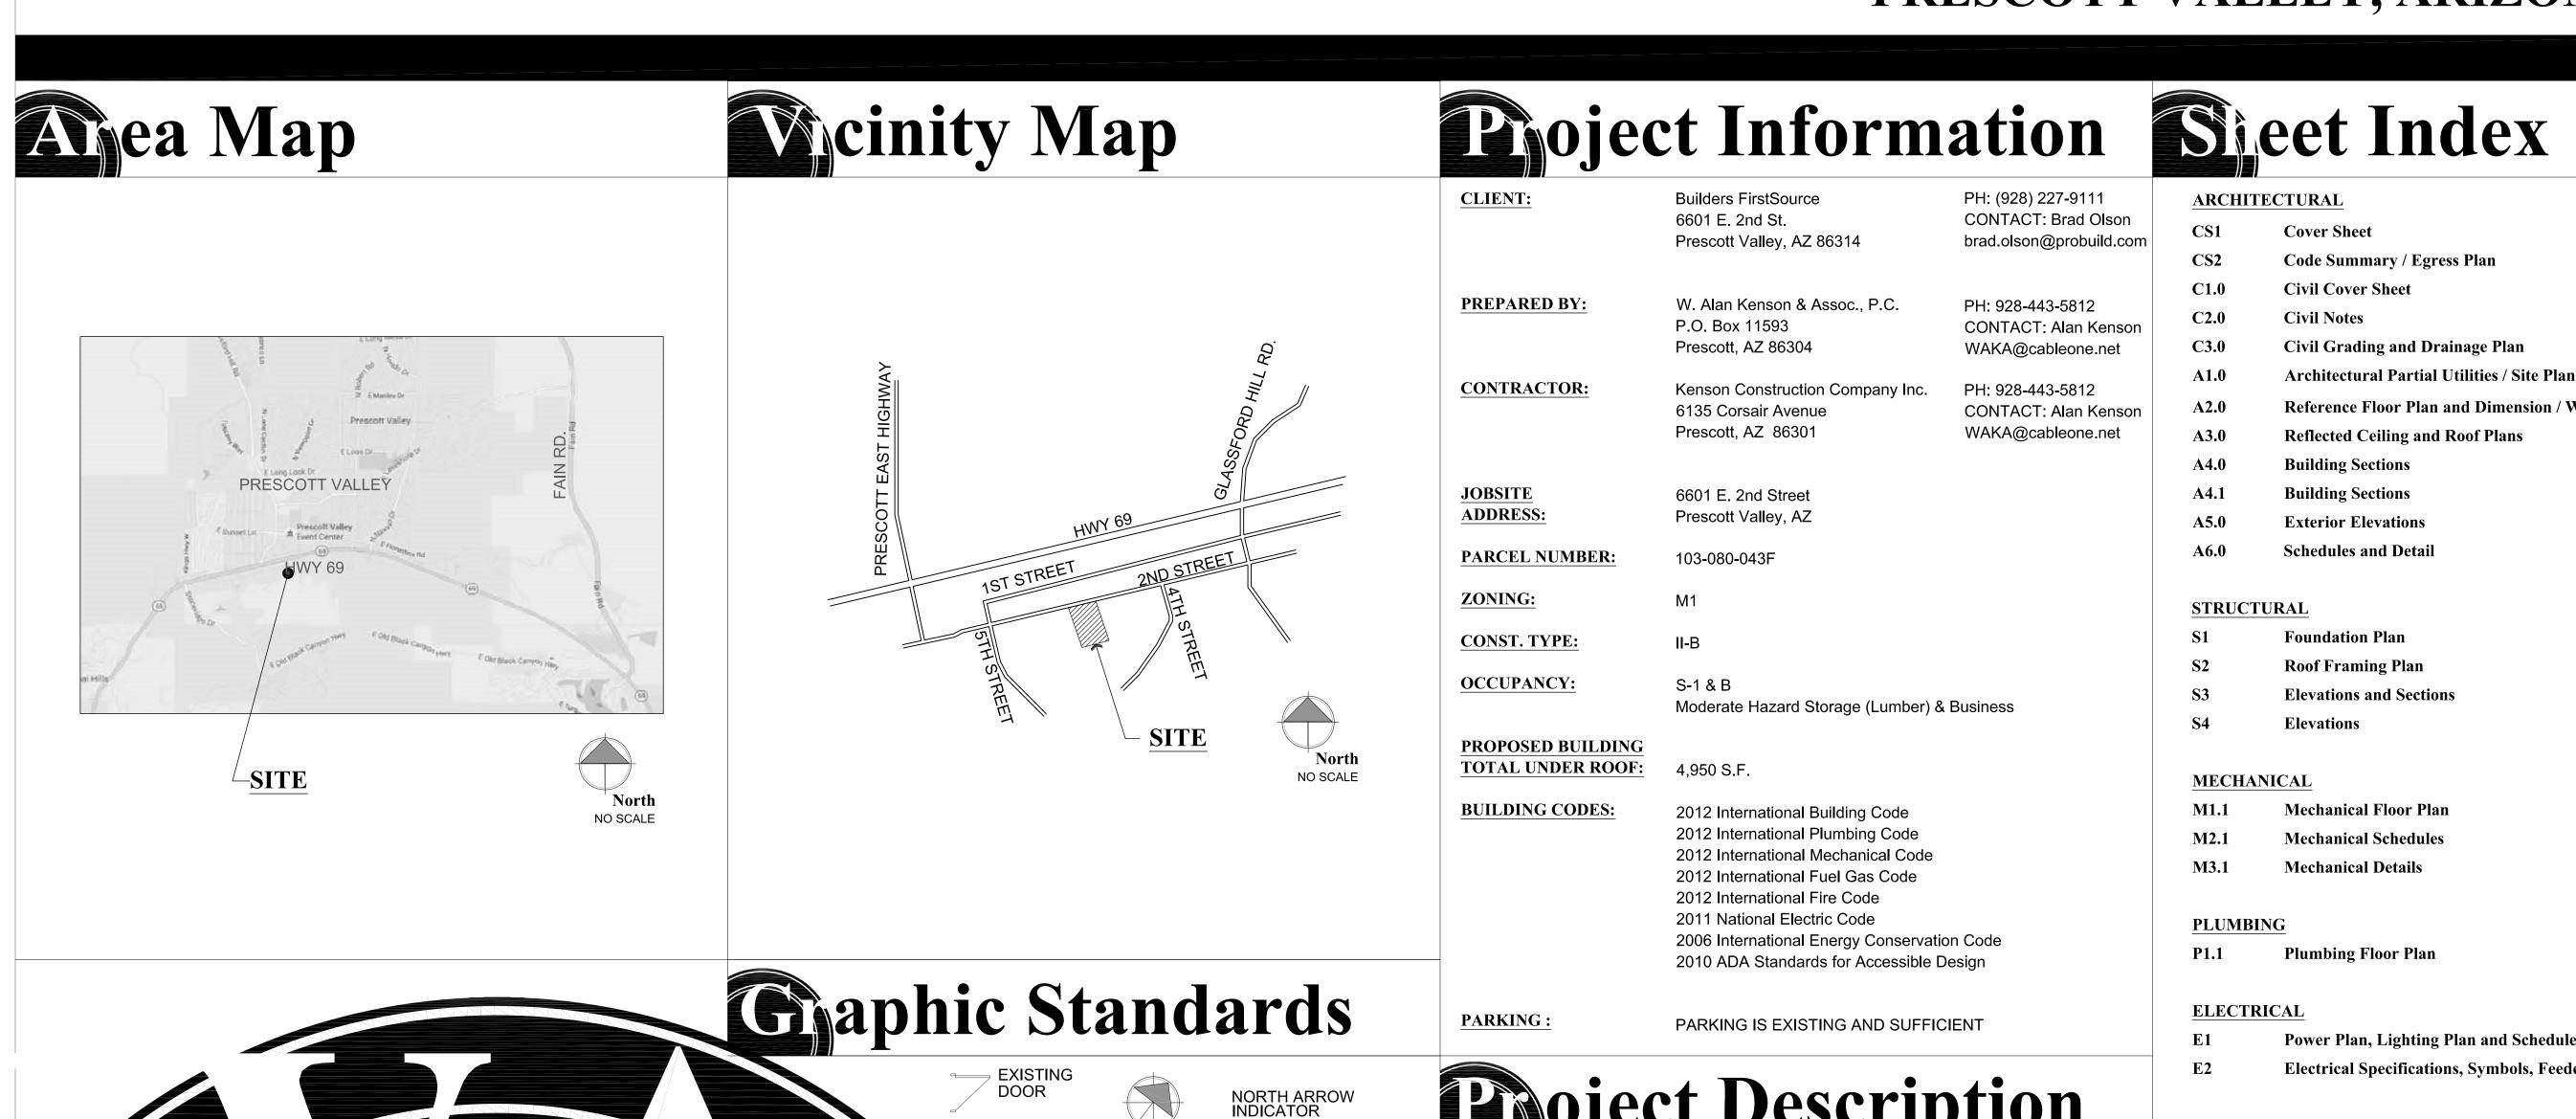

DETAIL DESIGNATOR

BUILDING SECTION DESIGNATOR

GRID LINE DESIGNATOR

REVISION DESIGNATOR

ELEVATION DESIGNATOR

DOOR TYPE DESIGNATOR

WALL TYPE DESIGNATOR

DESCRIPTIVE NOTE DESIGNATOR

ROOM NUMBER / FINISH DESIGNATOR

DOOR NUMBER DESIGNATOR

WINDOW TYPE DESIGNATOR

/ LETTER

Code Summary / Egress Plan

Reference Floor Plan and Dimension / Wall Types Plan

Elevations and Sections

Mechanical Floor Plan

Power Plan, Lighting Plan and Schedules

Electrical Specifications, Symbols, Feeder Schedule and Electrical Site Plan

Project Description

Builders FirstSource intends to add a storage/warehouse building to their existing property which currently has covered storage areas and a sales / display / office building. The proposed building will be a steel structure with 4950 s.f. under roof. A loading ramp will be included on the south end of the building and 3 offices will be constructed on the north end.

Architect:

W. Alan Kenson & Associates, P.C.

P 928-443-5812 F 928-443-5815 P.O. Box 11593 Prescott, AZ 86304


email: waka@cableone.net www.kenson-associates.com

ARCHITECTURE & PLANNING



REVISIONS

DRAWN BY L.O. CHECKED BY W.A.K. May 9, 2017 JOB NO. **699**

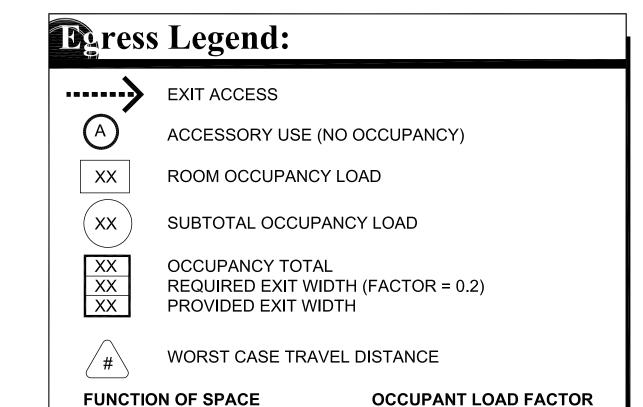

Ocupant load

WAREHOUSE

OFFICE

GROSS SQUARE FOOTAGE LISTED BELOW DOES NOT INCLUDE ACCESSORY AREAS.

OFFICE AREA: WAREHOUSE: TOTAL:

609 SQ. FT. 6 OCCUPANTS 3,603 SQ. FT 7.2 OCCUPANTS

4,212 SQ. FT. 13.2 OCCUPANTS

500 GROSS 100 GROSS

Pumbing

RESTROOMS ARE IN THE EXISTING SALES BUILDING AND ARE ADEQUATE. THE DISTANCE FROM THE EXISTING SALES BUILDING TO THE PROPOSED BUILDING IS APPROXIMATELY 120 FEET. THERE WILL NOT BE ANY ADDED EMPLOYEES IN THE NEW BUILDING.

Accessibility Notes

- ACCESS TO THESE FACILITIES SHALL BE AT PRIMARY ENTRANCES.
- 2. THE SLOPE OF PUBLIC WALKS SHALL NOT EXCEED A MAXIMUM CROSS SLOPE OF 2%.
- WALKING SURFACES GREATER THAN 2% SHALL BE SLIP RESISTANT.
- PROVIDE A 44"x60" MINIMUM LANDING ON THE STRIKE SIDE OF THE ENTRANCE DOOR WITH 44" MINIMUM WIDTH IN THE DIRECTION OF TRAVEL.
- WALLS SHALL EXTEND 18" TO THE SIDE OF THE STRIKE EDGE OF A DOOR OR GATE THAT SWINGS TOWARDS THE OCCUPANT.
- 6. RAMPS SHALL HAVE A NON-SLIP SURFACE.
- 7. RAMPS SHALL BE A MINIMUM OF 36" WIDE.
- EVERY REQUIRED EXIT DOORWAY SHALL BE SIZED FOR A DOOR NOT LESS THAN 36" WIDE BY NOT LESS THAN 6'-8" HIGH CAPABLE OF OPENING 90 DEGREES AND MOUNTED SO THE CLEAR WIDTH OF THE EXIT WAY IS 32" MINIMUM.
- THRESHOLDS TO BE A MAXIMUM OF 1/4" ABOVE ADJACENT FLOOR FINISH. ONE-HALF INCH THRESHOLD MAY BE USED IF BEVELED PER A.D.A. STANDARDS.
- 10. MAXIMUM EFFORT TO OPERATE A DOOR SHALL NOT EXCEED 5 POUNDS.
- 11. THE BOTTOM 10 INCHES OF ALL DOORS EXCEPT AUTOMATIC AND SLIDING DOORS SHALL HAVE A SMOOTH UNINTERRUPTED SURFACE.
- PROVIDE LEVER TYPE HARDWARE, PANIC BARS, PUSH AND PULL ACTIVATING BARS, OR OTHER HARDWARE DESIGNED TO PROVIDE PASSAGE WITHOUT REQUIRING THE ABILITY TO GRASP THE OPENING HARDWARE. (30" TO 44" A.F.F.)

 PROVIDE A 6"x9" BLUE TACTILE 'EXIT' SIGN AS MANUFACTURED BY 'SIMPLY EXIT SIGNS (#SE-1980)' OR EQUAL COMPLYING WITH ICCA117.1 AND IBC 1011.3 ADJACENT TO EACH DOOR TO AN EXIT PASSAGEWAY AND THE EXIT DISCHARGE. SIGN SHALL BE MOUNTED 60" A.F.F. TO THE CENTER OF THE SIGN.

SSOCI

ates

REVISIONS


These drawings are the property of W. Alan Kenson & Associates P.C

and may not be reproduced in any

way without the written consent of

DRAWN BY L.O. CHECKED BY W.A.K. May 9, 2017

Occupancy / Egress Floor Plan

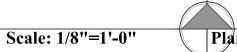

Site Map





Approved By

Town of Prescott Valley Date

Roject Information Steet Index

Builders FirstSource 6601 E. 2nd St. Prescott Valley, AZ 86314

PREPARED BY:

GEOTECHNICAL:

W. Alan Kenson & Associates, P.C. (928)-443-5812 Prescott, AZ 86304

Engineering & Testing Consultants

Prescott, AZ 86301 6601 East 2nd Street **PROJECT ADDRESS:**

103-080-43F PARCEL #: **ACREAGE**: 3.66 Acres

Building Materials Warehouse SITE USE:

Contact: Alan Kenson, AlA

waka@cableone.net

(928-778-9001) Contact: Rick Kelley

C1.0 Civil Cover Sheet

C3.0 Civil Grading and Drainage Plan


Wility Contact Info. Benchmark Info.

UTILITY	COMPANY	CONTACT	PHONE
ELECTRIC / POWER	ARIZONA PUBLIC SERVICE CO. 6672 CORSAIR AVE. PRESCOTT, AZ 86301	KRISTY LOPEZ	928-443-6635
PHONE / COMMUNICATION	CENTURY LINK 1445 MASONRY WAY PRESCOTT, AZ 86301	KAREN PORTER	928-776-2510
NATURAL GAS	UNISOURCE 6405 WILKINSON DR. PRESCOTT, AZ 86301	SARA SCOTT	928-771-7227
CABLE TELEVISION	CABLEONE 3801 TOWER RD. PRESCOTT, AZ 86301	JOHNNY CEDILLO	928-443-3300
WATER & SEWER	TOWN OF PRESCOTT VALLEY 7501 EAST CIVIC CIRCLE	NEIL WADSWORTH	928-759-3078

CALL TWO WORKING DAYS BEFORE YOU DIG 1-800-STAKE-IT 1-800-782-5348 (OUTSIDE MARICOPA COUNTY)

PRESCOTT VALLEY,

State / Vicinity Map

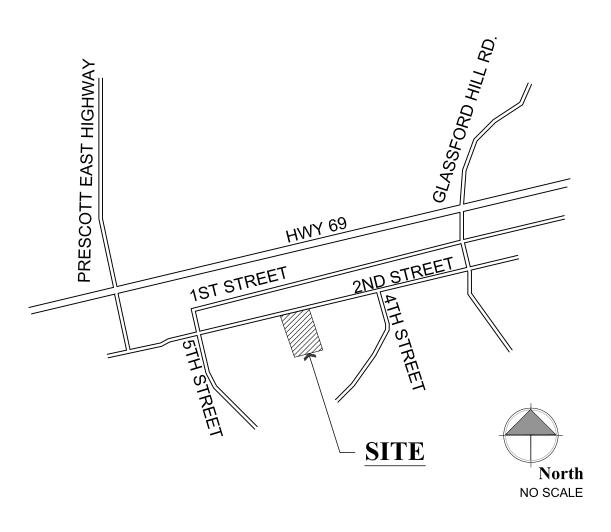

SCALE: NTS

PROJECT BENCHMARK FOR THIS PROJECT IS THE FINISH FLOOR OF THE **EXISTING SALES / OFFICE BUILDING**

Tagal Description

LEGAL DESCRIPTION

A PORTION OF MYRTLE NO. 1 AND MYRTLE NO. 4 PLACER MINING CLAIM IN THE WALKER MINING DISTRICT AS, GRANTED BY PATENT RECORDED IN BOOK 114 OF OFFICIAL RECORDS, PAGE 264 OF THE RECORDS OF YAVAPAI COUNTY, ARIZONA, SITUATED IN THE NORTH HALF OF SECTION 22, TOWNSHIP 14 NORTH, RANGE 1 WEST, GILA AND SALT RIVER BASE AND MERIDIAN, YAVAPAI COUNTY, ARIZONA, MORE PARTICULARLY DESCRIBED AS FOLLOWS:

FROM THE NORTHEAST SECTION CORNER OF SAID SECTION 22;

THENCE SOUTH 0008'21" EAST, ALONG THE EAST SECTION LINE OF SAID SECTION 22, FOR A DISTANCE OF 1,254.51 FEET TO A POINT ON THE SOUTHERLY RIGHT OF WAY LINE OF U.S.HIGHWAY 69;

DISTANCE OF 5.14 FEET TO A POINT ON THE CENTERLINE OF CASTLE VIEW DRIVE AS ON THE PLAT OF DEDICATION RECORDED IN BOOK 24 OF MAPS AND PLATS, PAGE 5 (R2);

THENCE NORTH 7651'40" EAST, ALONG THE SOUTHERLY RIGHT OF WAY LINE OF SAID U.S.HIGHWAY 69 FOR A

THENCE SOUTH 1308'20" EAST, ALONG THE CENTERLINE OF SAID CASTLE VIEW DRIVE, FOR A DISTANCE OF 399.00 FEET TO A POINT OF INTERSECTION WITH THE CENTERLINE OF SECOND STREET;

THENCE SOUTH 7651'40" WEST, ALONG THE CENTERLINE OF SAID SECOND STREET, FOR A DISTANCE OF

THENCE SOUTH 1308'20" EAST, PERPENDICULAR TO THE CENTERLINE OF SAID SECOND STREET, FOR A DISTANCE OF 34.00 FEET TO THE SOUTH RIGHT OF WAY LINE AT THE WESTERLY END OF SAID SECOND

STREET AS SHOWN ON (R2); THENCE SOUTH 7651'40" WEST, PARALLEL TO THE CENTERLINE OF SECOND STREET AS DESCRIBED IN BOOK 2216 OF OFFICIAL RECORDS, PAGE 614, AND RE-RECORDED IN BOOK 2220 OF OFFICIAL RECORDS, PAGE 63, FOR A DISTANCE OF 441.15 FEET TO A FOUND CAP 17564, SAID POINT BEGIN THE NORTHWEST CORNER OF A

COUNTY, ARIZONA AND THE TRUE POINT OF BEGINNING; THENCE SOUTH 7652'37" WEST, PARALLEL TO THE CENTERLINE OF SECOND STREET AS DESCRIBED IN BOOK 2537 OF OFFICIAL RECORDS, PAGE 28, FOR A DISTANCE OF 417.89 FEET RECORD SOUTH 7652'37" WEST FOR

PARCEL OF LAND DESCRIBED IN BOOK 2220 OF OFFICIAL RECORDS, PAGE 65, RECORDS OF YAVAPAI

418.00 FEET (BOOK 2640 OF OFFICIAL RECORDS, PAGE 968 (R1) TO A FOUND CAP 17564; THENCE SOUTH 2139'40" EAST FOR A DISTANCE OF 520.98 FEET RECORD SOUTH 2138'34" EAST FOR 521.00 FEET (R1) TO A FOUND CAP 17564;

THENCE NORTH7650'47" EAST FOR A DISTANCE OF 417.95 FEET RECORD NORTH 7651'40" EAST FOR 418.00

THENCE NORTH 2140'19" WEST FOR A DISTANCE OF 520.76 FEET RECORD NORTH 2138'34" WEST FOR 521.00 FEET (R1) TO THE TRUE POINT OF BEGINNING.

EXCEPT ANY VEIN OR LODE OF QUARTZ OR OTHER ROCK IN PLACE BEARING GOLD, SILVER, CINNABAR, LEAD, TIN, COPPER, OR OTHER VALUABLE DEPOSITS, CLAIMED OR KNOWN TO EXIST WITHIN THE ABOVE

DESCRIBED PREMISES ON

AUGUST 30,1957 AS RESERVED IN PATENT FROM UNITED STATES OF AMERICA.

REVISIONS

DRAWN BY W.A.K. May 9, 2017

THE TOWN DESIGN AND CONSTRUCTION STANDARDS (TDCS)

 SPECIFIC DEVELOPMENT AGREEMENTS TOWN CODE

 TOWN OF PRESCOTT VALLEY STANDARD DETAIL (PVSD) . MARICOPA ASSOCIATION OF GOVERNMENTS (MAG) STANDARDS AND OTHER STANDARDS LISTED IN THE TDCS.

103.2 LAWS & LICENSES -

THE CONTRACTOR MUST . COMPLY WITH ALL LOCAL, COUNTY, STATE, AND FEDERAL LAWS AND REGULATIONS APPLICABLE TO THE CONSTRUCTION COVERED BY THESE PLANS AND POSSESS A CURRENT TOWN OF PRESCOTT VALLEY BUSINESS LICENSE.

103.3 ENVIRONMENTAL CONTROLS -

THE FOLLOWING ARIZONA DEPARTMENT OF ENVIRONMENTAL QUALITY (ADEQ) REQUIREMENTS SHALL BE A STORM WATER POLLUTION PREVENTION PLAN (SWPPP) IS REQUIRED UNDER THE ARIZONA POLLUTANT DISCHARGE ELIMINATION SYSTEM GENERAL PERMIT (AZPDES) FOR ALL PROJECTS THAT INVOLVE DISTURBANCE OF AN AREA THAT IS MORE THAN 1 ACRE AND SHALL BE SUBMITTED TO THE TOWN FOR REVIEW. THIS SHOULD INCLUDE A LIST OF BEST MANAGEMENT

PRACTICES (BMPS) AND SHOULD BE IN BOOK/BINDER FORM. . A NOTICE OF INTENT (NOI) MUST BE SUBMITTED TO ADEQ THAT REFERENCES THE SWPPP . A NOTICE OF TERMINATION (NOT) SHALL BE SUBMITTED TO ADEQ ONCE 70% OF DISTURBED

LAND HAS BEEN SUCCESSFULLY RE-VEGETATED FOLLOWING PROJECT COMPLETION.
THE TOWN SHALL RECEIVE NOTIFICATION AND COPIES WHEN THE NOI AND NOT HAVE BEEN SUBMITTED

103.4 SWPPP

THE SWPPP REQUIRED PER SECTION 209 OF THE TDCS SHALL BE SUBMITTED BY THE OPERATOR OF THE CONSTRUCTION SITE ACCORDING TO GUIDELINES SET FORTH BY ADEQ. THE OPERATOR CAN BE THE OWNER, DEVELOPER, GENERAL CONTRACTOR OR INDIVIDUAL CONTRACTOR RESPONSIBLE FOR OPERATIONAL CONTROL.

THE OWNER IS RESPONSIBLE FOR OBTAINING AND COMPLYING WITH ALL PERMITS REQUIRED TO COMPLETE ALL WORK COVERED BY THESE PLANS. A SEPARATE PERMIT WILL BE REQUIRED FOR ANY CONSTRUCTION EXTENDING BEYOND THE CONSTRUCTION SITE PROPERTY BOUNDARY. A TOWN RIGHT-OF-WAY (ROW) PERMIT WILL BE REQUIRED FOR ALL CONSTRUCTION WITHIN PUBLIC ROW.

ANY QUANTITIES SHOWN ON PLANS ARE NOT VERIFIED BY THE TOWN,

ALL REVISIONS TO ORIGINAL PLANS MUST BE APPROVED BY THE ENGINEER OF RECORD (EOR) AND THE TOWN PRIOR TO CONSTRUCTION, DECISIONS REGARDING CHANGES WHICH CAN BE MADE IN THE FIELD OR AT THE DISCRETION OF THE EOR IN CONSULTATION WITH THE TOWN VERSUS THOSE WHICH REQUIRE FORMAL APPROVAL BY TOWN ENGINEERING STAFF SHALL BE DISCUSSED DURING PRE-CONSTRUCTION CONFERENCE. ANY WORK NOT BASED ON APPROVED REVISIONS IS SUBJECT TO REMOVAL AND/OR REPLACEMENT AT NO EXPENSE TO THE TOWN.

103.8 TRAFFIC CONTROL PLAN -

CONTRACTOR IS RESPONSIBLE FOR SUBMITTING A TRAFFIC CONTROL PLAN TO THE TOWN AS NEEDED TO PERFORM CONSTRUCTION ACTIVITIES, SUBMITTAL SHALL BE MADE AT LEAST FIVE TOWN WORKING DAYS (EXCLUDING HOLIDAYS) PRIOR TO COMMENCEMENT OF CONSTRUCTION, CONSTRUCTION CANNOT BEGIN UNTIL TOWN APPROVAL OF THE PLAN IS GRANTED. THE DYNAMIC NATURE OF TRAFFIC RELATED CONNECTION WITH THE WORK, NEITHER THE TOWN NOR THE EOR WILL BE RESPONSIBLE FOR THE ACTIVITIES MAY REQUIRE MODIFICATION OF AN APPROVED PLAN BASED ON TOWN ANALYSIS, IF SO, THE CONTRACTOR WILL MODIFY THE TRAFFIC CONTROL PLAN AT NO EXPENSE TO THE TOWN.

THE CONTRACTOR SHALL KEEP SUITABLE EQUIPMENT ON HAND AT THE JOB SITE FOR MAINTENANCE AND DUST CONTROL, AND SHALL CONTROL DUST AS DIRECTED BY THE APPROPRIATE AGENCIES,

THE CONTRACTOR SHALL KEEP ALL ROADWAY PAVEMENT, CURB AND GUTTER PAVEMENT, AND SIDEWALK PAVEMENT SURFACES FREE OF DEBRIS, CONSTRUCTION MATERIALS, ETC DURING CONSTRUCTION AND AT COMPLETION OF CONSTRUCTION.

THE CONTRACTOR IS RESPONSIBLE FOR ENSURING THAT CONSTRUCTION TRENCHES, HOLES DEPRESSIONS, ETC. ARE NOT LEFT EXPOSED AT THE END OF A WORK SHIFT. TRAFFIC PLATES, OR OTHER SECURITY MEASURES, MUST BE UTILIZED TO ENSURE SAFE PASSAGE OVER OR AROUND ALL HAZARDS. THE CONTRACTOR SHALL BARRICADE THE CONSTRUCTION SITE WHEN THE SITE IS

103.12 EXCESS MATERIALS -

CONTRACTOR IS RESPONSIBLE FOR ALL PROJECT GENERATED EXCESS. THIS INCLUDES, BUT IS NOT THE REMOVAL, TRANSPORT, PERMITTING, DISPOSAL, ETC. OF ANY EXCESS VEGETATION, SPOILS,

 SPOILS MUST ALSO BE CLEARED FROM ROADWAYS, PATHWAYS, OPEN GROUND, ETC. AT THE END OF A WORK SHIFT IF THEY INHIBIT CONVEYANCE OR IF SAFETY WITHIN THE PROJECT LIMITS WOULD BE COMPROMISED.

MATERIALS, DEBRIS, ETC. GENERATED BY A PROJECT AND ANY ASSOCIATED COSTS.

• EXPENSES RELATED TO EXCAVATION AND SPOIL SERVICES ARE THE RESPONSIBILITY OF THE

103.13 UTILITY CONFLICTS -

CONTRACTORS ARE RESPONSIBLE FOR VERIFYING ALL UTILITIES AND UNDERGROUND CONFLICTS IN ACCORDANCE WITH ARIZONA ADMINISTRATIVE CODE (AAC) REGULATIONS. THIS INCLUDES:

• EXCAVATION OF EXISTING INFRASTRUCTURE TO ENSURE LOCATION, SIZE, FITTINGS, DEPTH,

ALIGNMENT, ETC . EXCAVATION OF AREAS FOR NEW INFRASTRUCTURE TO ENSURE LOCATION, SIZE, FITTINGS,

DEPTH, ALIGNMENT, ETC. . EXCAVATION OF AREAS TO DETERMINE CONFLICTS WITH OTHER UTILITIES OR INFRASTRUCTURE,

BLUE STAKE LOCATING SERVICES MUST BE PERFORMED IN ADVANCE OF ANY CONSTRUCTION AND CONTRACTOR SHALL OBSERVE ALL POSSIBLE PRECAUTIONS TO AVOID ANY DAMAGE TO SUCH, THE CONTRACTOR SHALL CONTACT ARIZONA BLUE STAKE TWO WORKING DAYS (48 HOURS) PRIOR TO COMMENCEMENT OF CONSTRUCTION, CALL 1-800-STAKE-IT (1-800-782-5348), THE EOR AND/OR OWNER WILL NOT GUARANTEE ANY LOCATIONS AS SHOWN ON THESE PLANS OR THOSE OMITTED FROM SAME. SHOULD ANY LOCATION OR ELEVATION DIFFER FROM THAT SHOWN ON THESE PLANS, THE CONTRACTOR SHALL CONTACT THE OWNER'S AGENT FOR COORDINATION.

103.15 UTILITY ABANDONMENT -

ABANDONMENT IN PLACE OF PUBLIC UTILITY LINES SHALL BE AT THE DISCRETION OF THE TOWN AND SHALL BE IN ACCORDANCE PER APPLICABLE PVSD FOR ABANDONED UTILITIES.

103.16 ASBESTOS CEMENT PIPE -MAINTENANCE, REPAIR OR REPLACEMENT OF EXISTING ASBESTOS CEMENT PIPE SHALL BE IN

103.17 SEWER INSPECTIONS -

ACCORDANCE PER APPLICABLE PVSD.

FOR ANY CONSTRUCTION ADJACENT TO OR CROSSING EXISTING SEWER LINES, THE CONTRACTOR SHALL COMPLETE A PRE AND POST DVD VIDEO INSPECTION PER APPLICABLE PVSD. ADJACENT IN THIS SECTION IS DEFINED AS LESS THAN A 2 FOOT HORIZONTAL SEPARATION FROM NEW CONSTRUCTION. THE VIDEO INSPECTION SHALL OCCUR FROM THE NEXT ADJACENT UPSTREAM AND DOWNSTREAM MANHOLES BEYOND ALL CONSTRUCTION ACTIVITY. IF EVIDENCE OF DEBRIS OR DAMAGE IS FOUND, CONTRACTOR SHALL MAKE ALL NECESSARY REPAIRS AND ADDITIONAL VIDEO INSPECTION, AS DETERMINED BY THE TOWN, SHALL BE COMPLETED.

THE CONTRACTOR IS RESPONSIBLE FOR REPAIRING DAMAGE TO EXISTING UTILITIES AND/OR FACILITIES INCURRED DURING ANY CONSTRUCTION OPERATIONS.

THE CONTRACTOR SHALL NOTIFY THE EOR AND TOWN PUBLIC WORKS DEPARTMENT (928-759-3070) AT LEAST TWO WORKING DAYS (48 HOURS) IN ADVANCE OF CONSTRUCTION FOR INSPECTION.

WATER, GRAVITY SEWER, FORCED SEWER, RECLAIMED WATER AND STORM LINE TESTING SHALL NOT BE ACCEPTED UNLESS TESTING OCCURS AFTER ALL UNDERGROUND DISTURBANCES AND CONSTRUCTION IS COMPLETE. PRE-COMPLETION TESTS ARE ALLOWED, IF THE CONTRACTOR DESIRES SUCH ACTIVITY, BUT THE TOWN WILL NOT RECOGNIZE THE VALIDITY OF SAID TESTS.

INFRASTRUCTURE ADDED TO THE TOWN SYSTEM SHALL BE MANUFACTURED, ASSEMBLED OR OTHERWISE PRODUCED IN THE UNITED STATES UNLESS OTHERWISE APPROVED BY THE TOWN.

103.22 UTILITY ADJUSTMENTS -

ALL FRAMES, COVERS, VALVE BOXES, AND MANHOLES INSIDE THE PAVED SURFACE SHALL BE ADJUSTED TO FINISHED GRADE UPON COMPLETION OF PAVING OR RELATED CONSTRUCTION, ALL FRAMES, COVERS, AND VALVE BOXES OUTSIDE A PAVED SURFACE SHALL BE ADJUSTED BETWEEN 6 AND 8 INCHES ABOVE FINISHED GRADE UPON COMPLETION OF RELATED CONSTRUCTION.

103.23 DEFECTIVE MATERIALS -

ALL WORK AND MATERIALS WHICH DO NOT CONFORM TO THE REQUIRED STANDARDS, CODES AND AGREEMENTS ARE SUBJECT TO REMOVAL AND REPLACEMENT AT NO EXPENSE TO THE TOWN.

103.24 INSPECTIONS -

INSPECTION SHALL BE PERFORMED BY A QUALIFIED REPRESENTATIVE OF AN ENGINEER LICENSED IN THE STATE OF ARIZONA. THE DEGREE OF INSPECTION WILL BE DETERMINED AT THE PRE—CONSTRUCTION CONFERENCE. INSPECTION WILL BE DETERMINED AT THE PROPERTY OF ARIZONAL THE TOWN AND SHALL BE DESCRIBED BY A DEC. THE STATE OF ARIZONA, THE TOWN AND SHALL BE CERTIFIED BY THE EOR. THE TOWN WILL COMPLETE OVERSIGHT INSPECTION ONLY. THE EOR SHALL PROVIDE ALL CERTIFICATIONS AND OTHER DOCUMENTATION TO THE TOWN PRIOR TO ACCEPTANCE BY THE TOWN.

103.25 PLAN EXPIRATION -

PLANS SIGNED/APPROVED BY THE TOWN ARE NULL AND VOID ONE YEAR FROM DATE OF SIGNATURE IF CONSTRUCTION HAS NOT STARTED UNLESS OTHERWISE APPROVED BY THE TOWN.

THE CONTRACTOR SHALL MAKE NO CLAIM AGAINST THE OWNER, THE EOR OR SURVEYOR REGARDING THE INACCURACY OF CONSTRUCTION STAKES SET FORTH BY THE EOR OR SURVEYOR, UNLESS ALL SURVEY STAKES SET BY THE EOR OR SURVEYOR ARE MAINTAINED INTACT AND CAN BE VERIFIED AS O THEIR ORIGIN. IF, IN THE OPINION OF THE EOR, THE STAKES ARE NOT MAINTAINED INTACT AND CANNOT BE VERIFIED AS TO THEIR ORIGIN, ANY REMEDIAL WORK REQUIRED TO CORRECT ANY ITEM E PERFORMED AT THE SOLE EXPENSE OF THE RESPONSIBLE CONTRACTOR OR SUBCONTRACTOR.

THE CONTRACTOR AND/OR DEVELOPER SHALL PROVIDE A WARRANTY FOR ANY PUBLIC PROJECT OR ANY PROJECT THAT WILL BE GIVEN TO THE PUBLIC PER AGREEMENT(S). THE TOWN'S DEFINITION OF A WARRANTY INCLUDES ANY WORKMANSHIP, LABOR, MATERIALS, EQUIPMENT, SALES TAX, ETC. REQUIRED TO RESTORE A PROJECT TO ACCEPTANCE CRITERIA AS DEFINED BY THE PLAN. THE WARRANTY PERIOD LASTS FOR A MINIMUM OF TWO (2) YEARS FROM THE DATE OF TOWN ACCEPTANCE OF PROJECT COMPLETION, ALL WARRANTY WORK SHALL ALSO CONFORM TO ALL PORTIONS OF THE

QUANTITIES AND SITE CONDITIONS DEPICTED IN THESE PLANS ARE FOR INFORMATIONAL PURPOSES ONLY AND MAY BE SUBJECT TO ERRORS AND OMISSIONS. CONTRACTORS SHALL SATISFY THEMSELVES AS TO ACTUAL QUANTITIES AND SITE CONDITIONS PRIOR TO BIDDING THE WORK FOR THE CONSTRUCTION COVERED BY THESE PLANS, IF ANY DISCREPANCIES IN QUANTITIES OR SITE CONDITIONS ARE FOUND, THE CONTRACTOR SHALL NOTIFY THE EOR. THE TOWN DOES NOT WARRANT ANY QUANTITIES SHOWN ON THE PLANS.

CONTRACTOR SHALL NOTIFY THE EOR AND/OR SURVEYOR TWO WORKING DAYS (48 HOURS) IN ADVANCE OF ANY CONSTRUCTION TO SCHEDULE STAKING.

103.29 CONSTRUCTION SCHEDULE -

THE CONTRACTOR SHALL PROVIDE SUFFICIENT PERSONNEL AND EQUIPMENT ON THE JOB AT ALL TIMES DURING CONSTRUCTION TO COMPLY WITH THE CONSTRUCTION SCHEDULE, AND SPECIFICATIONS TO COMPLETE WORK.

103.30 CONSTRUCTION CONTRACT -

NOTHING CONTAINED IN THE CONSTRUCTION CONTRACT DOCUMENTS SHALL CREATE, NOR SHALL BE CONSTRUED TO CREATE, ANY CONTRACTUAL RELATIONSHIP BETWEEN THE EOR AND THE CONTRACTOR

NEITHER THE TOWN NOR THE EOR WILL BE RESPONSIBLE FOR CONSTRUCTION MEANS, METHODS, TECHNIQUES, SEQUENCES, PROCEDURES, SAFETY PRECAUTIONS OR PROGRAMS UTILIZED IN CONTRACTOR'S FAILURE TO CARRY OUT THE WORK IN ACCORDANCE WITH THE CONTRACT DOCUMENTS. APPLICABLE MAG/PVSD. CONCRETE ENCASEMENT OF WATER LINES IS NOT ALLOWED UNLESS

THE EOR WILL NOT GUARANTEE ANY ELEVATIONS OR LOCATIONS OF EXISTING UNDERGROUND UTILITIES SHOWN ON THESE PLANS, FIELD VERIFICATION BY THE CONTRACTOR WILL BE THE SOLE RESPONSIBILITY OF THE CONTRACTOR AND SHALL BE VERIFIED AS DEEMED NECESSARY BY THE CONTRACTOR, DAMAGE RESULTING FROM FAILURE TO ADEQUATELY LOCATE UTILITIES, AND TAKE NECESSARY PRECAUTIONS TO PROTECT THEM, WILL BE THE CONTRACTOR'S RESPONSIBILITY TO CORRECT AT NO EXPENSE TO THE TOWN OF PRESCOTT VALLEY.

103.33 DEFICIENCIES OR DISCREPANCIES -

FAILURE OF THE TOWN TO DETECT DEFICIENCIES OR DISCREPANCIES IN THE DESIGN OR CONSTRUCTION OF THESE PLANS SHALL IN NO WAY RELIEVE THE DEVELOPER, EOR OR THE CONTRACTOR FROM THEIR 601.5 ANSI / NSF -

PRIOR TO BIDDING THE WORK, THE CONTRACTOR SHALL THOROUGHLY SATISFY HIMSELF AS TO THE ACTUAL CONDITIONS, EARTHWORK QUANTITIES, REQUIREMENTS OF WORK AND DEFICIENCIES IN REQUIRED BY AAC. EARTHWORK QUANTITIES SHOULD THEY EXIST, NO CLAIM SHALL BE MADE AGAINST THE TOWN OR EOR FOR ANY EXCESS OR DEFICIENCY THEREIN, ACTUAL OR RELATIVE.

THESE PLANS ARE SUBJECT TO INTERPRETATION OF INTENT BY THE EOR. ALL QUESTIONS DISINFECTION AND TESTING OF COMPONENTS NOT APPLICABLE TO ADEQ ENGINEERING BULLETIN NO. REGARDING THESE PLANS SHALL BE PRESENTED TO THE EOR FOR CLARIFICATION IN CONCORDANCE

103.36 CONSTRUCTION WATER -

HE CONTRACTOR MUST REQUEST A HYDRANT METER FROM THE TOWN FOR SITE CONSTRUCTION, FILLING AND TESTING OF WATERLINES, THE METER SHOULD BE ORDERED 2 WORKING DAYS PRIOR TO THE START OF CONSTRUCTION. THE UNLAWFUL REMOVAL OF WATER FROM A FIRE HYDRANT OR ANY OTHER SOURCE IS A VIOLATION OF THE MUNICIPAL CODE, PUNISHABLE BY FINE AND/OR

103.37 AS-BUILT -

"AS-BUILT" DRAWINGS, CERTIFIED BY THE EOR, SHALL BE SUBMITTED AND APPROVED PRIOR TO ISSUANCE OF A BUILDING "CERTIFICATE OF OCCUPANCY".

ALL EXISTING LANDSCAPE INCLUDING TREES, SHRUBS AND IRRIGATION SYSTEMS THAT ARE DESIGNATED TO REMAIN OR ARE NOT PART OF THIS PROJECT, AND ARE DAMAGED DURING

CONSTRUCTION, WILL BE REPLACED IN LIKE KIND AT THE EXPENSE OF THE CONTRACTOR.

THE PLANS SHALL BE AMENDED AS NECESSARY DURING THE COURSE OF CONSTRUCTION TO RESOLVE PER APPLICABLE PVSD. ANY PROBLEM AREAS, WHICH BECOME EVIDENT DURING CONSTRUCTION, ROUTINE INSPECTIONS, AND/OR PERIODS OF RAINFALL IF IT IS DETERMINED THAT CURRENT CONTROLS ARE NOT EFFECTIVE AT MINIMIZING POLLUTANT DISCHARGES FROM THE SITE, IMMEDIATE EFFORTS SHALL BE MADE TO CORRECT THE PROBLEM WITHIN 72 HOURS AND/OR PRIOR TO THE NEXT RAIN EVENT. THE AMENDED PLAN SHALL BE MAINTAINED ON-SITE.

NO CONSTRUCTION MATERIAL, INCLUDING PORTABLE TOILETS SHALL BE STORED ON ANY PORTION OF ANY STREET, SIDEWALK, RIGHT-OF-WAY OR EASEMENT; OR WITHIN 50' OF ANY DRAINAGE WAY.

THE SITE SHALL AT ALL TIMES REMAIN FREE OF LOOSE TRASH AND DEBRIS, APPROPRIATELY SIZED COVERED WASTE RECEPTACLES SHALL BE PROVIDED ONSITE AND STORED A MINIMUM OF 50' FROM ANY DRAINAGE WAY OR DRAINAGE INLET.

SECTION 201

GRADING & DRAINAGE NOTIES

AN ON-SITE GRADING PERMIT IS REQUIRED.

THE FOLLOWING APPLY:

. A SEPARATE PERMIT IS REQUIRED FOR ANY OFF SITE GRADING.

PRIOR TO FINAL ACCEPTANCE, THE CONTRACTOR SHALL BE RESPONSIBLE FOR CLEANING, VISUAL AND/OR TV INSPECTION OF STORM DRAINAGE INFRASTRUCTURE PER APPLICABLE PVSD. THE TOWN AND EOR SHALL RECEIVE COPIES OF APPLICABLE DOCUMENTATION FOR REVIEW. THE EOR SHALL: DETERMINE IF THE REQUIRED PROCEDURES AND SUBSEQUENT DOCUMENTATION WERE COMPLIED

 REVIEW ALL DOCUMENTATION AND FINDINGS FOR COMPLIANCE WITH TOWN STANDARDS SUBMIT A REPORT TO THE TOWN WITH REGARD TO DISPOSITION.
THE TOWN WILL REVIEW THE EOR SUPPLIED REPORT TO DETERMINE IF THE PRODUCT IS ACCEPTABLE. PRIOR TO PROJECT FINAL ACCEPTANCE.

201.3 ON SITE MATERIALS

THE GRADING CONTRACTOR SHALL DESIGNATE A LOCATION FOR WASTING SPOIL MATERIALS AND A LETTER FROM THE PROPERTY OWNER GIVING PERMISSION FOR SAID DISPOSAL PRIOR TO STARTING

NO STRUCTURE OF ANY KIND SHALL BE CONSTRUCTED AND/OR ANY VEGETATION PLANTED OR ALLOWED TO GROW WITHIN, ON OR OVER ANY DRAINAGE EASEMENT WHICH WOULD OBSTRUCT OR DIVERT THE FLOW OF STORM WATER.

SECTION 301 TRANSPORTATION NOTES

NO PROJECT WILL BE CONSIDERED READY FOR FINAL ACCEPTANCE UNTIL ALL CURB, ROADWAYS, MEDIANS, SIDEWALKS AND ANY OTHER IMPACTED ROW AREAS HAVE BEEN SWEPT CLEAN OF ALL DIRT SECTION 630

301.2 SUBGRADE INSPECTION -

BASE COURSE SHALL NOT BE PLACED ON SUBGRADE UNTIL SUBGRADE REQUIREMENTS HAVE BEEN INSPECTED AND ACCEPTED BY THE EOR.

NO ABC PLACEMENT OR PAVING CONSTRUCTION SHALL BE STARTED UNTIL ALL UNDERGROUND UTILITIES WORK WITHIN THE ROADWAY PRISM ARE COMPLETED AND TESTED.

301.4 ASPHALT CONCRETE -

SPECIFICATION IS APPROVED BY THE TOWN, MIX DESIGN SHALL BE SUBMITTED PRIOR TO START OF

PAVEMENT SHALL INCLUDE A CHIP SEAL COAT INSTALLED PER MAG AND THE FOLLOWING: . FOR ARTERIAL AND COLLECTOR STREETS, CHIP SEAL SHALL BE "HIGH VOLUME SINGLE CHIP SEAL" USING AC15-5TR OR APPROVED EQUAL SPREAD AT 0.50 GAL/SY WITH 1/2 INCH HIGH

ALL AC SHALL BE C-3/4 "SMOOTH MIX" AS PER APPLICABLE MAG SPECIFICATIONS, UNLESS ANOTHER

VOLUME CHIP AT 32 LBS/SY. . FOR LOCAL, COMMERCIAL AND RESIDENTIAL STREETS, CHIP SEAL SHALL BE "LOW VOLUME SINGLE CHIP SEAL" USING CRS-2P SPREAD AT 0.40 GAL/SY WITH 3/8 INCH LOW VOLUME CHIP SEWER LINE LOW PRESSURE AIR TESTS SHALL BE DONE ON ALL LINES PURSUANT TO AMERICAN AT 25 LBS/SY.

. ALL STREETS SHALL BE SWEPT THE SAME DAY AS APPLICATION, CURBED STREETS REQUIRE A PICKUP BROOM TO REMOVE EXCESS CHIPS. USE OF A KICK BROOM IS ACCEPTABLE ON STREETS WITHOUT CURBS UPON APPROVAL OF THE TOWN ALL SURVEY MONUMENTS, BOXES, MANHOLES, FRAMES, VALVE, LIDS, ETC. SHALL BE PROTECTED FROM CHIP SEAL OPERATIONS AND SHALL BE ADJUSTED TO FINISHED ASPHALT OR CURB GRADES AFTER PLACEMENT OF SURFACE COURSE AND PRIOR TO CHIP SEAL BY THE CONTRACTOR PER

APPLICABLE PVSD. NO CHIP SEAL CONSTRUCTION WILL BE ALLOWED BETWEEN SEPTEMBER 1ST AND MAY 30TH. CHIP SEAL SHALL BE PLACED ONLY WHEN THE ROADWAY SURFACE IS DRY AND THERE IS NO THREAT OF RAIN. THE AMBIENT TEMPERATURE MUST BE 70 DEGREES F. AND RISING BEFORE CHIP SEAL OPERATIONS BEGIN. NO CHIP SEAL OPERATION SHALL BE CONSIDERED COMPLETE OR ACCEPTABLE FOR PAYMENT UNTIL INSPECTED AND ACCEPTED BY THE TOWN.

TRAFFIC CONTROL

A TRAFFIC CONTROL PLAN SHALL BE SUBMITTED TO THE TOWN'S PUBLIC WORKS OPERATIONS MANAGER, TRAFFIC CONTROL SHALL MEET APPROVAL PRIOR TO CONSTRUCTION.

WATER CONSTRUCTION NOTES 601.1 ADEQ REQUIREMENTS -

ADEQ REQUIREMENTS MUST BE COMPLIED WITH FOR ALL ASPECTS OF CONSTRUCTION AS MINIMUM STANDARDS, TOWN STANDARDS MAY IMPOSE ADDITIONAL OR MORE STRICT REQUIREMENTS. A SPECIFIC NOTE REFERENCING AAC R18-4-502, LATEST REVISION, MUST BE ON PLANS THAT WILL BE APPROVED BY ADEQ OR THEIR DELEGATED REVIEWER (YAVAPAI COUNTY).

PER AAC R18-5-508, ALL QUALITY CONTROL TESTING SHALL BE PERFORMED BY THE CONTRACTOR AND OBSERVED BY THE ENGINEER OF RECORD INCLUDING, BUT NOT LIMITED TO MICROBIOLOGICAL, PRESSURE AND DISINFECTION TESTING.

UTILITY CLEARANCES SHALL BE MAINTAINED IN ACCORDANCE PER APPLICABLE MAG/PVSD.

WATER AND SANITARY SEWER SEPARATION / PROTECTION SHALL BE IN ACCORDANCE PER APPROVED BY THE TOWN.

THE CONTRACTOR SHALL BE REQUIRED TO INSTALL A CONNECTION AT NIGHT BETWEEN 10 PM AND AM, MONDAY THRU THURSDAY, EXCLUDING HOLIDAYS, FOR ANY NEW WATERLINE THAT WILL AFFECT EXISTING SERVICE SUFFICIENT TO WARRANT SAME IN THE OPINION OF THE TOWN. NO SERVICE INTERRUPTION SHALL LAST LONGER THAN 4 HOURS WITHOUT APPROVAL OF THE TOWN AND A MINIMUM OF 48 HOURS' NOTICE IS REQUIRED PRIOR TO ANY SERVICE INTERRUPTION, SHUTDOWNS SHALL BE COORDINATED WITH THE TOWN AND ITS WATER OPERATIONS CONTRACTOR.

ALL COMPONENTS THAT COME INTO CONTACT WITH POTABLE WATER WILL MEET ANSI / NATIONAL

SANITATION FOUNDATION (NSF) STANDARD 61 AND BEAR THE ANSI / NSF STANDARD 61 SEAL AS

1. SWABBING OF ALL COMPONENTS IS REQUIRED. A 25 PARTS PER MILLION (PPM) SODIUM HYPOCHLORITE FREE CHLORINE SOLUTION MUST BE APPLIED TO ALL INTERIOR SURFACES INCLUDING VALVES, FLEX COUPLINGS, PIPE SEGMENTS OR OTHER INFRASTRUCTURE JUST PRIOR TO THEIR INSTALLATION.

2. SYSTEM FLUSHING SHALL BE CONDUCTED FROM THE NEAREST FIRE HYDRANT, BOA, OR SIMILAR APPURTENANCE. 3. DISCHARGE IN ACCORDANCE WITH AZPDES REGULATIONS

PRESSURE AND LEAKAGE TEST -

WATER MAINS AND APPURTENANCES SHALL BE SUBJECT TO A PRESSURE AND LEAKAGE TEST IN ACCORDANCE WITH MAG AND AMERICAN WATER WORKS ASSOCIATION (AWWA) STANDARDS. HOWEVER. TEST PRESSURE SHALL BE A MINIMUM OF 200 PSI OR 150% OF THE WORKING PRESSURE IN THE PIPE WHICHEVER IS GREATER. THE WORKING PRESSURE WILL BE BASED ON THE LOWEST

ELEVATION/HIGHEST PRESSURE POINT IN THE MAIN, WHICHEVER IS GREATER.

TRACE WIRE, CONTINUITY TEST, AND DETECTABLE TAPE REQUIRED PER APPLICABLE PVSD.

REMOVAL OR REPLACEMENT OF EXISTING ASBESTOS CEMENT PIPE (ACP) SHALL BE IN ACCORDANCE

HOT TAPS ARE AN EXCLUSIVE FUNCTION OF THE TOWN AND PERFORMED BY THE TOWN'S CONTRACT OPERATIONS COMPANY. CONTRACTOR IS RESPONSIBLE FOR TRENCHING / CLEARANCE PER APPLICABLE

VALVE OPERATION -

EXISTING SYSTEM VALVES TO BE OPERATED BY TOWN AUTHORIZED PERSONNEL ONLY.

801.12 WATER METER INSTALLATION -A WATER METER SHALL BE APPROVED FOR INSTALLATION ONLY AFTER THE FOLLOWING CONDITIONS

NEW SUBDIVISIONS: ATO OR ADEQ DOCUMENTATION SUBMITTED TO THE TOWN FROM THE EOR THAT STATES THAT AN ATO IS NOT REQUIRED. 2. NEW SUBDIVISIONS: WATER INFRASTRUCTURE MUST HAVE BEEN INSPECTED AND APPROVED BY THE EOR AND TOWN. 3. WATER METER AND WATER SERVICE REQUEST FEES MUST BE PAID

WATER METER BOXES AND LINE SETTERS MUST RECEIVE A BUILDING INSPECTION APPROVA THROUGH THE BUILDING PERMIT PROCESS. THE WATER SERVICE LINE BETWEEN THE METER AND THE STRUCTURE MUST EXTEND A MINIMUM OF 5 FEET AWAY FROM THE METER IN ORDER TO RECEIVE THE INSPECTION.

5. ONCE THE WATER METER HAS BEEN SET, NO DISTURBANCE OF THE METER, LINE SETTER, BOX OR GROUND WITHIN 5 FEET SHALL OCCUR. ANY DISTURBANCE TO THE METER, METER BOX OR LINE SETTER WILL RESULT IN DAMAGE AND/OR TAMPERING FEE PER TOWN CUSTOMER ACCOUNTS

6. APPROVED BACKFLOW PROTECTION HAS BEEN INSTALLED IF REQUIRED PER TOWN CODE AND APPLICABLE PVSD. 801.13 WATERLINE SERVICES -

VATERLINE SERVICES UP TO AND INCLUDING THE METER, METER BOX AND THE TRANSITION FITTING ON THE DISCHARGE/CUSTOMER SIDE OF THE SETTER (TAILSTOCK) ARE PUBLIC FACILITIES AND MUST BE PLACED IN EASEMENT OR ROW PER APPLICABLE PVSD.

601.14 PRESSURE REDUCING VALVE -

A PRESSURE REDUCING VALVE / PRESSURE REGULATOR IS REQUIRED FOR ALL DOMESTIC SERVICES IF FITTINGS . PRESSURE IN THE PUBLIC MAIN IS 80 PSI OR HIGHER, VALVES / REGULATORS ARE CONSIDERED AS PRIVATE PROPERTY AND SHALL BE MAINTAINED BY THE OWNER. IT SHALL BE LOCATED ON PRIVATE PROPERTY, OUT OF EASEMENT, DOWNSTREAM OF THE METER AND PRIOR TO BRANCHING / ENTRY TO THE PROPERTY'S PLUMBING SUPPLY,

DOMESTIC AND FIRE LINES TO A STRUCTURE MUST BE SEPARATELY TAPPED TO THE WATER DISTRIBUTION MAIN.

BACKFLOW PREVENTION REQUIREMENTS ARE NOTED PER AAC, TOWN CODE AND APPLICABLE PVSD.

<u>engineer's notes:</u>

ADEQ REQUIREMENTS MUST BE COMPLIED WITH. A SPECIFIC NOTE REFERENCING AAC R18-4-502,

LATEST REVISION, MUST BE ON PLANS THAT WILL BE APPROVED BY ADEQ OR THEIR DELEGATED

UTILITY CLEARANCES SHALL BE MAINTAINED IN ACCORDANCE PER APPLICABLE PVSD.

WATER, RECLAIMED WATER, AND SANITARY SEWER SEPARATION / PROTECTION SHALL BE IN

AT LOCATIONS WHERE WATER/SEWER/RECLAIMED UTILITIES CROSS, REFERENCE AAC AND ANY

SEWER MANHOLE VACUUM TESTING IS REQUIRED ON ALL NEW OR REPLACEMENT MANHOLES IN

TRACE WIRE, CONTINUITY TEST AND DETECTABLE TAPE REQUIRED PER APPLICABLE PVSD.

PVC SEWER PIPE AND FITTINGS SHALL BE INSTALLED PURSUANT TO ASTM STANDARDS.

SEWER MANHOLE CONSTRUCTION SHALL BE IN ACCORDANCE PER APPLICABLE PVSD AND AAC

ALLOWABLE SEWER LINE SAG (SAG) IS SPECIFIED PER TABLE 1 - CORRECTIVE ACTION REQUIREMENTS

OBSERVED SAG

LESS THAN OR EQUAL TO #

LESS THAN OR EQUAL TO 1"

OR EQUAL TO 1 1/2

NO PAVING, ROAD-BASE, COVER, ETC SHALL OCCUR UNTIL SEWER INFRASTRUCTURE MEETS SAG AND

DETERMINE IF THE REQUIRED PROCEDURES AND SUBSEQUENT DOCUMENTATION WERE COMPLIED

EOR SUPPLIED REPORT TO DETERMINE IF THE PRODUCT IS ACCEPTABLE PRIOR TO PROJECT

REVIEW THE DOCUMENTATION AND FINDINGS FOR COMPLIANCE WITH TOWN STANDARDS

GREATER THAN 1" BUT LESS THAN YES IF LONGER THAN 20" OR MORE THAN 6 OCCURRENCES IN

CORRECTIVE ACTION

REQUIRED

NONE

YES

YES

YES IF LONGER THAN 10' OR MORE THAN 3 OCCURRENCES I

SEWER LINE DEFLECTION TESTS SHALL BE DONE ON ALL PVC LINES ACCORDING TO MANUFACTURER'S

SEWER CONSTRUCTION NOTES

REVIEWER (YAVAPAI COUNTY).

ACCORDANCE PER APPLICABLE PVSD.

APPLICABLE PVSDS FOR GUIDANCE.

ACCORDANCE WITH APPLICABLE PVSD.

DEFLECTION TESTS -

631.11 MANHOLE CONSTRUCTION -

DESCRIPTION

8" TO 12" DIA, PIPE

8" TO 12" DIA, PIPE

12" TO 24" DIA. PIPE

GREATER THAN 24" DIA. PIPE

PIPE ENTERING OR EXITING MANHOLE

AGREED ON BEFORE WORK CONTINUES.

631.17 MANHOLE TAPS -

631.18 ROACH CONTROL -

601.13 POLYWRAP -

631.12 SEWER LINE SAG -

SOCIETY FOR TESTING AND MATERIALS (ASTM) STANDARDS.

DIP MUST BE USED FOR BURY DEPTH GREATER THAN 10 FEET.

TABLE 1 - CORRECTIVE ACTION REQUIREMENTS FOR SAG

INSTALL PÖLYWRAP DIP PIPING AND APPURTENANCES PER MAG.

COPIES OF APPLICABLE DOCUMENTATION FOR REVIEW. THE EOR SHALL

NO SEWER SERVICE TAPS WILL BE ALLOWED INTO A MANHOLE.

VACUUM / LOW PRESSURE AIR TESTING REQUIREMENTS.

631.2 CLEARANCE -

631.4 CROSSINGS

RECOMMENDATIONS.

631.8 BURY DEPTH -

631.9 TRACE WIRE -

GUIDELINES, "MARICOPA ASSOCIATION OF GOVERNMENTS UNIFORM STANDARD" (MAG SPECS), MARICOPA ASSOCIATION OF GOVERNMENTS UNIFORM STANDARD DETAILS FOR PUBLIC WORKS CONSTRUCTION" (MAG DETAILS), AND GENERALLY ACCEPTED GOOD CONSTRUCTION PRACTICES.

THESE CONSTRUCTION PLANS ARE SUBJECT TO THE INTERPRETATION OF INTENT BY THE ENGINEER. ALL QUESTIONS REGARDING THESE PLANS SHALL BE DIRECTED TO THE ENGINEER. ANY INTERPRETATION OF THE PLANS BY ANYONE OTHER THAN THE ENGINEER SHALL BE RESPONSIBLE FOR ANY CONSEQUENCES THEREOF.

ALL MATERIALS AND WORKMANSHIP SHALL COMPLY WITH TOWN OF PRESCOTT VALLEY DESIGN

IF TWO OR MORE GIVEN SPECIFICATIONS DIFFER IN CONTENT, THE MORE RESTRICTIVE OR STRINGENT SPECIFICATION, IN THE OPINION OF THE PROJECT ENGINEER WILL GOVERN.

THE OWNER AND/OR CONTRACTOR SHALL NOTIFY THE ENGINEER OF ANY VARIANCES BETWEEN THESE PLANS AND ACTUAL FIELD CONDITIONS.

ANY LOCATIONS, ELEVATIONS, CROSS SLOPES, OR CONDITIONS DIFFER FROM WHAT IS SHOWN ON THE PLANS, THE CONTRACTOR SHALL CONTACT THE OWNERS AGENT IMMEDIATELY FOR APPROPRIATE CORRECTIVE ACTION, THE CONTRACTOR IS RESPONSIBLE FOR ANY COSTS INCURRED IF THIS PROCEDURE IS NOT FOLLOWED.

THE CONTRACTOR IS RESPONSIBLE TO OBTAIN COPIES OF TOPY AND MAG/YAG STANDARDS, AS WELL AS ALL OTHER STANDARDS AND SPECIFICATIONS WHICH MAY BE NECESSARY TO COMPLETELY AND

THE ENGINEER MAY ORDER ANY OR ALL WORKMANSHIP AND MATERIALS USED FOR THIS PROJECT TO BE TESTED ACCORDING TO APPLICABLE STANDARDS. THE CONTRACTOR SHALL SUPPLY ALL SAMPLES

THE CONTRACTOR MAY SUBMIT CAREFULLY DOCUMENTED AND CONSIDERED WRITTEN PROPOSALS FOR ALTERNATE MATERIALS AND CONSTRUCTION METHODS. THOSE PROPOSALS THAT ARE FOUND TO BE IN CONFORMITY WITH GOOD ENGINEERING DESIGN AND CAN BE EASILY MAINTAINED BY JURISDICTIONAL FORCES MAY BE GIVEN WRITTEN APPROVAL FOR INCORPORATION IN THE CONSTRUCTION PLANS IF

ANY WORK PERFORMED WITHOUT THE KNOWLEDGE AND APPROVAL OF THE ENGINEER OR HIS AUTHORIZED REPRESENTATIVE AND/OR ALL WORK AND MATERIALS NOT IN CONFORMANCE WITH THE SPECIFICATIONS IS SUBJECT TO REMOVAL AND REPLACEMENT AT THE CONTRACTOR'S EXPENSE.

THE ENGINEER OR HIS AUTHORIZED REPRESENTATIVE MAY SUSPEND THE WORK BY WRITTEN NOTICE WHEN, IN HIS JUDGMENT, PROGRESS IS UNSATISFACTORY, IMPROPER WORKMANSHIP IS BEING PERFORMED, WORK BEING DONE IS UNAUTHORIZED OR DEFECTIVE, WEATHER CONDITIONS ARE UNSUITABLE, OR THERE IS DANGER TO THE PUBLIC HEALTH OR SAFETY.

ALL IMPROVEMENTS SHALL BE CONSTRUCTED BY CONTRACTOR(S) THAT ARE LICENSED BY THE ARIZONA STATE REGISTRAR OF CONTRACTORS, WITH A CLASS OF LICENSE(S) FOR THE SPECIFIC WORK

REGULATIONS APPLICABLE TO THE CONSTRUCTION OF THIS PROJECT. THE CONTRACTOR IS RESPONSIBLE FOR ALL CONSTRUCTION METHODS, SEQUENCING, AND SAFETY

WITH ALL APPLICABLE O.S.H.A. REGULATIONS.

THE CONTRACTOR AND ANY SUBCONTRACTORS SHALL HAVE A COMPLETE AND CURRENT SET OF PLANS ON-SITE AT ALL TIMES. IT IS THE RESPONSIBILITY OF THE GENERAL CONTRACTOR TO SUPPLY ANY SUBCONTRACTORS WITH THESE PLANS.

CONSTRUCTION OPERATION AT HIS OWN EXPENSE. IT IS THE SOLE RESPONSIBILITY OF THE CONTRACTOR TO OBTAIN, AT HIS OWN EXPENSE, SUCH PERMITS AS ARE REQUIRED FROM THE APPROPRIATE AGENCIES.

THE CONTRACTOR SHALL WARRANT ALL WORK FOR A MINIMUM OF A TWO YEAR PERIOD BEGINNING AFTER FINAL ACCEPTANCE IS GIVEN BY THE ENGINEER. ANY DEFECTS WHICH APPEAR IN THE WORK WITHIN TWO YEARS FROM THE DATE OF ACCEPTANCE AND WHICH ARE DUE TO IMPROPER WORKMANSHIP OR INFERIOR MATERIALS SUPPLIED SHALL BE CORRECTED BY OR AT THE EXPENSE OF

THE CONTRACTOR SHALL GUARD AGAINST DAMAGE DURING CONSTRUCTION TO EXISTING PROPERTIE AND IMPROVEMENTS. ANY ITEMS DAMAGED BY THE CONSTRUCTION SHALL BE REPLACED IN KIND

THE CONTRACTOR SHALL MAINTAIN A COMPLETE SET OF AS—BUILT PLANS ON SITE FOR REFERENCE AT ALL TIMES. THE AS—BUILT PLANS WILL BE FURNISHED BY THE CONTRACTOR TO THE ENGINEER AT THE COMPLETION OF THE PROJECT FOR RECORD. THE AS—BUILT PLANS MUST BE UPDATED DAILY BY THE CONTRACTOR AND INCLUDE, IN ADDITION TO THE PLANNED CONSTRUCTION, ANY CHANGES AUTHORIZED BY THE ENGINEER AND ANY UTILITIES DISCOVERED DURING THE TRENCHING OPERATIONS

APPROVAL OF A PORTION OF THE WORK IN PROGRESS DOES NOT GUARANTEE ITS FINAL ACCEPTANCE. TESTING AND EVALUATION MAY CONTINUE UNTIL WRITTEN FINAL ACCEPTANCE OF A COMPLETE WORKABLE UNIT. ACCEPTANCE OF COMPLETED IMPROVEMENTS WILL NOT BE GIVEN UNTIL DEFECTIVE OR UNAUTHORIZED WORK IS REMOVED AND FINAL CLEAN—UP IS COMPLETE. PRIOR TO FINAL ACCEPTANCE, THE CONTRACTOR SHALL BE RESPONSIBLE FOR CLEANING AND TV INSPECTION OF SEWER INFRASTRUCTURE PER APPLICABLE PVSD. THE TOWN AND EOR SHALL RECEIVE

THESE PLANS REPRESENT A REASONABLE EFFORT TO SHOW LOCATIONS OF EXISTING UNDERGROUND UTILITIES WITHIN THE PROJECT LIMITS. THE CONTRACTOR IS RESPONSIBLE FOR ANY DAMAGE TO UTILITIES CAUSED DURING CONSTRUCTION. THE CONTRACTOR IS TO VERIFY THE LOCATION AND THE ELEVATIONS OF ALL EXISTING UTILITIES PRIOR TO ANY EXCAVATION OR CONSTRUCTION, SHOULD ANY LOCATION OR ELEVATION DIFFER FROM THAT SHOWN ON PLANS, THE CONTRACTOR IS RESPONSIBLE IF GROUNDWATER OR OTHER UNSUITABLE CONDITIONS ARE ENCOUNTERED DURING CONSTRUCTION, THE EOR AND THE TOWN MUST BE NOTIFIED AND A RESOLUTION ACCEPTABLE TO ALL PARTIES MUST BE

LOCATION OF UNDERGROUND UTILITIES SHALL BE ACCOMPLISHED IN ACCORDANCE WITH ARS 40-360.22 PRIOR TO ANY EXCAVATION. CONTRACTOR PERFORMING EXCAVATING OPERATIONS IS RESPONSIBLE FOR LOCATING AND PROTECTING ALL UNDERGROUND UTILITIES. BLUE STAKE SHALL B CALLED AT 1-800-STAKE-IT FOR ACCURATE LOCATION OF UTILITIES AS NECESSARY AND PRIOR TO ACCURATE LOCATION OF UTILITIES AS NECESSARY AND ACCURATE LOCATION DE ACC

ALL FILL MATERIAL SHALL BE COMPACTED TO 95% STD. PROCTOR AND DENSITIES SHALL BE TESTED IN ACCORDANCE WITH M.A.G. SPECIFICATIONS.

A. TESTING OF MATERIALS AND CONSTRUCTION PERFORMANCE BY AN APPROVED TESTING LAB IS REQUIRED.

MAXIMUM LIFT THICKNESSES IN FILL SECTIONS SHALL NOT EXCEED 12" PREPARATION OF GROUND: THE AREA OVER WHICH FILLS ARE TO BE MADE SHALL BE CLEARED OF ALL TRASH, TREES, STUMPS, DEBRIS OR OTHER MATERIAL NOT SUITABLE AS A FOUNDATION FOR FILL. DISTURBED AREA SHALL BE RE-VEGETATED WITH PLANTS AND LANDSCAPING PER PROPERTY

THE CONTRACTOR SHALL MAINTAIN POSITIVE DRAINAGE AWAY FROM THE BUILDING DURING ALL PHASES OF CONSTRUCTION.

PONDING OF SURFACE WATER SHALL NOT BE PERMITTED DURING CONSTRUCTION OR BE PRESENT AFTER FINAL LOT GRADING.

FINISHED GRADE DIRECTLY ADJACENT TO THE BUILDING SHALL BE A MINIMUM OF 6" BELOW THE FINISHED FLOOR ELEVATION AND SHALL SLOPE AWAY FROM THE BUILDING AT 5% FOR A MINIMUM DISTANCE OF 10' TO AN APPROVED WATER DISPOSAL AREA.

REVISIONS

These drawings are the property of

W. Alan Kenson & Associates P.C and may not be reproduced in any way without the written consent of W ■ Kenson & Associates, P.C

EXPIRES: 6/30

ΑZ

DRAWN F L.O. CHECKED F W.A.K. May 9, 2017

INSTALL POLYWRAP DIP PIPING AND APPURTENANCES PER MAG STANDARDS.

ALL NEW, REPLACEMENT OR REFURBISHED MANHOLES SHALL BE COATED WITH INSECTA @CONTACT PESTICIDE, OR APPROVED EQUAL, PER PESTICIDE MANUFACTURER'S INSTRUCTIONS.

NEW OR REPLACEMENT MANHOLES AND APPURTENANCES SHALL BE CONSTRUCTED WITH CONMICSHIELD®, A LIQUID ANTIBACTERIAL ADDITIVE IF INFRASTRUCTURE: 1) IS WITHIN 4,000 FEET OF FORCE MAIN DISCHARGE, 2) MANHOLES HAVE PIPE DIAMETERS OF 18 INCHES AND GREATER, 3) MANHOLE IS LOCATED ON A SMALLER TRIBUTARY LINE THAT IS WITHIN 200 FEET OF A MANHOLE WITH A PIPE DIAMETER OF 18 INCHES AND GREATER, 4) A MANHOLE RECEIVING FLOW FROM A SEWER LINE THAT HAS A SLOPE OF 10% OR GREATER, AND 5) IS SUBJECT TO, IN THE OPINION OF THE TOWN, OF CREATING UNACCEPTABLE AMOUNTS OF HYDROGEN SULFIDE GAS. SPECIFICS

CONCERNING CONMICSHIELD® ARE NOTED PER APPLICABLE PVSD. ADDITIONAL NOTES

WATER - VALVES

MAG DETAIL. HANDLES SHALL BE COLORED BASED ON AWWA CODE. 2. VALVES SHALL BE MUELLER 2360 SERIES RESILIENT WEDGE GATE VALVE, CLOW RESILIENT WEDGE GATE VALVE SERIES 2639-2640 OR AMERICAN FLOW CONTROL SERIES 2500 RESILIENT WEDGE GATE VALVE OR AN APPROVED EQUAL. VALVES SHALL BEX: NEW, GATE TYPE, BONDED RESILIENT SEAT, NON-RISING STEM, MECHANICAL JOINT, FUSE BONDED EPOXY COATED INSIDE

VALVE BOXES SHALL COMPLY PER APPLICABLE PVSD AND BE FITTED WITH A DEBRIS CAP PER

AND OUT, 2 INCH OPERATING NUT AND OPEN COUNTER-CLOCKWISE.

ALL WATER METER BOXES NOT SURROUNDED BY OR IMMEDIATELY ADJACENT TO PAVED SURFACE OR CURB SHALL BE AT LEAST 3 INCHES ABOVE ANY FINISHED GRADE WITHIN 3 FEET OF THE BOX. BOXES IMMEDIATELY ADJACENT TO PAVED SURFACES OR CURBS SHALL BE THE SAME HEIGHT AS THE ADJACENT PAVEMENT OR CURB.

. SERVICE LINES SHALL HAVE A SEPARATE TAP TO THE MAIN AND BE IN ACCORDANCE WITH THE APPLICABLE MAG.

SERVICE TAPS AND SERVICE LINES ON NEW CONSTRUCTION SHALL UTILIZE MANUFACTURED FITTINGS; NO SADDLES ALLOWED.

FOR SERVICE LINES INSTALLED ON EXISTING MAINS, THE DRILLED HOLE SHALL HAVE SMOOTH ROUNDED EDGES AND BE THE SAME SIZE AS THE SERVICE CONNECTION SUCH THAT NO LEDGE OR PROTRUSIONS CATCH WASTEWATER, ALL TAPS SHALL BE INSPECTED BY THE TOWN PRIOR TO FINAL

PERMANENT ATTACHMENT OF THE SADDLE.

SEWER - SERVICE TAPS AND SERVICE LINES

SERVICE LINES MUST INCLUDE ELECTRONIC BALL MARKERS PER MAG AND DETECTABLE TAPE PER

THE CONTRACTOR SHALL VERIFY THE LOCATION, ELEVATION AND GENERAL CONDITION OF ALL EXISTING TIE-IN AND MATCHING POINTS OF PAVEMENT PRIOR TO ANY STREET CONSTRUCTION. SHOULD

ACCURATELY INTERPRET THESE PLANS.

FOR THE TESTING AND CERTIFICATES OR RESULTS OF TESTING AT HIS EXPENSE.

THEY ARE FOUND TO BE IN THE BEST PUBLIC INTEREST.

THE CONTRACTOR IS REQUIRED TO COMPLY WITH ALL LOCAL, STATE, AND FEDERAL LAWS AND

THE GENERAL CONTRACTOR AND ANY SUBCONTRACTORS PERFORMING WORK SHOWN ON THESE PLANS SHALL CONDUCT THEIR OPERATIONS SO THAT ALL EMPLOYEES ARE PROVIDED A SAFE PLACE TO WORK AND THE PUBLIC IS PROTECTED. ALL CONTRACTORS AND SUBCONTRACTORS SHALL COMPLY

THE CONTRACTOR SHALL MAKE ARRANGEMENTS FOR AND PROVIDE ALL NECESSARY WATER FOR HIS

BY SIZE, LOCATION, AND TYPE REDLINED ONTO THE PLANS BY STATION/DISTANCE/DEPTH.

ALL MATERIALS SHALL BE INSTALLED PER MANUFACTURER'S GUIDELINES. QUANTITIES OF CONSTRUCTION MATERIALS ARE PROVIDED AS A GUIDE AND FOR INFORMATION ONLY. THE CONTRACTOR IS RESPONSIBLE FOR DETERMINING AND PROVIDING ALL QUANTITIES REQUIRED. SUBMIT A REPORT TO THE TOWN WITH REGARD TO DISPOSITION. THE TOWN WILL REVIEW THE

FOR CONTACTING THE PROPER UTILITY OWNER'S AGENT.


SIGNS, TREES SHRUBS, MAILBOXES AND OTHER INCIDENTALS REQUIRING RELOCATION SHALL BE MOVED ONLY FAR ENOUGH TO ALLOW CONSTRUCTION OF THE PROJECT AND CAUSE THE LEAST DISRUPTION TO PRIVATE PROPERTY, AND LANDSCAPE. FINAL POSITIONS SHALL BE APPROVED BY THE ENGINEER PRIOR TO RELOCATION. ALL RELOCATED ITEMS SHALL CONTINUE TO WORK IN THEIR INTENDED CAPACITY AFTER THE RELOCATION HAS BEEN ACCOMPLISHED. NO SIGNS SHALL BE RELOCATED TO POSITIONS OUTSIDE DESIGNATED RIGHTS—OF—WAY. SAFETY SHALL BE A PRIMARY CONSIDERATION IN THE PLACEMENT OF SHRUBBERY AND SIGNS WHICH COULD POSSIBLY DISRUPT THE SIGHT DISTANCE

EARTHWORK QUANTITIES ARE BASED ON FINISHED GRADES AND DO NOT ACCOUNT FOR SHRINK/SWELL, BUILDING SLAB THICKNESS, WALLS, FOOTINGS, ETC.

THE GEOTECHNICAL ENGINEER WILL DETERMINE THE NUMBER AND TYPE OF TESTS

ALL ROOF DRAINAGE SHALL BE DIRECTED AWAY FROM THE BUILDING. ROOF DRAINS SHALL DISCHARGE A MINIMUM OF 10' AWAY FROM BUILDING STRUCTURE.

699 SHEET

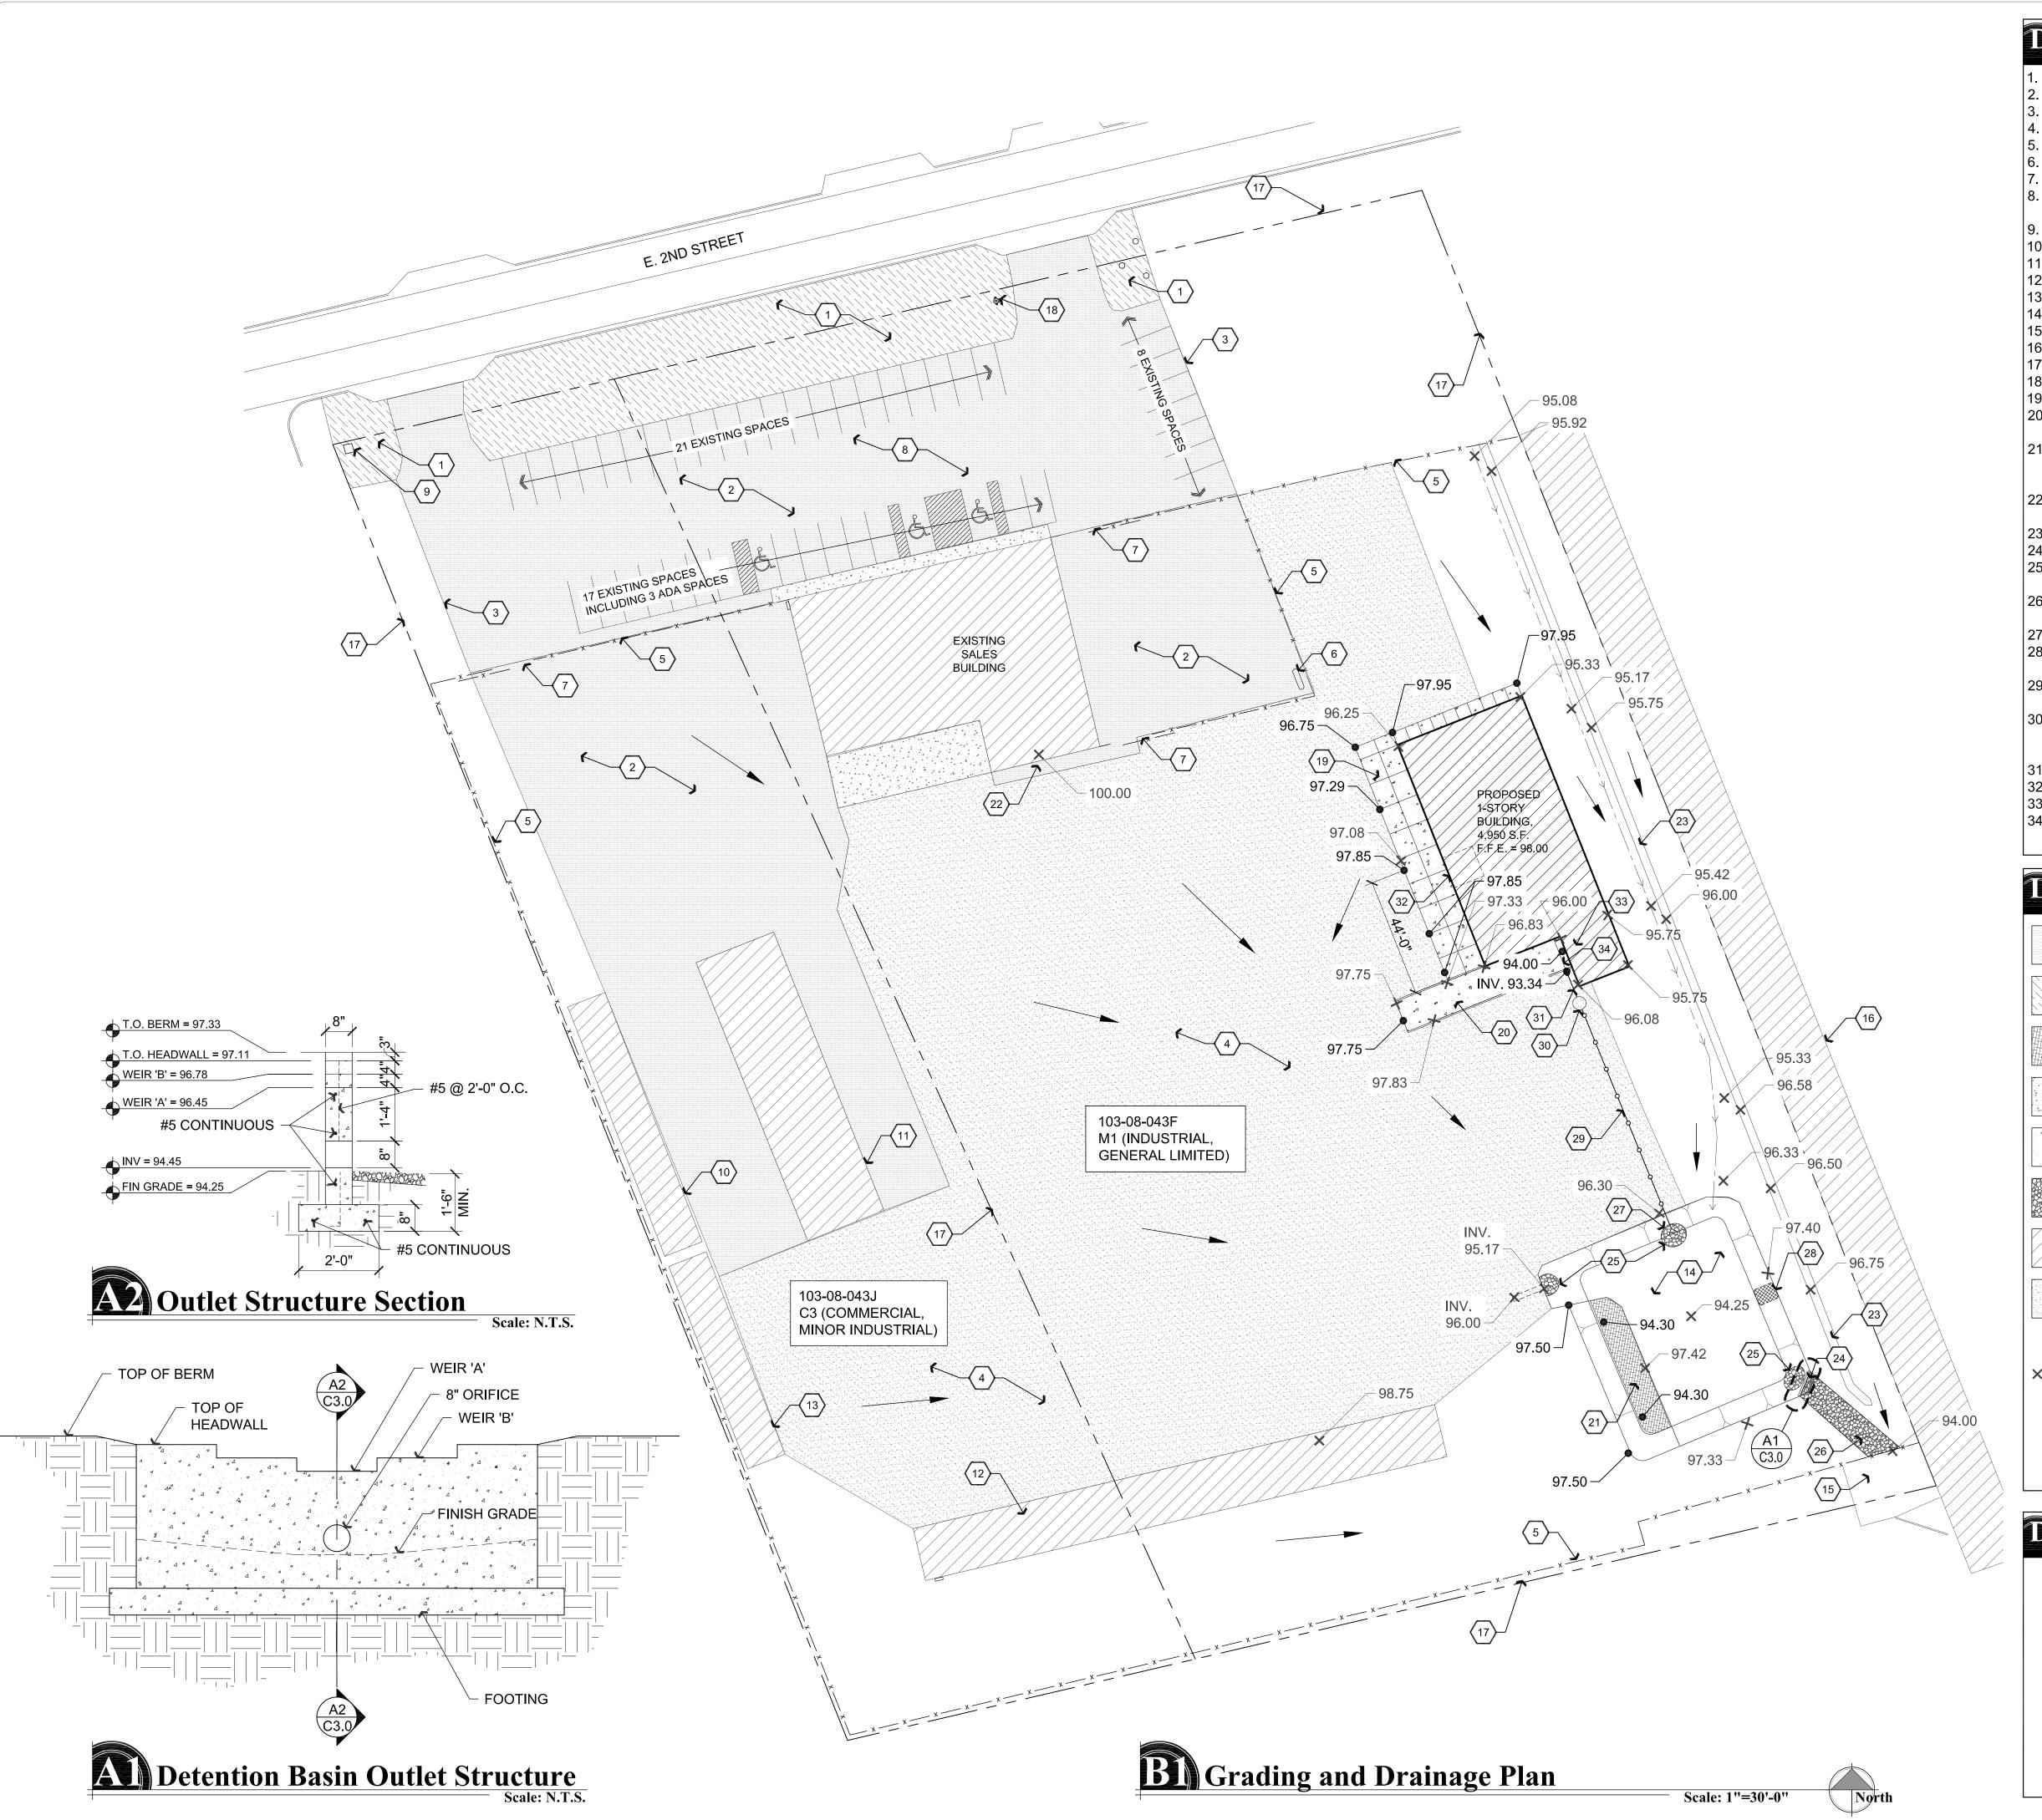

Discriptive Keynotes \bigcirc

1. EXISTING LANDSCAPING.

EXISTING LANDSCAPING.
 EXISTING ASPHALTIC PAVEMENT.

. EDGE OF PAVEMENT.

4. EXISTING ABC.

5. EXISTING CHAIN LINK FENCE.

EXISTING PROPANE TANK. EXISTING SLIDING GATE.

8. EXISTING PARKING LOT WITH 43 PARKING SPACES AND 3 HANDICAP ACCESSIBLE SPACES.

EXISTING TRANSFORMER.

10. EXISTING 1,500 S.F 1-STORY, COVERED STORAGE AREA.11. EXISTING 3,465 S.F 1-STORY COVERED STORAGE AREA.

12. EXISTING 4,005 S.F. 1-STORY, COVERED STORAGE AREA 13. EXISTING 1222 S.F.1-STORY, COVERED STORAGE AREA.

14. EXISTING DETENTION BASIN.

15. EXISTING RIP RAP W/ DRAINAGE CHANNEL

16. EXISTING BUILDING.

17. PROPERTY LINE.18. EXISTING FIRE HYDRANT.

19. PROPOSE CONCRETE SLAB.

19. PROPOSE CONCRETE SLAB.20. PROPOSED CONCRETE TRUCK RAMP, MAXIMUM

SLOPE 6%.
21. EXPAND EXISTING DRAINAGE DETENTION BASIN TO SIZE

SHOWN, ADDING AN ADDITIONAL ±600 S.F.
MATCH EXISTING DEPTH.

22. PROJECT BENCHMARK IS FINISH FLOOR OF EXISTING SALES BUILDING.

23. TOP OF BERM.

24. REMOVE PORTION OF EXISTING BERM AS REQUIRED.

25. PROVIDE 40 S.F. RIP RAP SPLASH PAD. d50 = 4"/DEPTH = 8"
 OVER FILTER FABRIC.
 26. PROVIDE RIP RAP DRAINAGE SWALE. d50 = 4"/DEPTH = 8"

OVER FILTER FABRIC.

27. INVERT OF FORCE MAIN AT EMBANKMENT TO BE ±95.00.

28. REPAIR PORTION OF EXISTING BERM TO MATCH

ADJACENT BERM.

29. 2" SCHEDULE 40 PVC FORCE MAIN, REFER TO PLUMBING

30. BELOW GRADE STORM WATER EJECTION PUMP WITH TRAFFIC RATED COVER FOR TRUCK RAMP DRAIN, REFER TO PLUMBING PLANS.

31. 4" SDR 35 DRAIN PIPE, REFER TO PLUMBING PLANS.

32. OVERHEAD DOOR, REFER TO ARCHITECTURAL PLANS.
33. LOADING DOCK, REFER TO ARCHITECTURAL PLANS.

34. TRUCK RAMP TROUGH WITH METAL GRATE AT LOADING DOCK, REFER TO PLUMBING PLANS.

Degend

TYPICALLY INDICATES EXISTING ASPHALTIC PAVEMENT

TYPICALLY INDICATES EXISTING LANDSCAPED AREA

TYPICALLY INDICATES PROPOSED

ADDITIONAL DETENTION AREA

TYPICALLY INDICATES
EXISTING CONCRETE

TYPICALLY INDICATES
PROPOSED CONCRETE

TYPICALLY INDICATES PROPOSED RIP RAP

TYPICALLY INDICATES

EXISTING BUILDING

TYPICALLY INDICATES

EXISTING ABC

TYPICALLY INDICATES
EXISTING SPOT ELEVATION

94.00 TYPICALLY INDICATES PROPOSED SPOT ELEVATION

TYPICALLY INDICATES DRAINAGE FLOW DIRECTION

Detention Basin Calculation

69,404 SF EXISTING IMPERVIOUS AREA 5,040 SF EXISTING DETENTION AREA 7,310 SF NEW IMPERVIOUS AREA 76,714 SF TOTAL NEW AND EXISTING IMPERVIOUS AREA

 $\frac{69,404 \text{ SF}}{76,714 \text{ SF}} = \frac{5,040 \text{ SF}}{X}$

X = 5,571 SF (TOTAL NEW DETENTION REQUIRED) 5,571 SF - 5,040 SF = 531 SF (ADDITIONAL AREA NEEDED)

TOTAL ADDED: 600 S.F.

D. Box 11593
escott, AZ 86304

REVISIONS

These drawings are the property of

W. Alan Kenson & Associates P.C.

and may not be reproduced in any

way without the written consent of

P 928-443-5812 F 928-443-5815 email: waka6

> ilders FirstSource 01 E. 2nd St. escott Valley, AZ 86314

PROJECT:


DRAWN BY
L.O.

CHECKED BY
W.A.K.

DATE
May 9, 2017

JOB NO.
699

C3.0

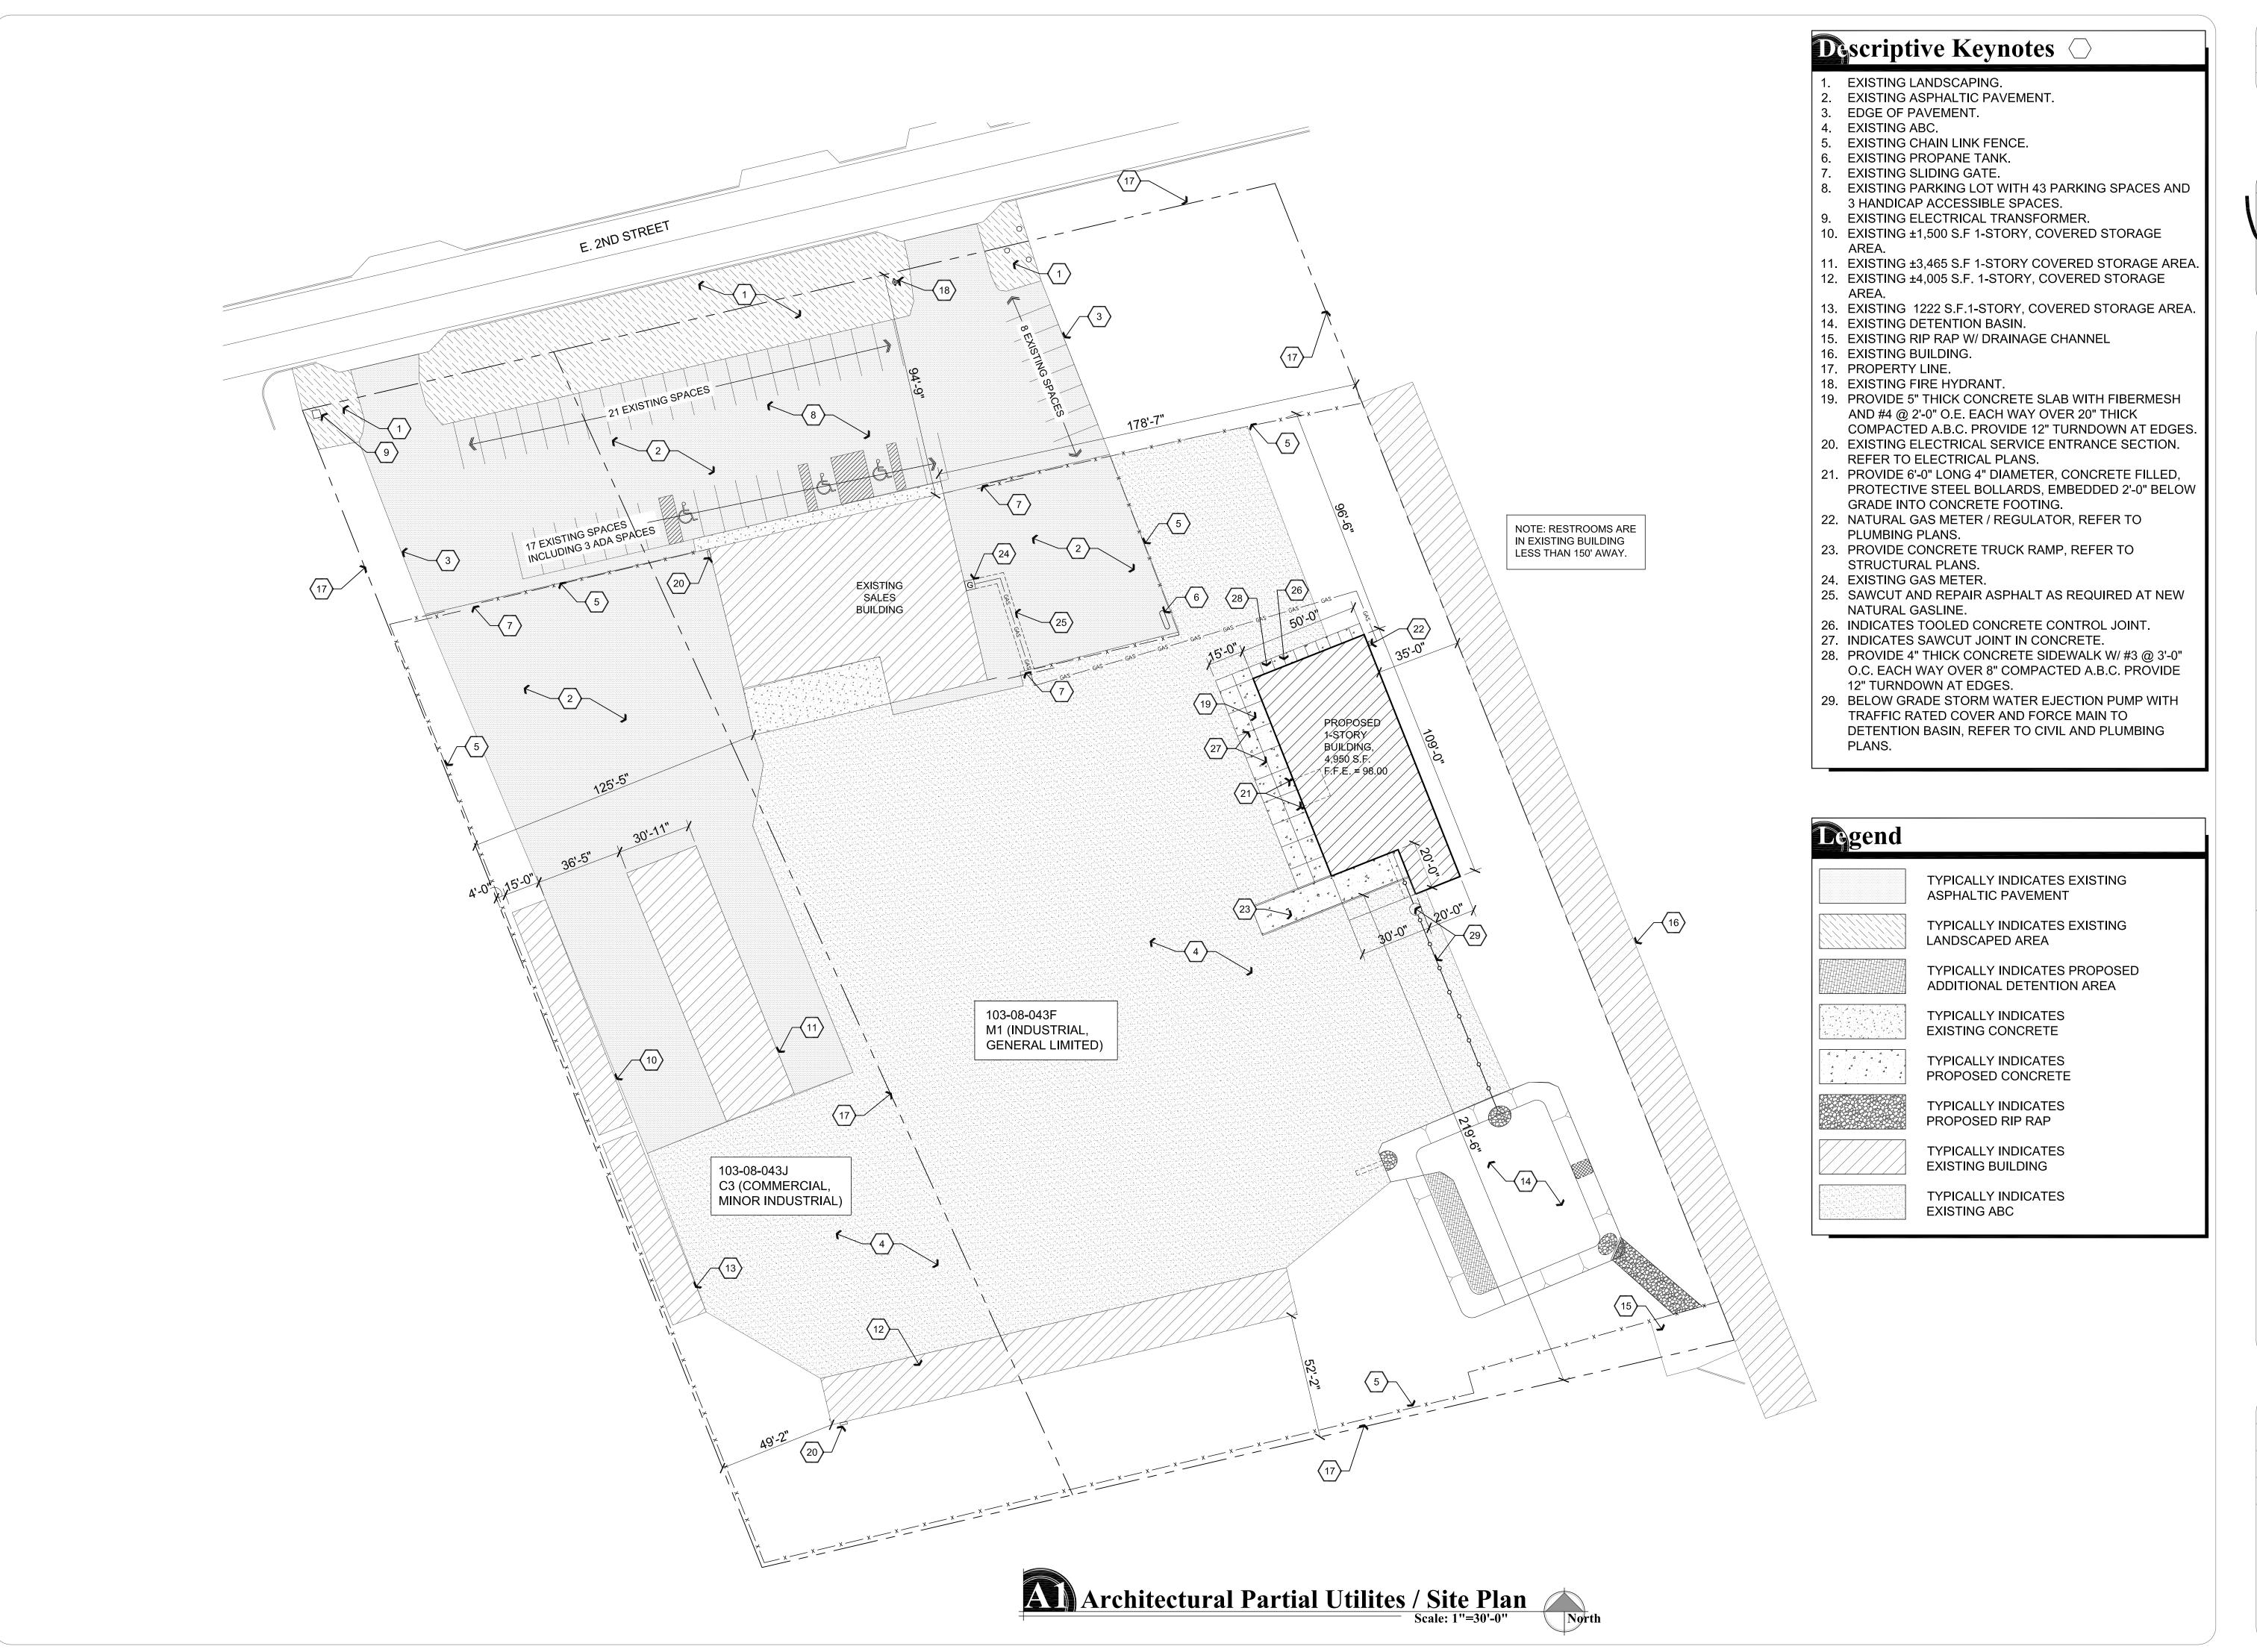


REVISIONS

These drawings are the property of W. Alan Kenson & Associates P.C., and may not be reproduced in any way without the written consent of

DRAWN BY L.O.

CHECKED BY W.A.K. May 9, 2017 JOB NO. **699**

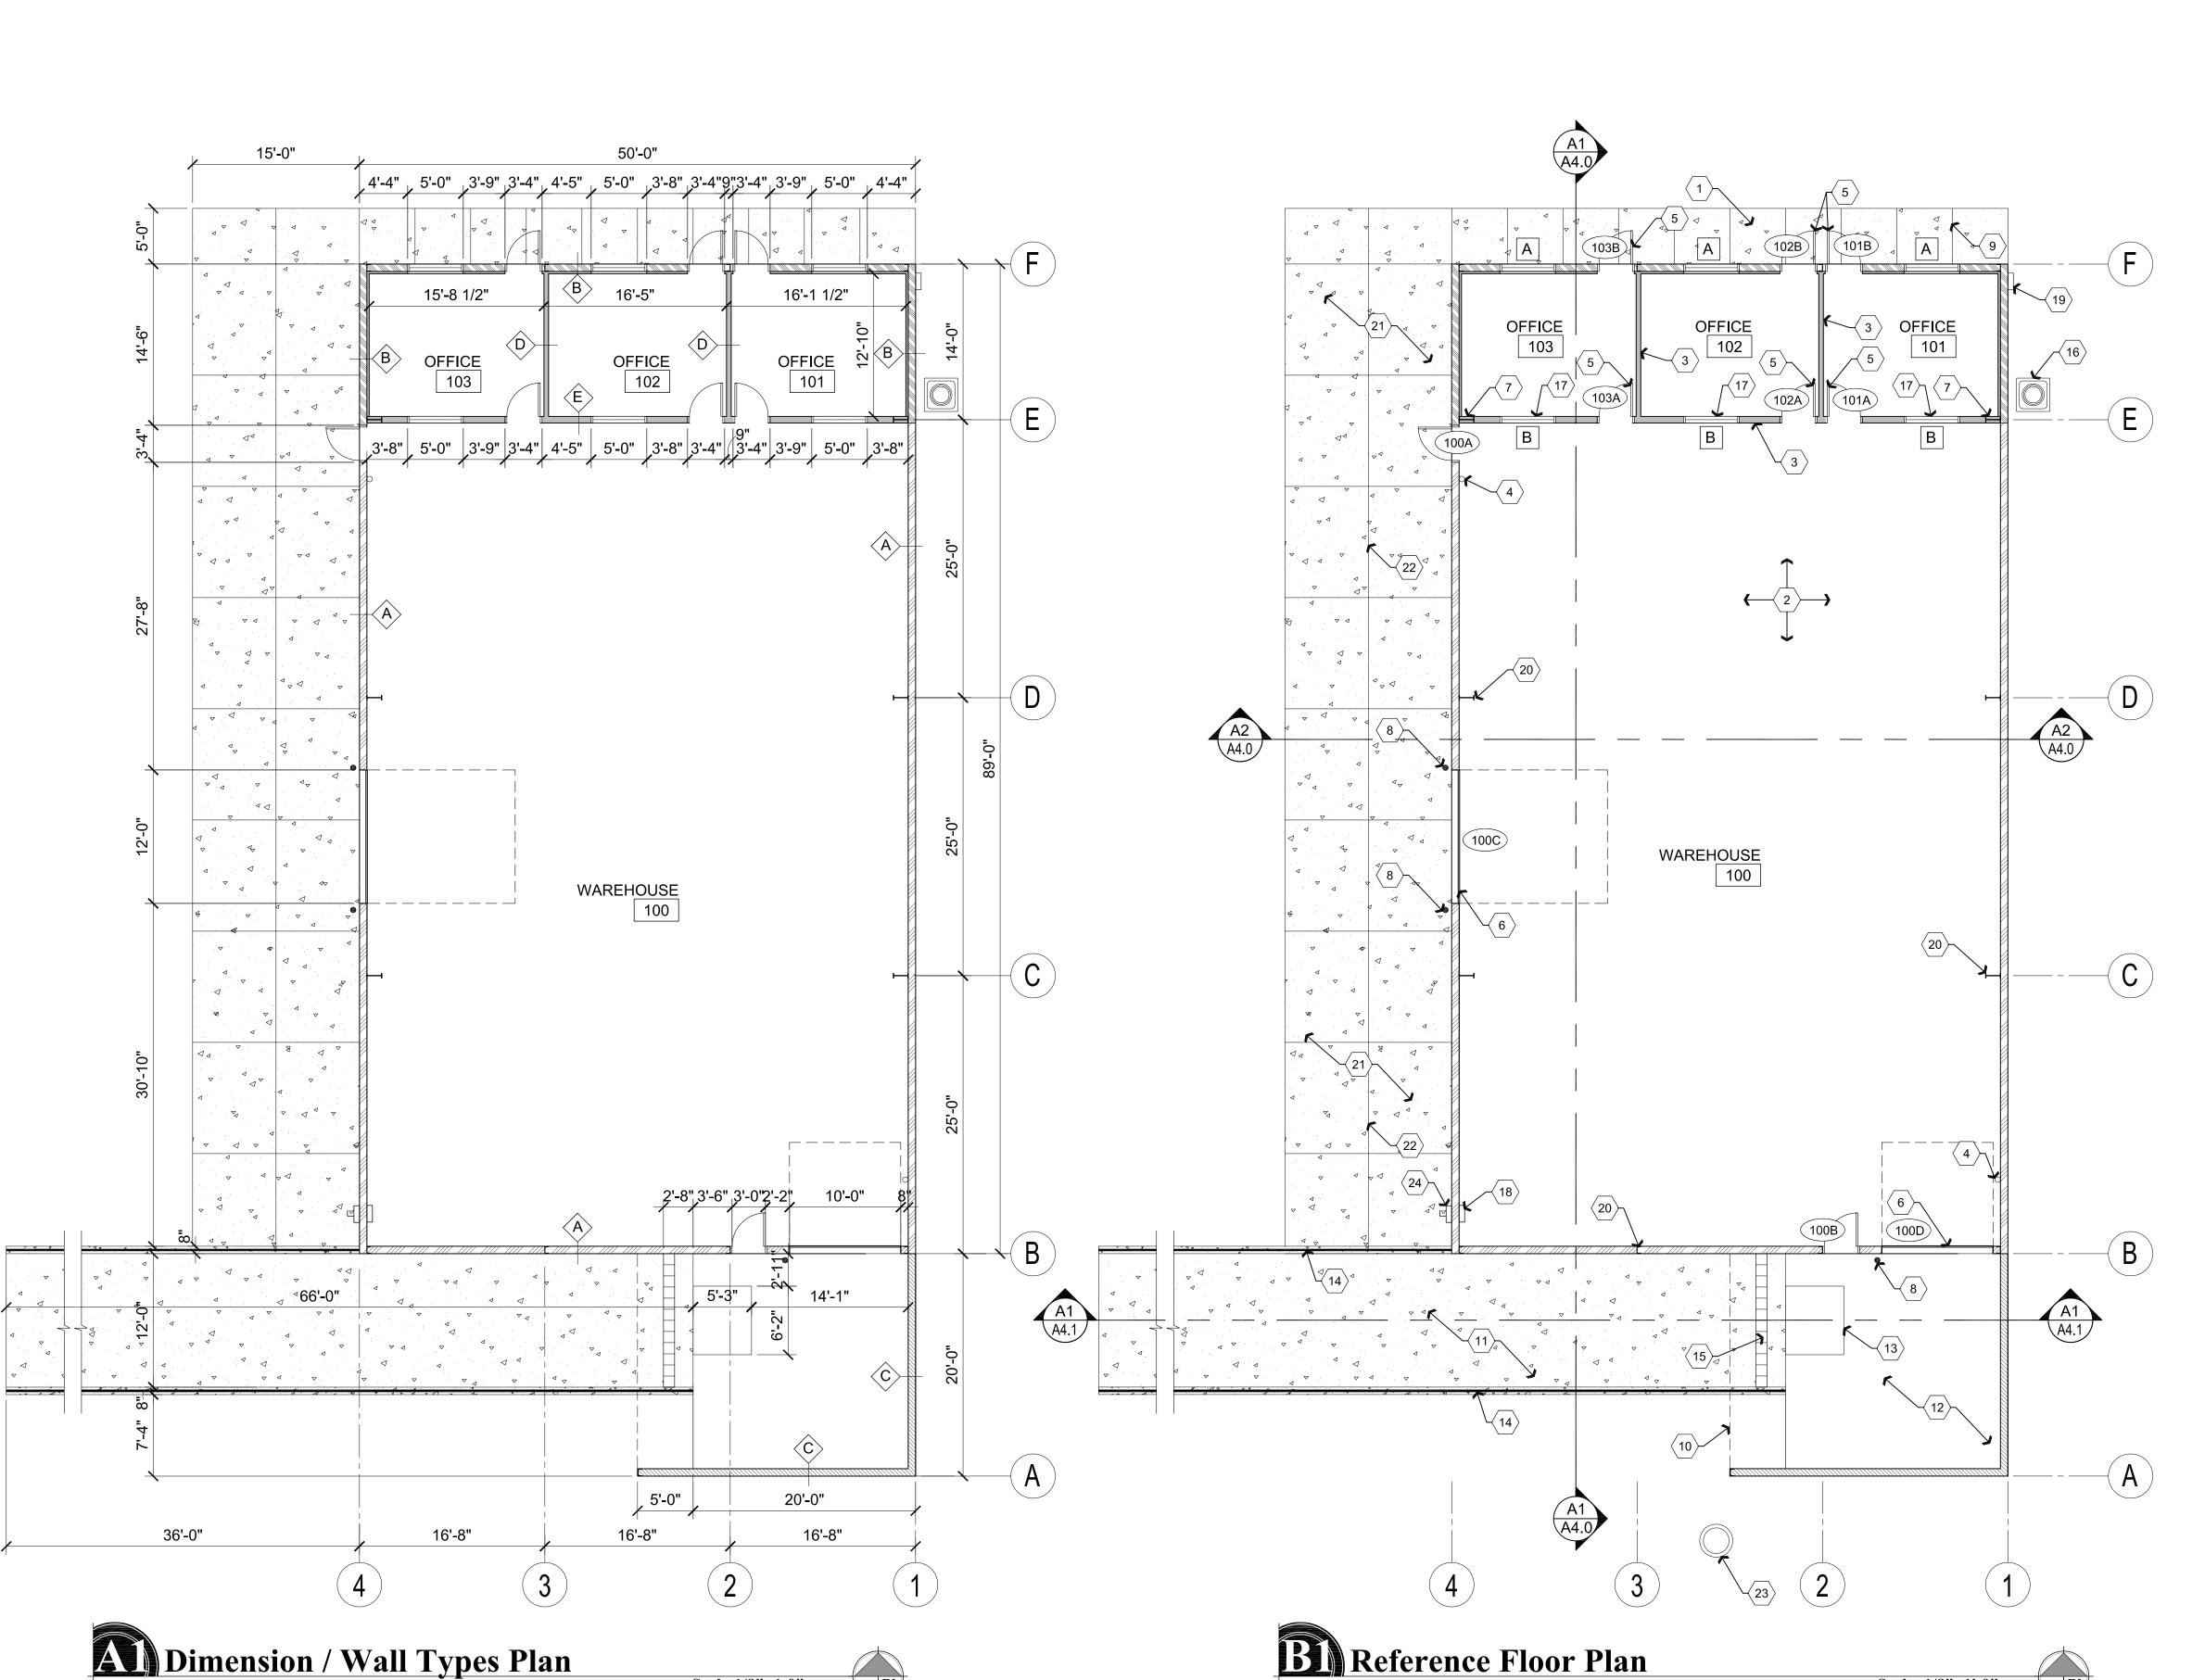

Scale:1/8"=1-0"

Descriptive Keynotes

1. PROVIDE CONCRETE SIDEWALK OVER

COMPACTED A.B.C., REFER TO SITE PLAN. 2. PROVIDE 5" CONCRETE SLAB WITH FIBERMESH AND #4 REBAR @ 2'-0" O.C. EACH WAY OVER COMPACTED A.B.C. REFER TO STRUCTURAL PLANS. SAWCUT SLAB AT APPROXIMATELY 12'-0" O.C. EACH

3. PROVIDE INTERIOR WALL, REFER TO WALL TYPES LEGEND FOR TYPE OF CONSTRUCTION.

4. PROVIDE SURFACE MOUNTED TYPE 2A10BC FIRE EXTINGUISHER.

5. PROVIDE DOOR, REFER TO DOOR SCHEDULE. (TYPICAL)

6. PROVIDE SECTIONAL OVERHEAD DOOR, REFER TO DOOR SCHEDULE. (TYPICAL)

7. PROVIDE STEEL COLUMN WITHIN GPDW PARTITION. REFER TO STRUCTURAL PLANS. (TYPICAL) 8. PROVIDE 6'-0" LONG 4" DIAMETER, CONCRETE

FILLED, PROTECTIVE STEEL BOLLARDS, EMBEDDED 2'-0" BELOW GRADE INTO CONCRETE FOOTING.

9. TYPICALLY INDICATES TOOLED CONCRETE CONTROL JOINT.

10. ROOF LINE ABOVE.

11. PROVIDE CONCRETE SLAB TRUCK RAMP, REFER TO STRUCTURAL PLANS.

12. PROVIDE 5" CONCRETE SLAB DOCK WITH FIBERMESH AND #4 REBAR @ 2'-0" O.C. EACH WAY OVER COMPACTED A.B.C. REFER TO STRUCTURAL

13. PROVIDE DOCK LEVELER. DL-1

14. PROVIDE GUARD RAIL. PT-2

15. PROVIDE STEEL GRATE AND PREFABRICATED TROUGH, REFER TO PLUMBING PLAN.

16. HVAC CONDENSER ON PAD, REFER TO MECHANICAL PLANS.

17. PROVIDE WINDOW, REFER TO WINDOW SCHEDULE.

18. ELECTRICAL PANEL REFER TO ELECTRICAL PLANS. 19. NATURAL GAS METER / REGULATOR, REFER TO

PLUMBING PLANS. 20. STEEL COLUMN, TYPICAL, REFER TO STRUCTURAL

21. CONCRETE SLAB, OVER COMPACTED A.B.C., REFER TO SITE PLAN.

22. INDICATES SAWCUT JOINT IN CONCRETE.

23. BELOW GRADE STORM WATER EJECTION PUMP WITH TRAFFIC RATED COVER AND FORCE MAIN TO DETENTION BASIN, REFER TO CIVIL AND PLUMBING

24. PROVIDE ELECTRICAL DISCONNECT SWITCH, REFER TO ELECTRICAL PLANS.

Wall Types Legend

Scale: 1/8"=1'-0"

A EXTERIOR METAL BUILDING WALL: PROVIDE EXTERIOR METAL BUILDING SIDING 'R' PANELS OVER 8" HORIZONTAL GIRTS BETWEEN STEEL COLUMNS. PROVIDE R-11 VINYL BACKED, METAL BUILDING INSULATION AT INTERIOR W/ 8'-0" HIGH METAL WALL LINER 'R' PANELS.

B EXTERIOR METAL BUILDING WALL: PROVIDE EXTERIOR METAL BUILDING SIDING 'R' PANELS ON EXTERIOR SIDE OVER 8" HORIZONTAL GIRTS BETWEEN STEEL COLUMNS AND 5/8" GPDW ON EXPOSED INTERIOR SIDE OF VERTICAL 2-1/2", 25 GAUGE METAL STUDS AT 2'-0" O.C. UP TO 10'-6" ABOVE FINISH FLOOR . REFER TO STRUCTURAL PLANS. PROVIDE R-11 UNFACED BATT INSULATION UP TO 10'-0" AND R-11 VINYL FACED BLANKET INSULATION FROM FLOOR TO ROOF.

© EXTERIOR METAL BUILDING WALL: PROVIDE EXTERIOR SIDE OVER 8" HORIZONTAL GIRTS BETWEEN STEEL COLUMNS. PROVIDE FULL HEIGHT METAL WALL LINER 'R' PANEL AT INTERIOR SIDE OF WALL.

3-5/8" STUD WALL: PROVIDE 3-5/8" 25 GA. STEEL STUDS AT 2'-0" O.C. WITH 5/8" GPDW EACH SIDE. TOP OF PARTITION TO EXTEND 6" ABOVE CEILING

E> 6" STUD WALL: PROVIDE 6" 20 GA. STEEL STUDS AT 2'-0" O.C. WITH 5/8" GPDW ON EACH SIDE. PROVIDE R-19 UNFACED BATT INSULATION. TOP OF PARTITION TO EXTEND TO STRUCTURE.


REVISIONS

These drawings are the property of W. Alan Kenson & Associates P.C.

and may not be reproduced in any

way without the written consent of

DRAWN BY L.O. CHECKED BY W.A.K. May 9, 2017 JOB NO. **699**

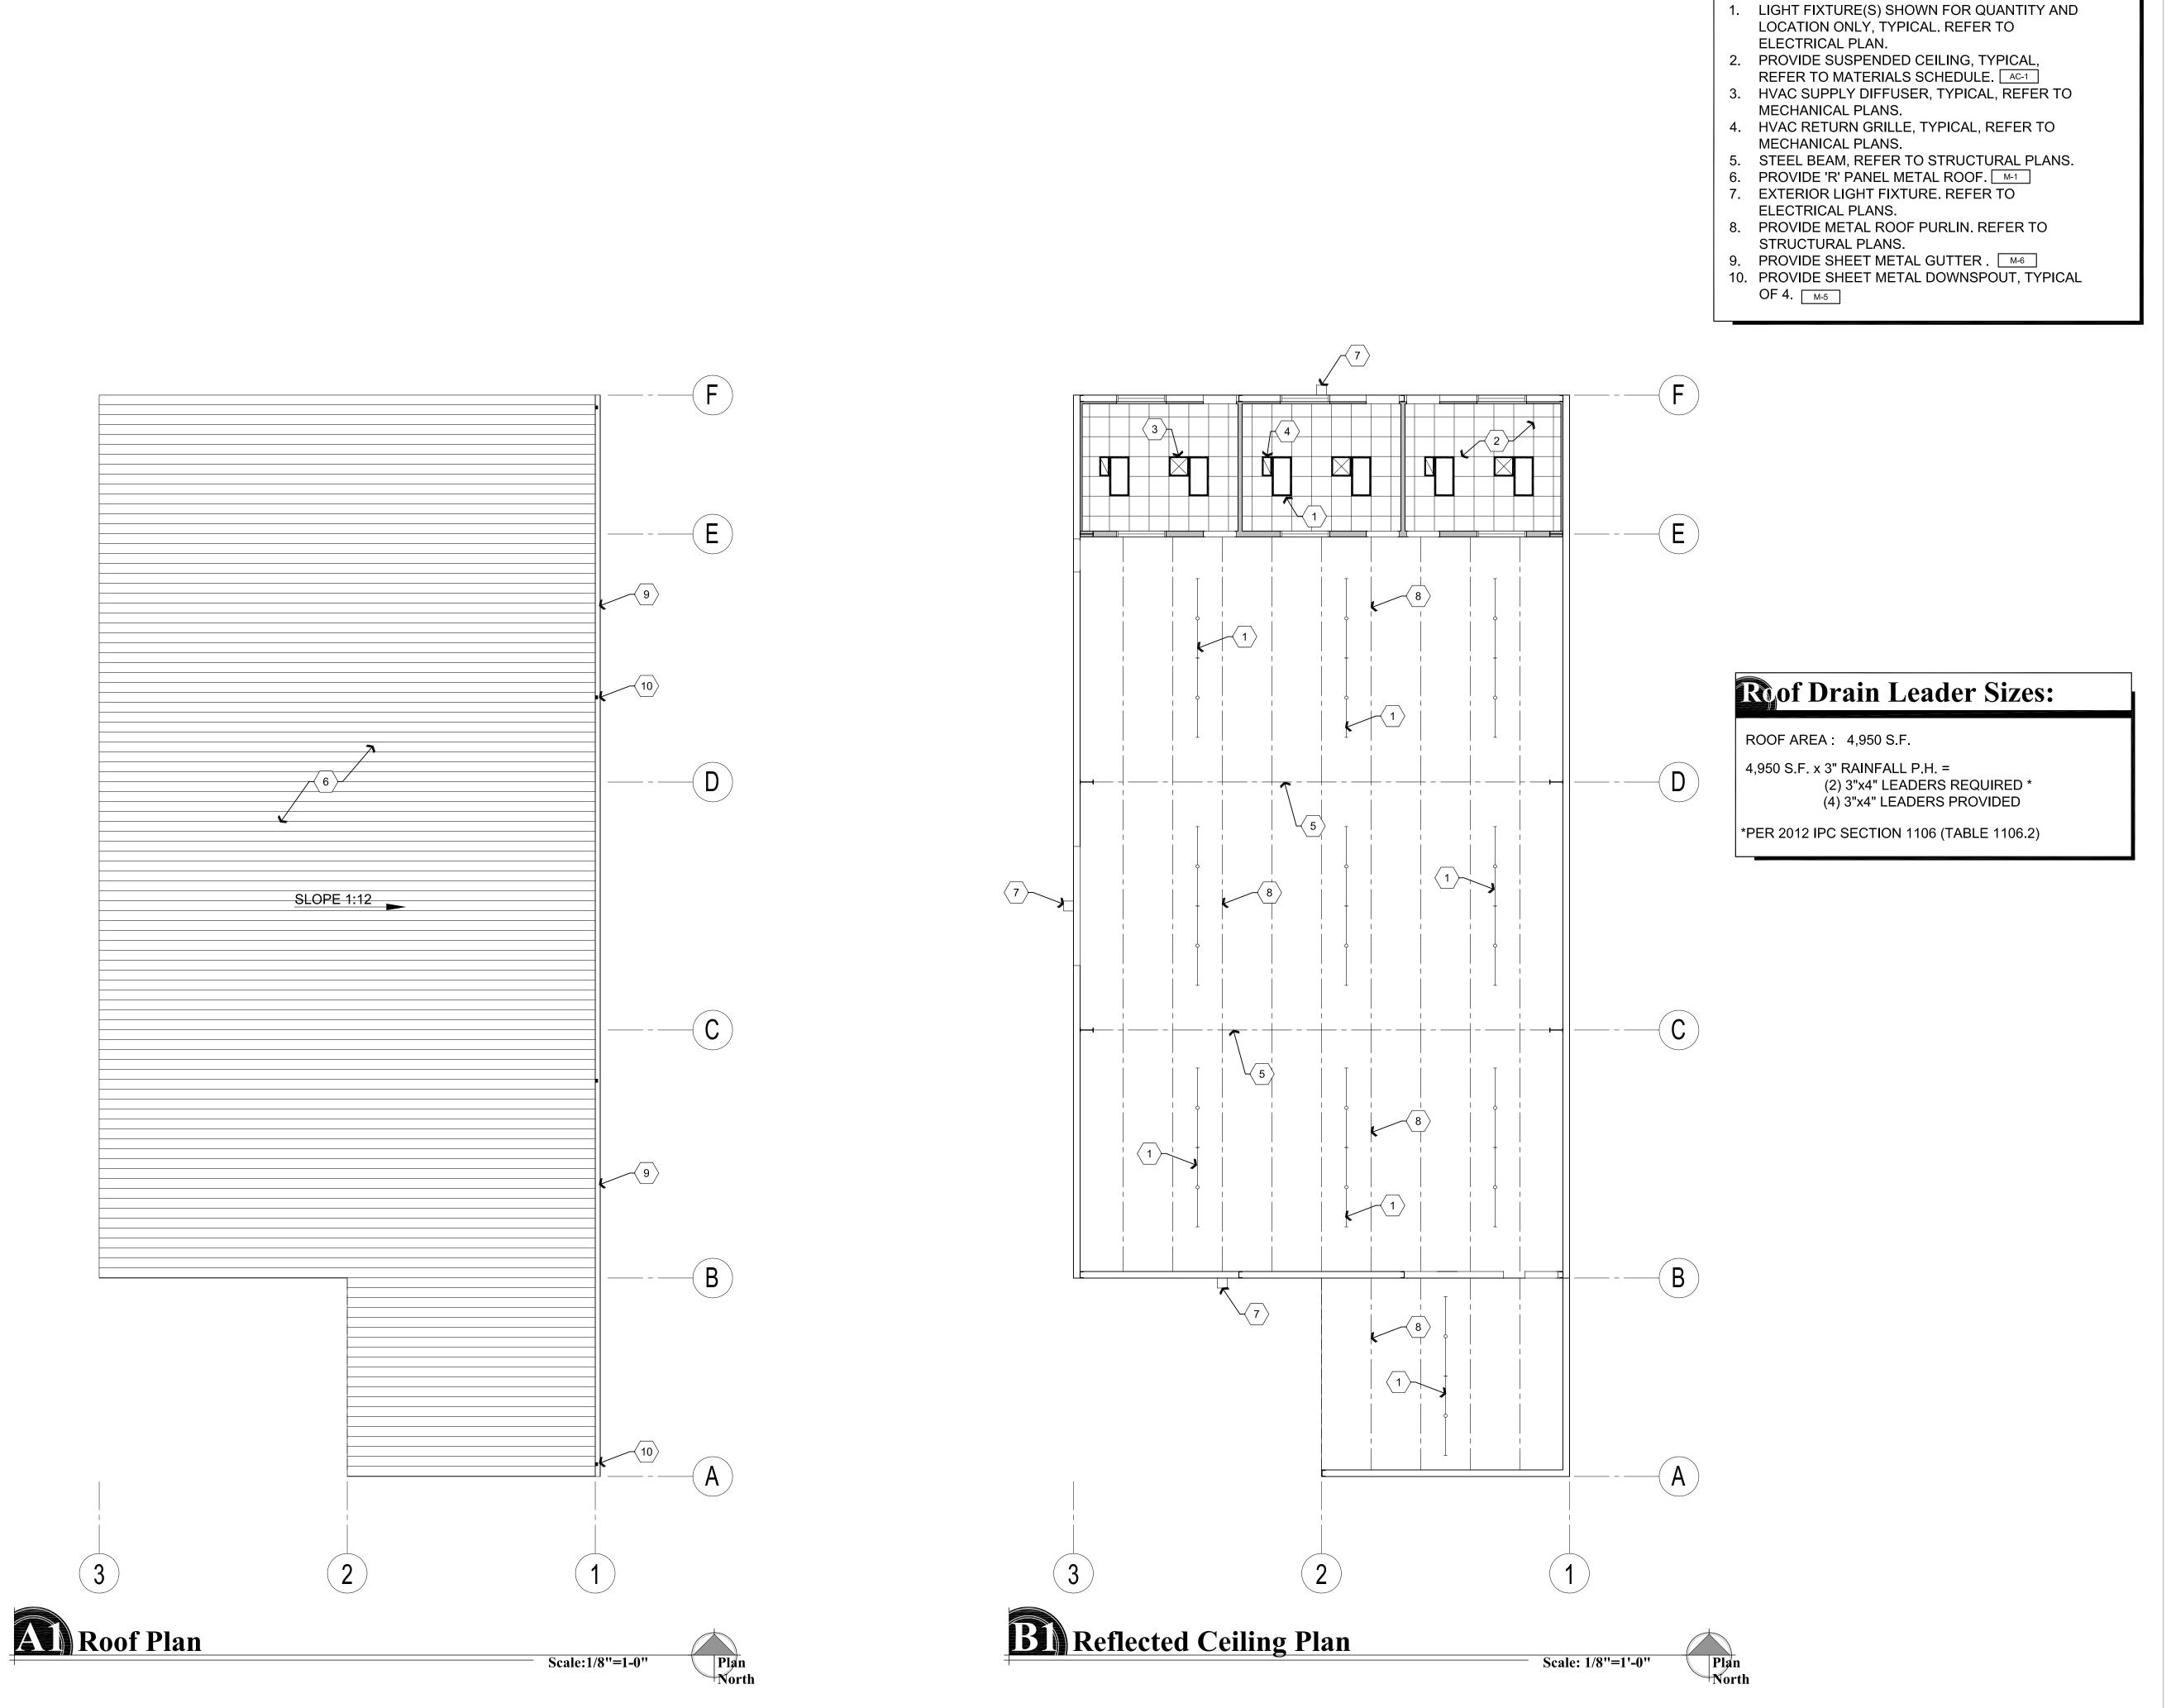

REVISIONS

Discriptive Keynotes \bigcirc

These drawings are the property of

W. Alan Kenson & Associates P.C., and may not be reproduced in any

way without the written consent of


DRAWN BY
L.O.
CHECKED BY
W.A.K. May 9, 2017

JOB NO.
699

SHEET

DRAWING:

A3.0

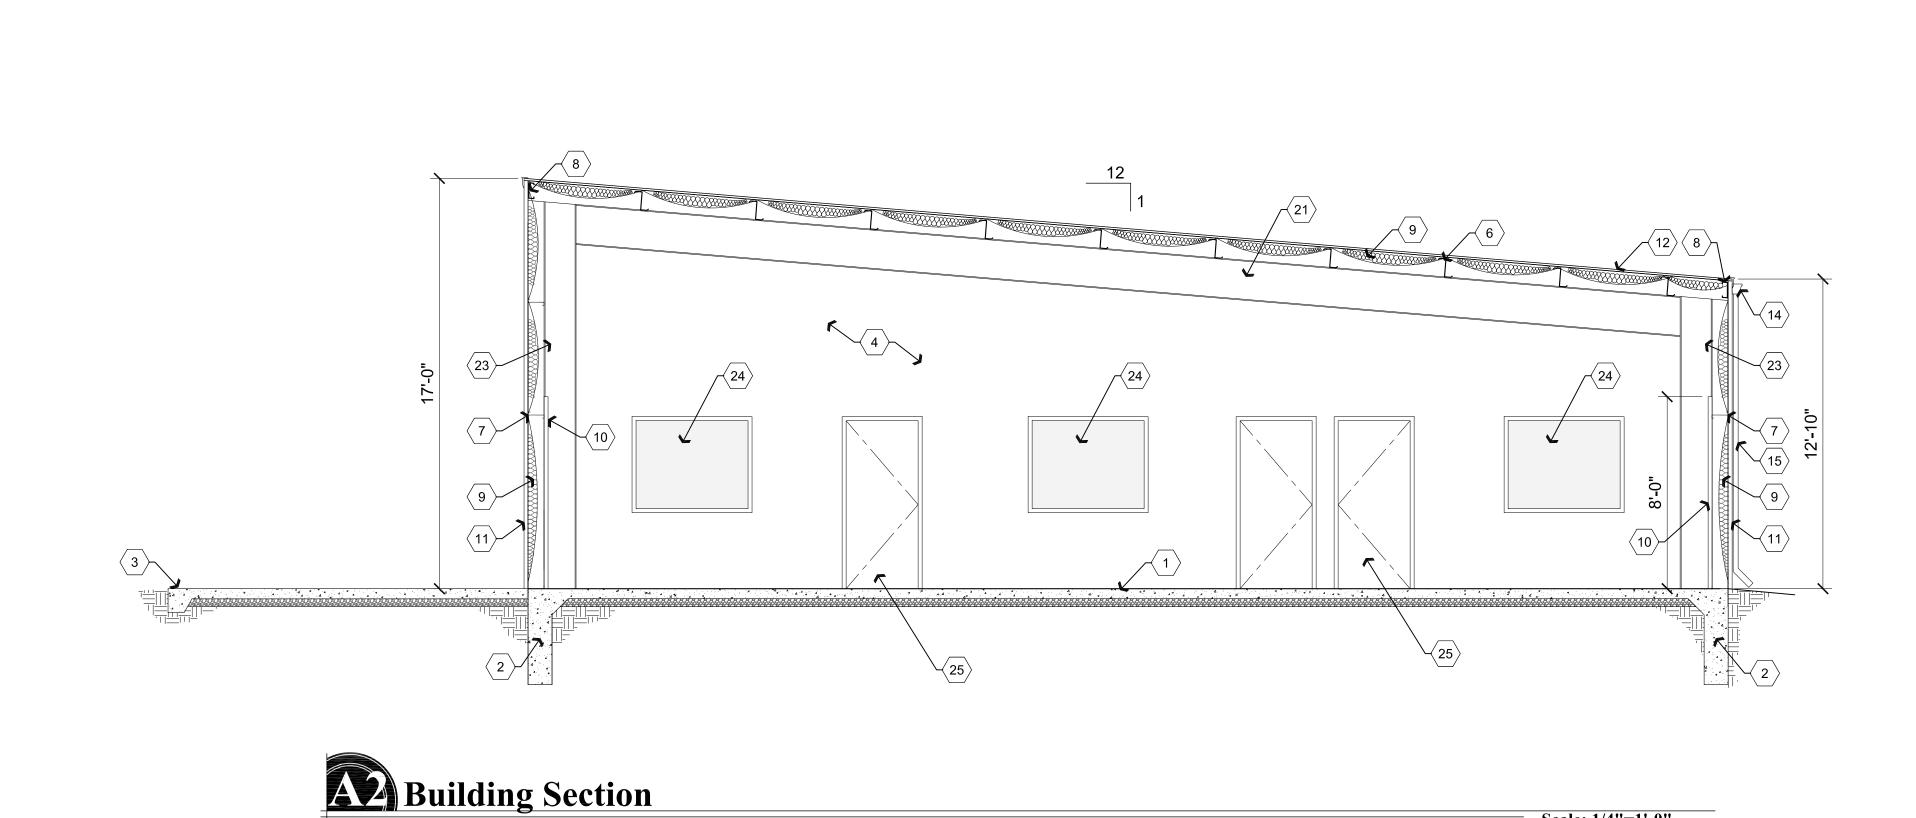


Descriptive Keynotes \bigcirc

- PROVIDE CONCRETE SLAB OVER COMPACTED
 A.B.C., SAWCUT SLAB AT APPROXIMATELY 12'-0"
 O.C. IN BOTH DIRECTIONS. REFER TO STRUCTURAL PLANS.
- 2. PROVIDE CONCRETE FOOTING. REFER TO STRUCTURAL PLANS.
- 3. PROVIDE 12" TURNDOWN AT CONCRETE SIDEWALK.
- REFER TO ARCHITECTURAL SITE PLAN.
 4. INTERIOR WALL, REFER TO WALL TYPES PLAN.
- 5. PROVIDE STEEL BEAM WITHIN GPDW PARTITION. REFER TO STRUCTURAL PLANS.
- 6. PROVIDE ROOF PURLIN, TYPICAL. REFER TO STRUCTURAL PLANS.
- 7. PROVIDE STEEL GIRT, TYPICAL. REFER TO STRUCTURAL PLANS.
- 8. PROVIDE EAVE PURLIN, TYPICAL, REFER TO STRUCTURAL PLANS
- STRUCTURAL PLANS.

 9. PROVIDE R-11 VINYL FACED BLANKET INSULATION.
- 10. PROVIDE SHEET METAL LINER PANEL. M-4

 11. PROVIDE PBR METAL SIDING. M-2
- 12. PROVIDE 'R' PANEL SHEET METAL ROOF PANELS.
 REFER TO MATERIAL SCHEDULE. M-1
- 13. PROVIDE 2 1/2" 25 GAUGE METAL STUDS @ 2'-0"
- 14. PROVIDE SHEET METAL GUTTER. M-6
- 15. PROVIDE SHEET METAL DOWNSPOUT. M-5

 16. NOT USED.
- 17. SUSPENDED CEILING. REFER TO REFLECTED
- CEILING PLAN.
- 18. PROVIDE R-11 UNFACED BATT INSULATION UP TO 10'-0".
- 19. PROVIDE R-19 UNFACED BATT INSULATION ABOVE CEILING.
- 20. PROVIDE DOCK LEVELER, REFER TO STRUCTURAL PLANS AND MATERIALS SCHEDULE.
- 21. PROVIDE STEEL BEAM, REFER TO STRUCTURAL
- PLANS.
 22. PROVIDE STEEL COLUMN, REFER TO STRUCTURAL
- PLANS.
- 23. PROVIDE 5/8" GPDW.
- 24. PROVIDE WINDOW, REFER TO REFERENCE FLOOR PLAN AND WINDOW TYPES. W-2
- 25. PROVIDE DOOR, REFER TO REFERENCE FLOOR
- PLAN AND DOOR SCHEDULE.
- 26. PROVIDE DOCK BUMPERS, REFER TO MATERIALS SCHEDULE. DL-2

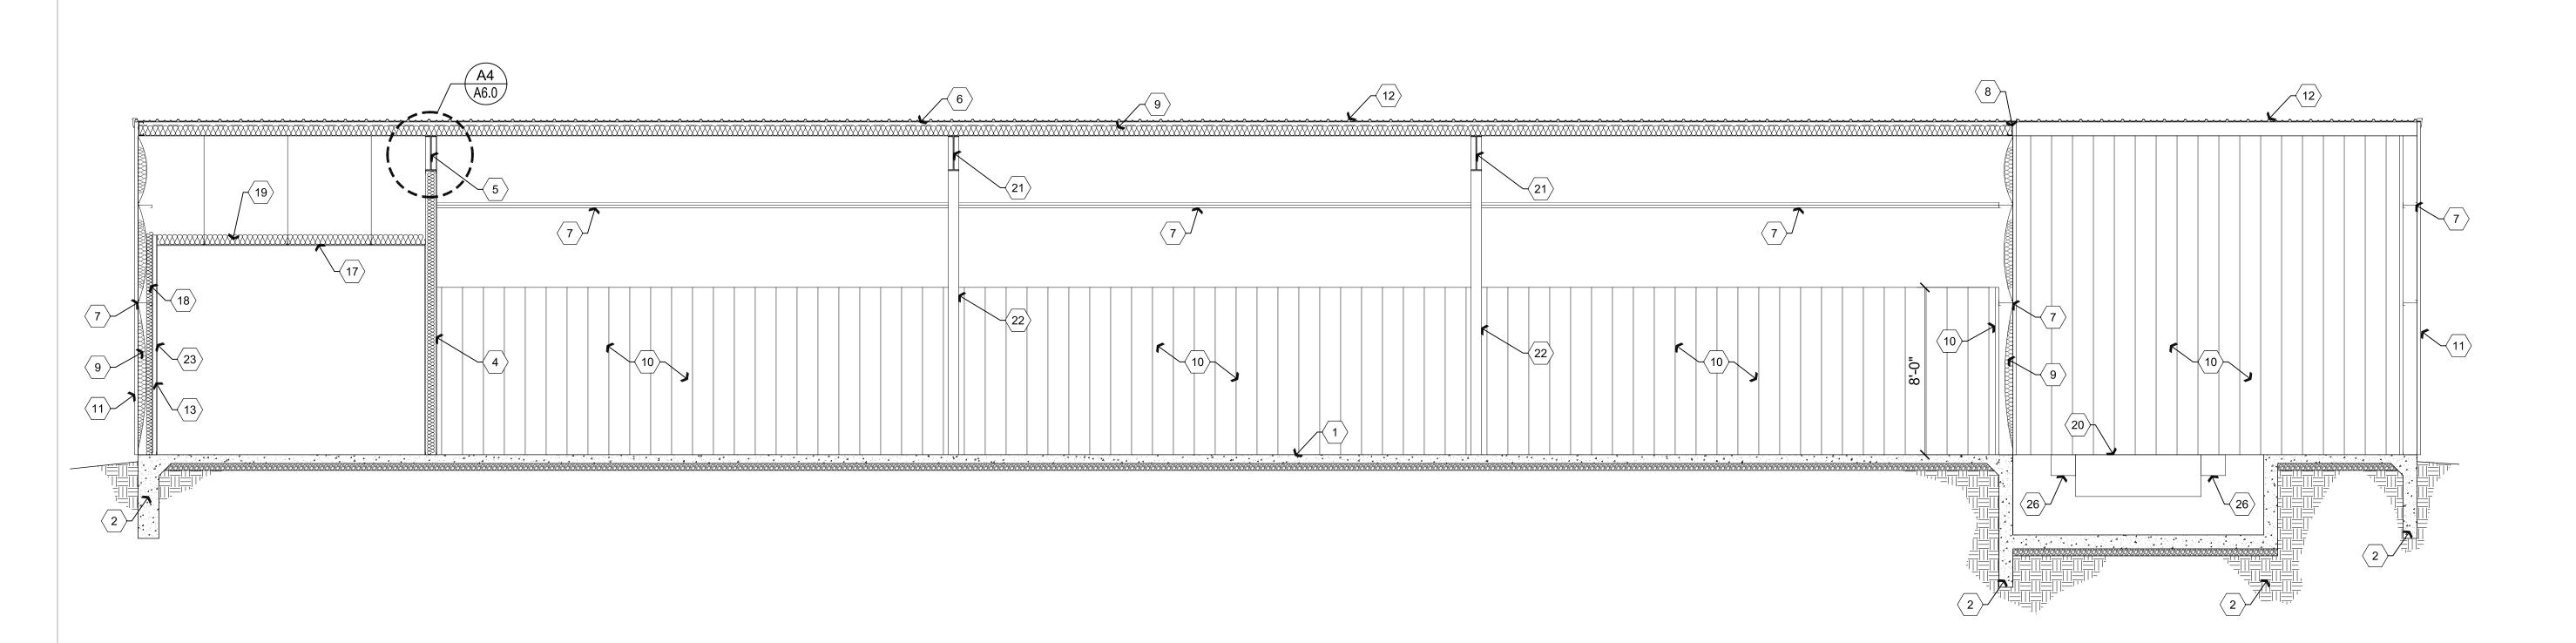

Building Section

cale: 1/4"=1'-0"

V. Alan Kenson & Associates,
P. 928-443-5812 P.O. Box 11593

REVISIONS

These drawings are the property of

W. Alan Kenson & Associates P.C.,

and may not be reproduced in any

way without the written consent of W Nam Kenson & Associates, P.C.

Builders FirstSource 6601 E. 2nd St.

PROJECT:

DRAWN BY
L.O.
CHECKED BY
W.A.K.

DATE
May 9, 2017


JOB NO.

A4.0



- 1. HOLLOW METAL DOOR, REFER TO REFERENCE FLOOR PLAN AND DOOR SCHEDULE.
- 2. OVERHEAD DOOR, REFER TO REFERENCE FLOOR
- PLAN AND DOOR SCHEDULE.
- PROVIDE SHEET METAL GUTTER. M-6
 PROVIDE SHEET METAL DOWNSPOUT. M-5
- 5. PROVIDE SHEET METAL CORNER TRIM. M-4
 6. 4" STEEL CONCRETE FILLED BOLLARDS, 4'-0" ABOVE
- CONCRETE WITH 2'-0" EMBEDDED INTO CONCRETE FOOTING BELOW, TYPICAL.

 7. LIGHT FIXTURE, REFER TO ELECTRICAL PLANS.
- 8. PROVIDE METAL WALL PANEL. REFER TO STRUCTURAL PLANS, WALL TYPES AND MATERIALS SCHEDULE. M-2
- 9. PROVIDE STEEL GRATE AND PREFAB TROUGH,
- REFER TO PLUMBING PLANS.
- 10. PROVIDE RAKE TRIM. M-3
- 11. PROVIDE 'R' PANEL METAL ROOF. M-1
- 12. CONCRETE RETAINING / STEM WALL, REFER TO STRUCTURAL PLANS.
- 13. PROVIDE DOCK LEVELER. DL-1
- 14. PROVIDE 2"x2"x1/8" STEEL TUBE GUARDRAIL ON BOTH SIDES OF TRUCK RAMP. GUARDRAIL SHALL NOT HAVE OPENINGS THAT ALLOW A 21" SPHERE TO PASS THROUGH. PT-2
- 15. PROVIDE CONCRETE FOOTING, REFER TO STRUCTURAL PLANS.
- 16. PROVIDE DOCK BUMPERS, REFER TO MATERIALS SCHEDULE. DL-2
- 17. PROVIDE ROOF PURLIN, TYPICAL, REFER TO STRUCTURAL PLANS.
- 18. PROVIDE 4"x4"x1/4" BASE PLATE. ATTACH TO CONCRETE WALL W/ 3/8"x3" EXPANSION BOLTS, TYPICAL.
- 19. CONCRETE TRUCK RAMP, REFER TO STRUCTURAL PLANS.

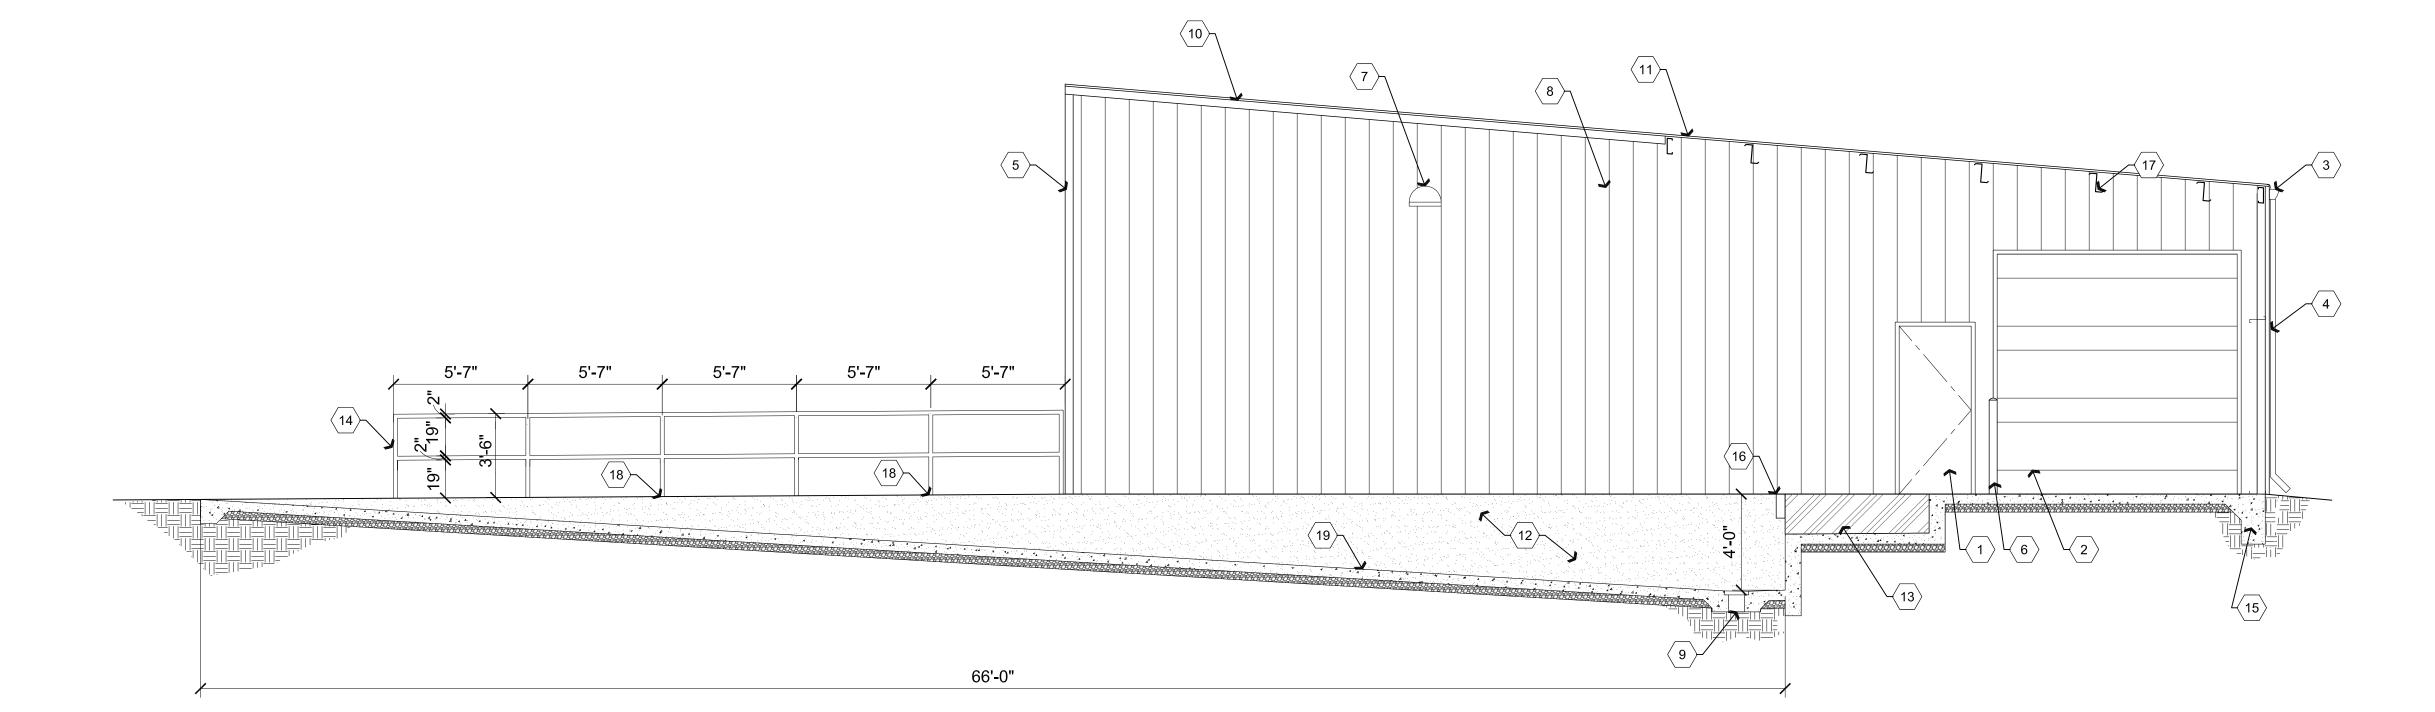



V. Alan Kenson & Associates,
P. 928-443-5812 P.O. Box 11593

REVISIONS

These drawings are the property of W. Alan Kenson & Associates P.C.,

and may not be reproduced in any

way without the written consent of

W Kenson & Associates, P.C.

Builders FirstSource 6601 E. 2nd St.

PROJECT: Bu


DRAWN BY
L.O.

CHECKED BY
W.A.K.


DATE
May 9, 2017

A4.1


200,100

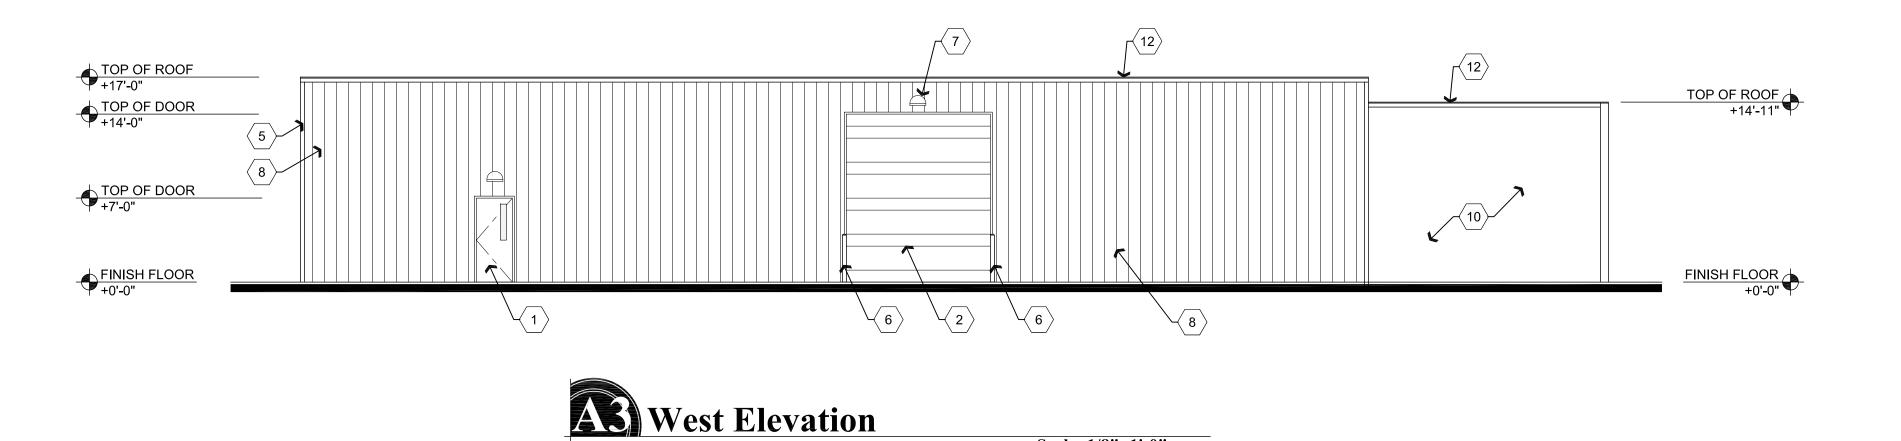


Scale: 1/8"=1'-0"

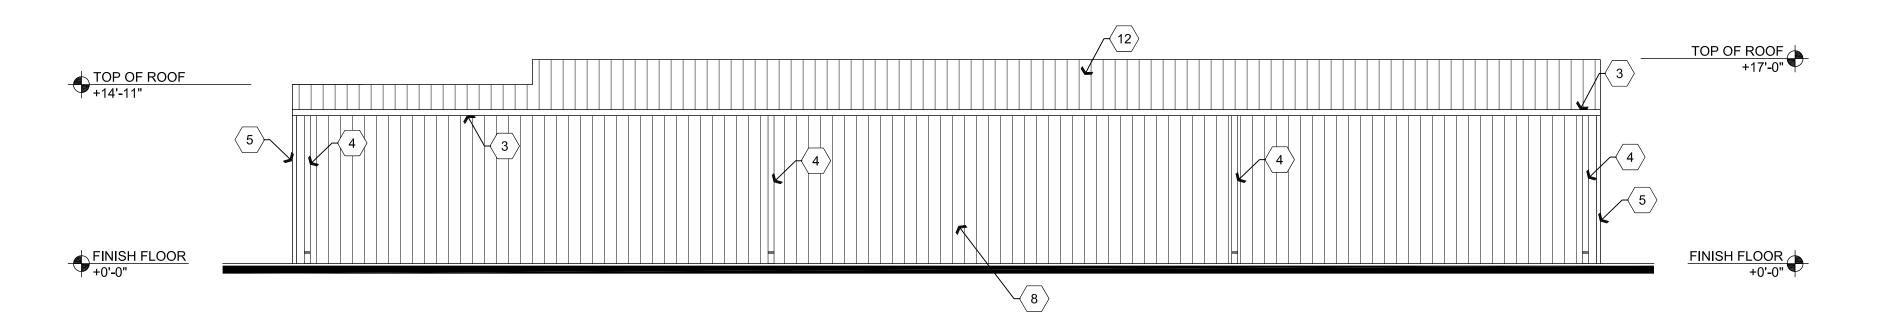



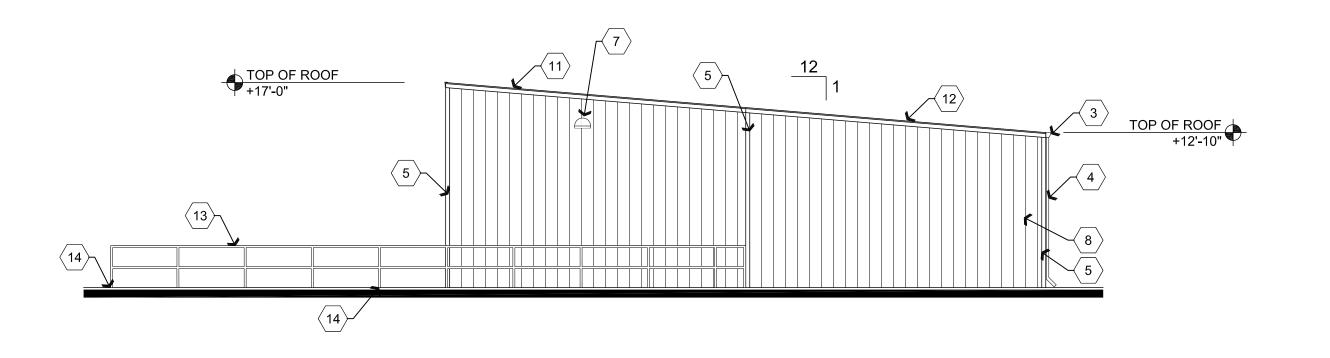

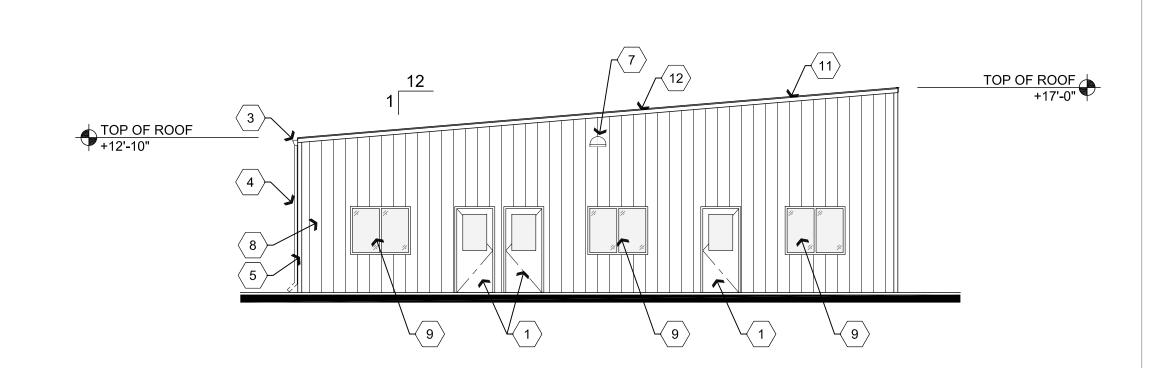

South Elevation

Scale: 1/8"=1'-0"

B North Elevation

Discriptive Keynotes \bigcirc

HOLLOW METAL DOOR, REFER TO REFERENCE FLOOR PLAN AND DOOR SCHEDULE.

OVERHEAD DOOR, REFER TO REFERENCE FLOOR PLAN AND DOOR SCHEDULE.

PROVIDE SHEET METAL GUTTER. M-6 PROVIDE SHEET METAL DOWNSPOUT. M-5

PROVIDE SHEET METAL CORNER TRIM. M-3 4" STEEL CONCRETE FILLED BOLLARDS, 4'-0" ABOVE

CONCRETE WITH 2'-0" EMBEDDED INTO CONCRETE FOOTING BELOW, TYPICAL. LIGHT FIXTURE, REFER TO ELECTRICAL PLANS. PROVIDE METAL WALL PANEL. REFER TO

STRUCTURAL PLANS, WALL TYPES AND MATERIALS SCHEDULE. M-2 EXTERIOR WINDOW. REFER TO REFERENCE FLOOR

PLAN AND WINDOW TYPES. W-1

10. COVERED DOCK AREA, OPEN IN FRONT. 11. PROVIDE RAKE TRIM. M-3

12. PROVIDE 'R' PANEL METAL ROOF. M-1

13. PROVIDE 2"x2"x1/8" STEEL TUBE GUARDRAIL ON

BOTH SIDES OF TRUCK RAMP. GUARDRAIL SHALL NOT HAVE OPENINGS THAT ALLOW A 21" SPHERE TO PASS THROUGH. PT-2

14. PROVIDE 4"x4"x1/4" BASE PLATE. ATTACH TO CONCRETE WALL W/ 3/8"x3" EXPANSION BOLTS, TYPICAL.

ssociates >

REVISIONS

These drawings are the property of

W. Alan Kenson & Associates P.C.,


and may not be reproduced in any

way without the written consent of

W 🚵 Kenson & Associates, P.C.

DRAWING:

DRAWN BY L.O. CHECKED BY W.A.K. May 9, 2017

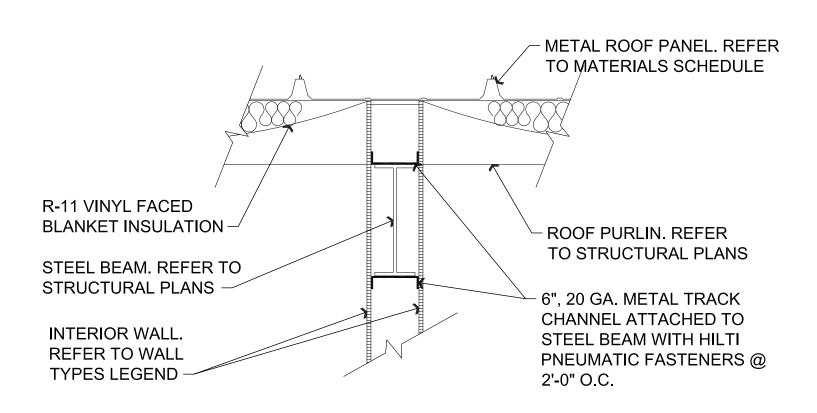




CODE	MATERIAL	LOCATION	MANUFACTURER	SPECIFICATION
AC-1	ACOUSTICAL CEILING TILE	REFER TO REFLECTED CEILING PLAN	ROCKFON	ASTM E1264; 2'x2'x5/8" #600 NON DIRECTIONAL SQUARE LAY IN TILE 15/16" WHITE SUSPENDED METAL T-BAR GRID
D-1	INTERIOR DOOR	OFFICES	HALEY	SOLID CORE OAK LEGACY WOOD WITH BLACK STEEL TIMELY DOOR FRAME
D-2	DOOR	EXTERIOR DOORS		18 GAUGE HOLLOW METAL DOOR WITH 16 GAUGE HOLLOW METAL FRAME
D-3	OVERHEAD DOOR	WAREHOUSE	CHI	INSULATED RIBBED STEEL OVERHEAD DOOR WITH CHAIN HOIST, MODEL 324
M-1	METAL ROOF PANEL	ROOF	MBCI	PBR, 26 GAUGE, PRE-PAINTED, POLAR WHITE (SIGNATURE 200)
M-2	EXTERIOR METAL WALL PANEL	EXTERIOR WALLS	MBCI	PBR PANEL 26 GAUGE, PRE-PAINTED, POLAR WHITE (SIGNATURE 200)
M-3	EXTERIOR METAL TRIM	EXTERIOR WALLS AS INDICATED ON ELEVATION PLANS	MBCI	26 GAUGE, PRE-PAINTED, SCARLET RED (SIGNATURE 300)
M-4	METAL LINER PANEL	INTERIOR OF EXTERIOR WALLS UP TO 8'-0" A.F.F.	MBCI	PBR PANEL 26 GAUGE PRE-PAINTED, POLAR WHITE (SIGNATURE 200)
M-5	DOWNSPOUTS	EXTERIOR EAST SIDE OF BUILDING	MBCI	26 GAUGE, PRE-PAINTED, POLAR WHITE (SIGNATURE 200)
M-6	RAIN GUTTER	EXTERIOR EAST SIDE OF BUILDING	MBCI	26 GAUGE, PRE-PAINTED, SCARLET RED (SIGNATURE 300)
PT-1	PAINT	INTERIOR WALLS	SHERWIN WILLIAMS	DOVER WHITE
PT-2	PAINT	GUARD RAILS	SHERWIN WILLIAMS	SHERWIN WILLIAMS B50AZ6 KEM-KROMIK GREY PRIMER WITH SHERWIN WILLIAMS F75BC14 SHER-KEM RAVEN BLACK
RB-1	RUBBER BASE	REFER TO ROOM FINISH SCHEDULE	ROPPE	BLACK / BROWN
VCT-1	VINYL COMPOSITION TILE	OFFICES	ARMSTRONG	IMPERIAL TEXTURE, STANDARD EXCELON, 51836 SHELTER WHITE
W-1	EXTERIOR WINDOW	OFFICES	M&I	5'x4' SLIDER
W-2	INTERIOR WINDOW	OFFICES	TIMELY	5'x4' FIXED
DL-1	DOCK LEVELER	DOCK	POWERAMP	CM-66
DL-2	DOCK BUMPER	DOCK	POWERAMP	B410-14F

NO.	ROOM NAME	SIZE	TYPE	DOOR MATERIAL	DOOR FINISH	FRAME MATERIAL	FRAME FINISH	HARDWARE TYPE	COMMENTS
100A	WAREHOUSE	3'-0"x7'-0"	В	H.M.	PAINT	H.M.	PAINT	HW-02	
100B	WAREHOUSE	3'-0"x7'-0"	В	H.M.	PAINT	H.M.	PAINT	HW-02	
100C	WAREHOUSE	12'-0"x14'-0"	E	STEEL	PAINT	STEEL	PAINT	HW-03	
100D	WAREHOUSE	10'-0"x10'-0"	D	STEEL	PAINT	STEEL	PAINT	HW-03	
101A	OFFICE	3'-0"x7'-0"	А	S.C. WOOD	PRE-FINISHED STAIN	STEEL	PAINT	HW-01	
101B	OFFICE	3'-0"x7'-0"	С	H.M.	PAINT	H.M.	PAINT	HW-02	
102A	OFFICE	3'-0"x7'-0"	А	S.C. WOOD	PRE-FINISHED STAIN	STEEL	PAINT	HW-01	
102B	OFFICE	3'-0"x7'-0"	С	H.M.	PAINT	H.M.	PAINT	HW-02	
103A	OFFICE	3'-0"x7'-0"	А	S.C. WOOD	PRE-FINISHED STAIN	STEEL	PAINT	HW-01	
103B	OFFICE	3'-0"x7'-0"	С	H.M.	PAINT	H.M.	PAINT	HW-02	

DOOR NOTES:

- ALL EXIT DOORS & HARDWARE SHALL COMPLY WITH THE 2012 I.B.C.
- 2. DOOR THRESHOLDS SHALL HAVE A MAX HEIGHT OF 1/2" FOR H.C. ACCESSIBILITY. THRESHOLD SHALL HAVE A MAXIMUM RISE OF 1/4" AND 1/2" RISE WHEN BEVELED WITH MAXIMUM 1:2 SLOPE.
- 3. ALL GLAZING IN DOORS SHALL BE SAFETY GLAZING.
- ALL INTERIOR DOORS SHALL BE OPERABLE FOR EMERGENCY EXITING PURPOSES WITHOUT THE USE OF A KEY, SPECIAL KNOWLEDGE NOR EFFORT.
- ALL GLAZING WITHIN 24" OF OPENINGS SHALL BE SAFETY GLASS.
- IF A DOOR HAS A CLOSER, THEN THE SWEEP PERIOD OF THE CLOSER SHALL BE ADJUSTED SO THAT FROM AN OPEN POSITION OF 70 DEGREES, THE DOOR WILL TAKE AT LEAST 3 SECONDS TO MOVE TO A POINT 3" FROM THE LATCH, MEASURED TO THE LEADING EDGE OF THE DOOR.
- DOOR HANDLES, PULLS, LATCHES, LOCKS, AND OTHER OPERATING DEVICES ON ACCESSIBLE DOORS SHALL HAVE A SHAPE THAT IS EASY TO GRASP WITH ONE HAND AND DOES NOT REQUIRE TIGHT GRASPING, TIGHT PINCHING, OR TWISTING OF THE WRIST TO OPERATE. HARDWARE REQUIRED FOR DOOR PASSAGE SHALL BE MOUNTED NO HIGHER THAN 48" ABOVE FINISH FLOOR.

	DOON 1 NOONGE ON NEED IN CONTENT NO THOUSEN THE TOTAL TO THOU TO THE CONTENT NO T
8.	DOOR OPENING FORCE SHALL BE: 5lbf MAX INTERIOR HINGED, SLIDING OR FOLDING DOORS; FIRE DOORS SHALL HAVE THE MINIMUM OPENING
	FORCE ALLOWABLE BY THE APPROPRIATE ADMINISTRATIVE AUTHORITY.

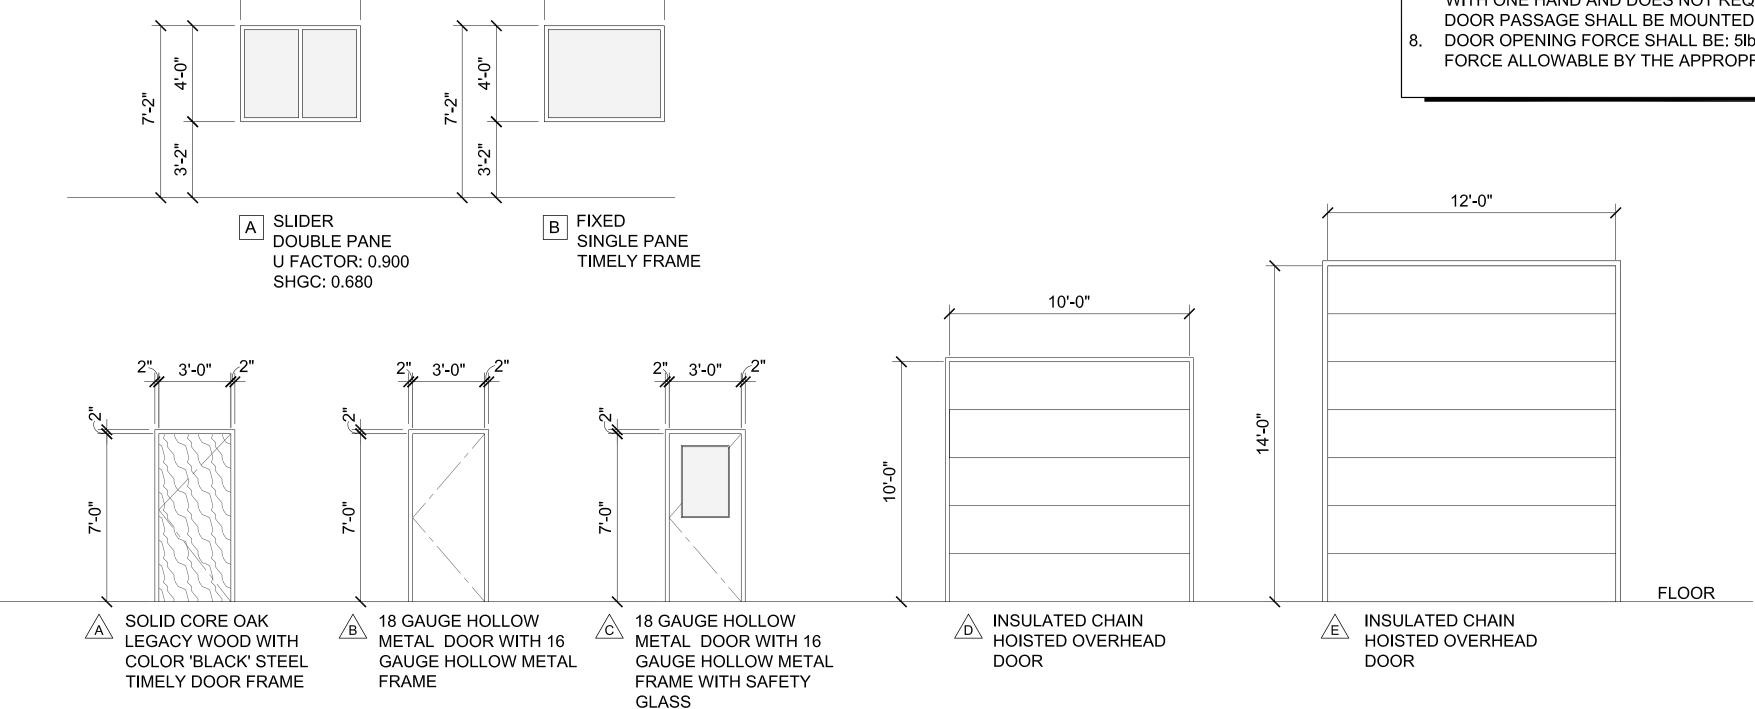



LEVER ENTRY LOCK, WALL STOP

LEVER ENTRY LOCK, CHAIN STOP,

WEATHER STRIP, THRESHOLD,

DOOR BOTTOM

CHAIN HOISTED OPERATOR

DRAWN BY L.O. CHECKED BY W.A.K. May 9, 2017

REVISIONS


These drawings are the property of W. Alan Kenson & Associates P.0

JOB NO. **699**

SHEET

Door and Window Types

Scale: n.t.s.

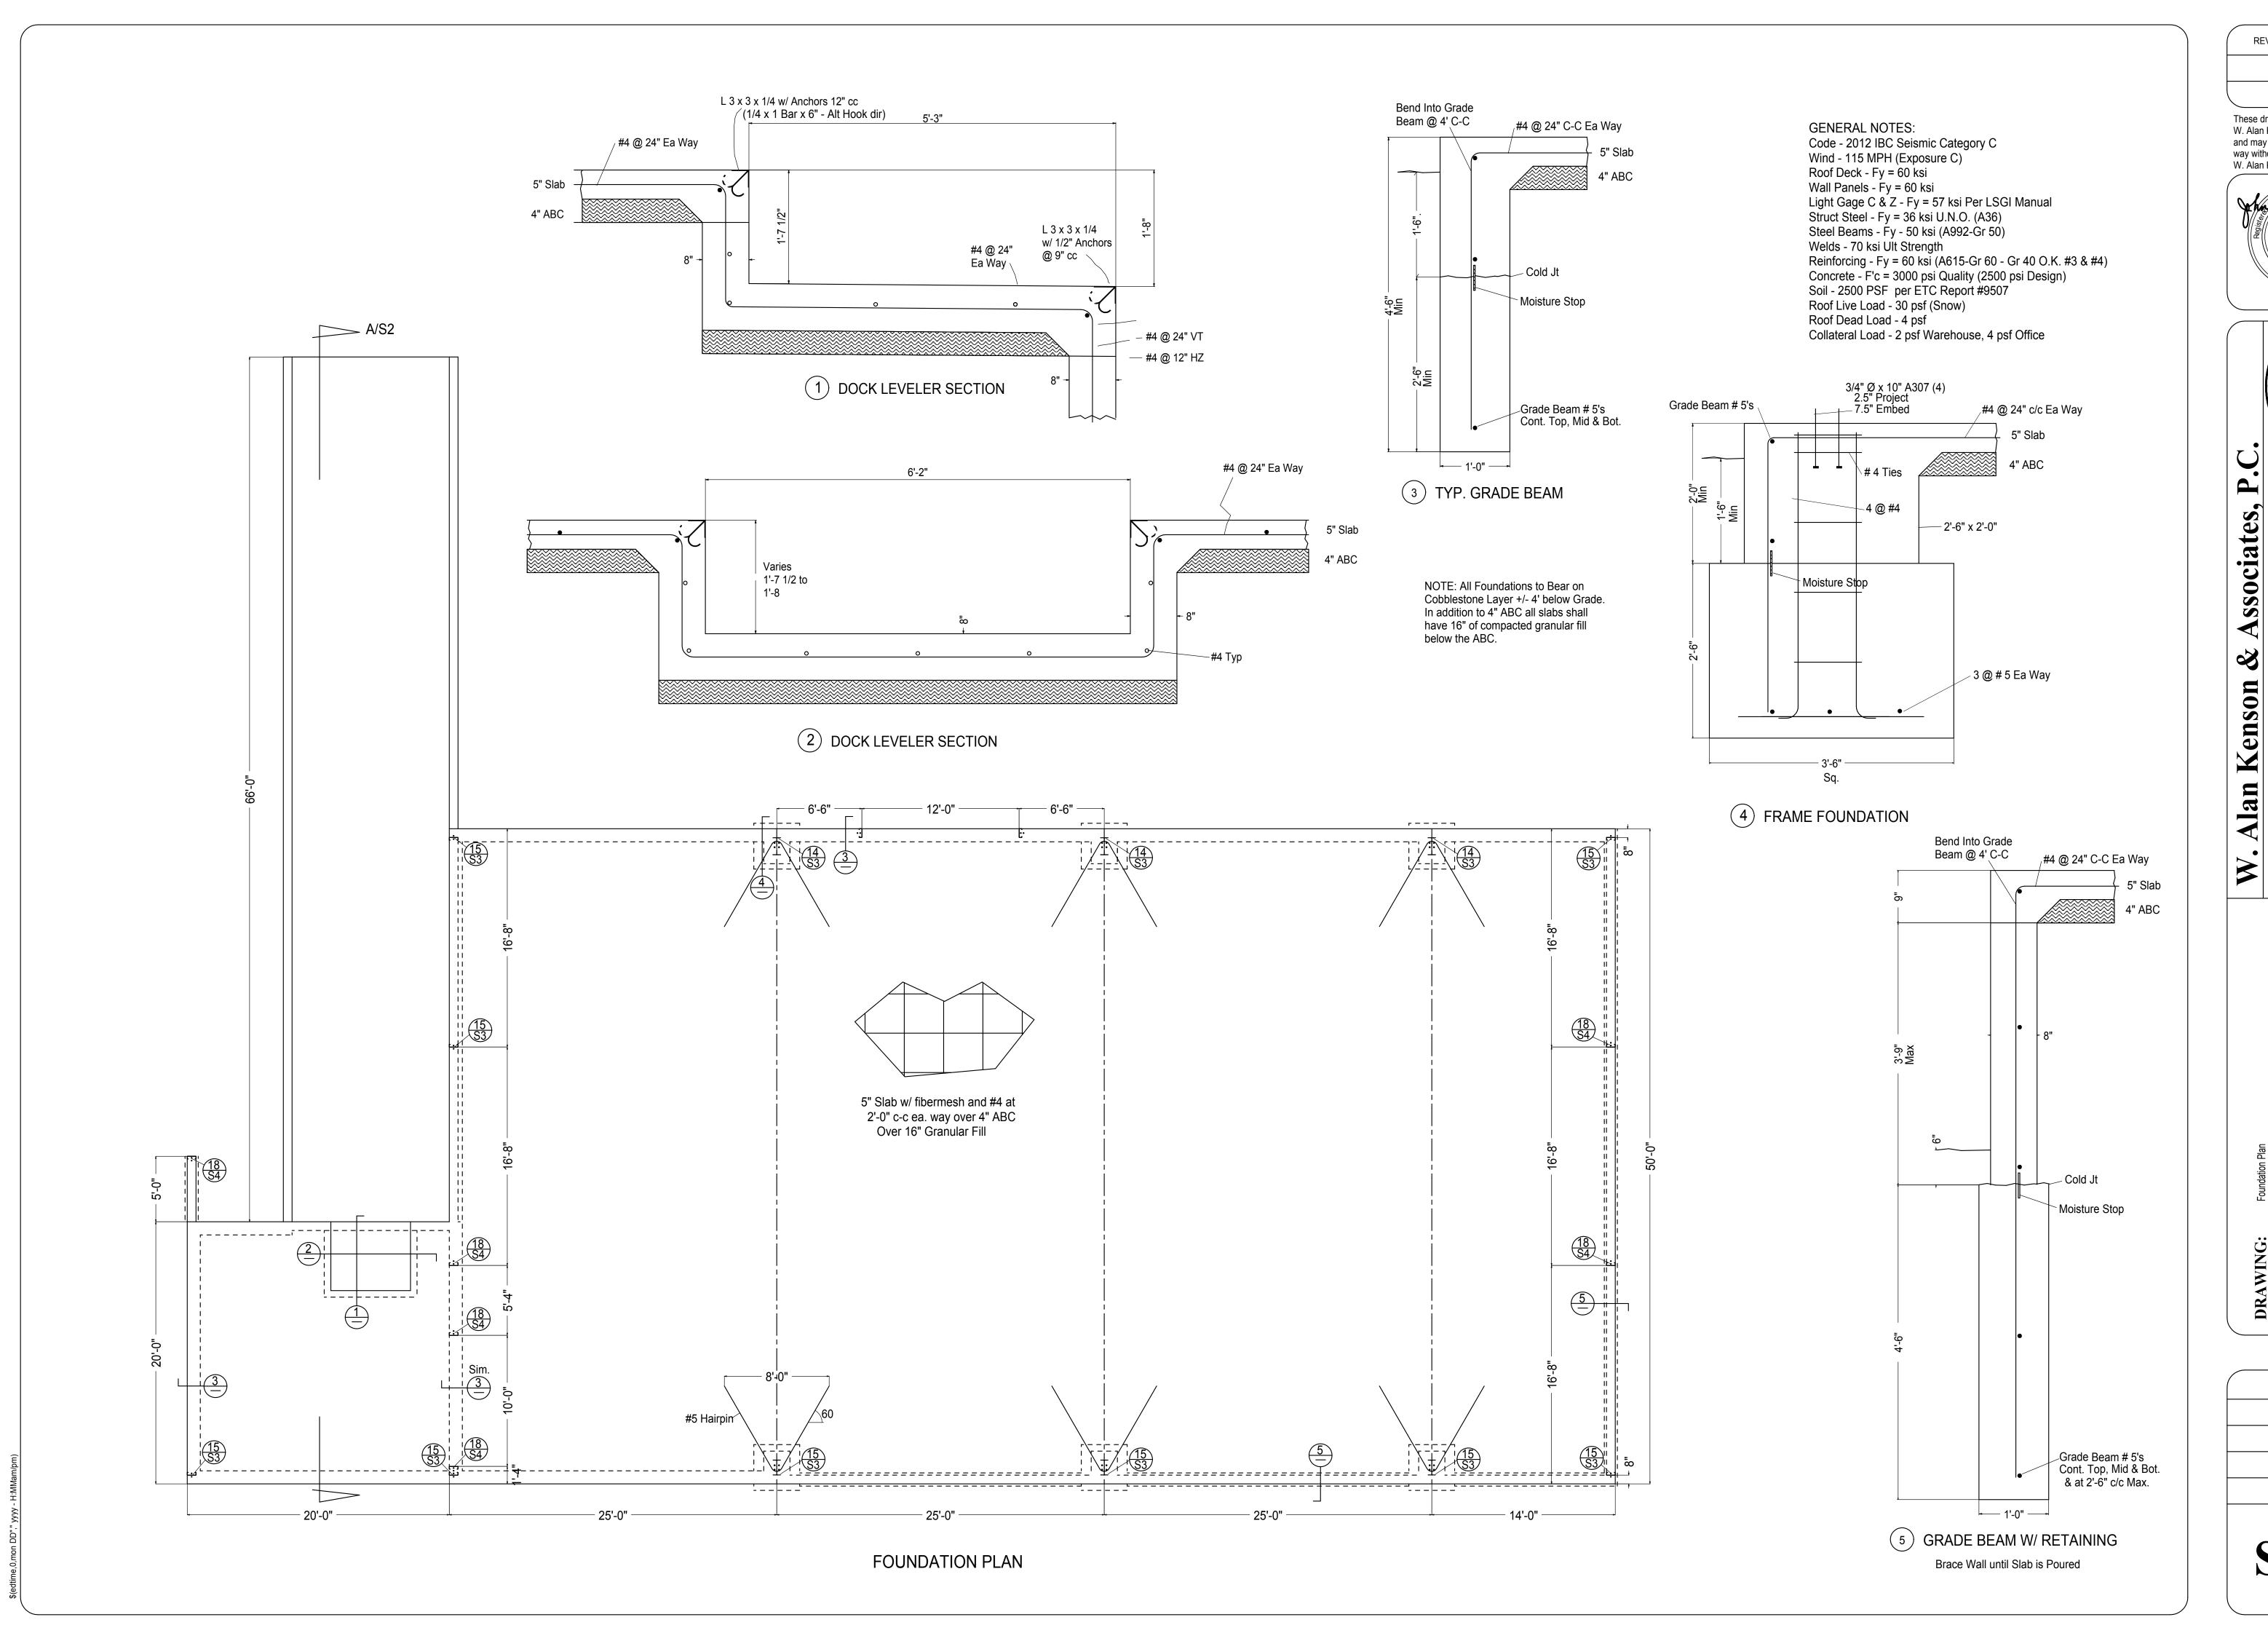



REVISIONS

These drawings are the property of W. Alan Kenson & Associates P.C., and may not be reproduced in any way without the written consent of W. Alan Kenson & Associates, P.C.




CHECKED BY DATE 5/02/17 SCALE 3/16" = 1'-0"

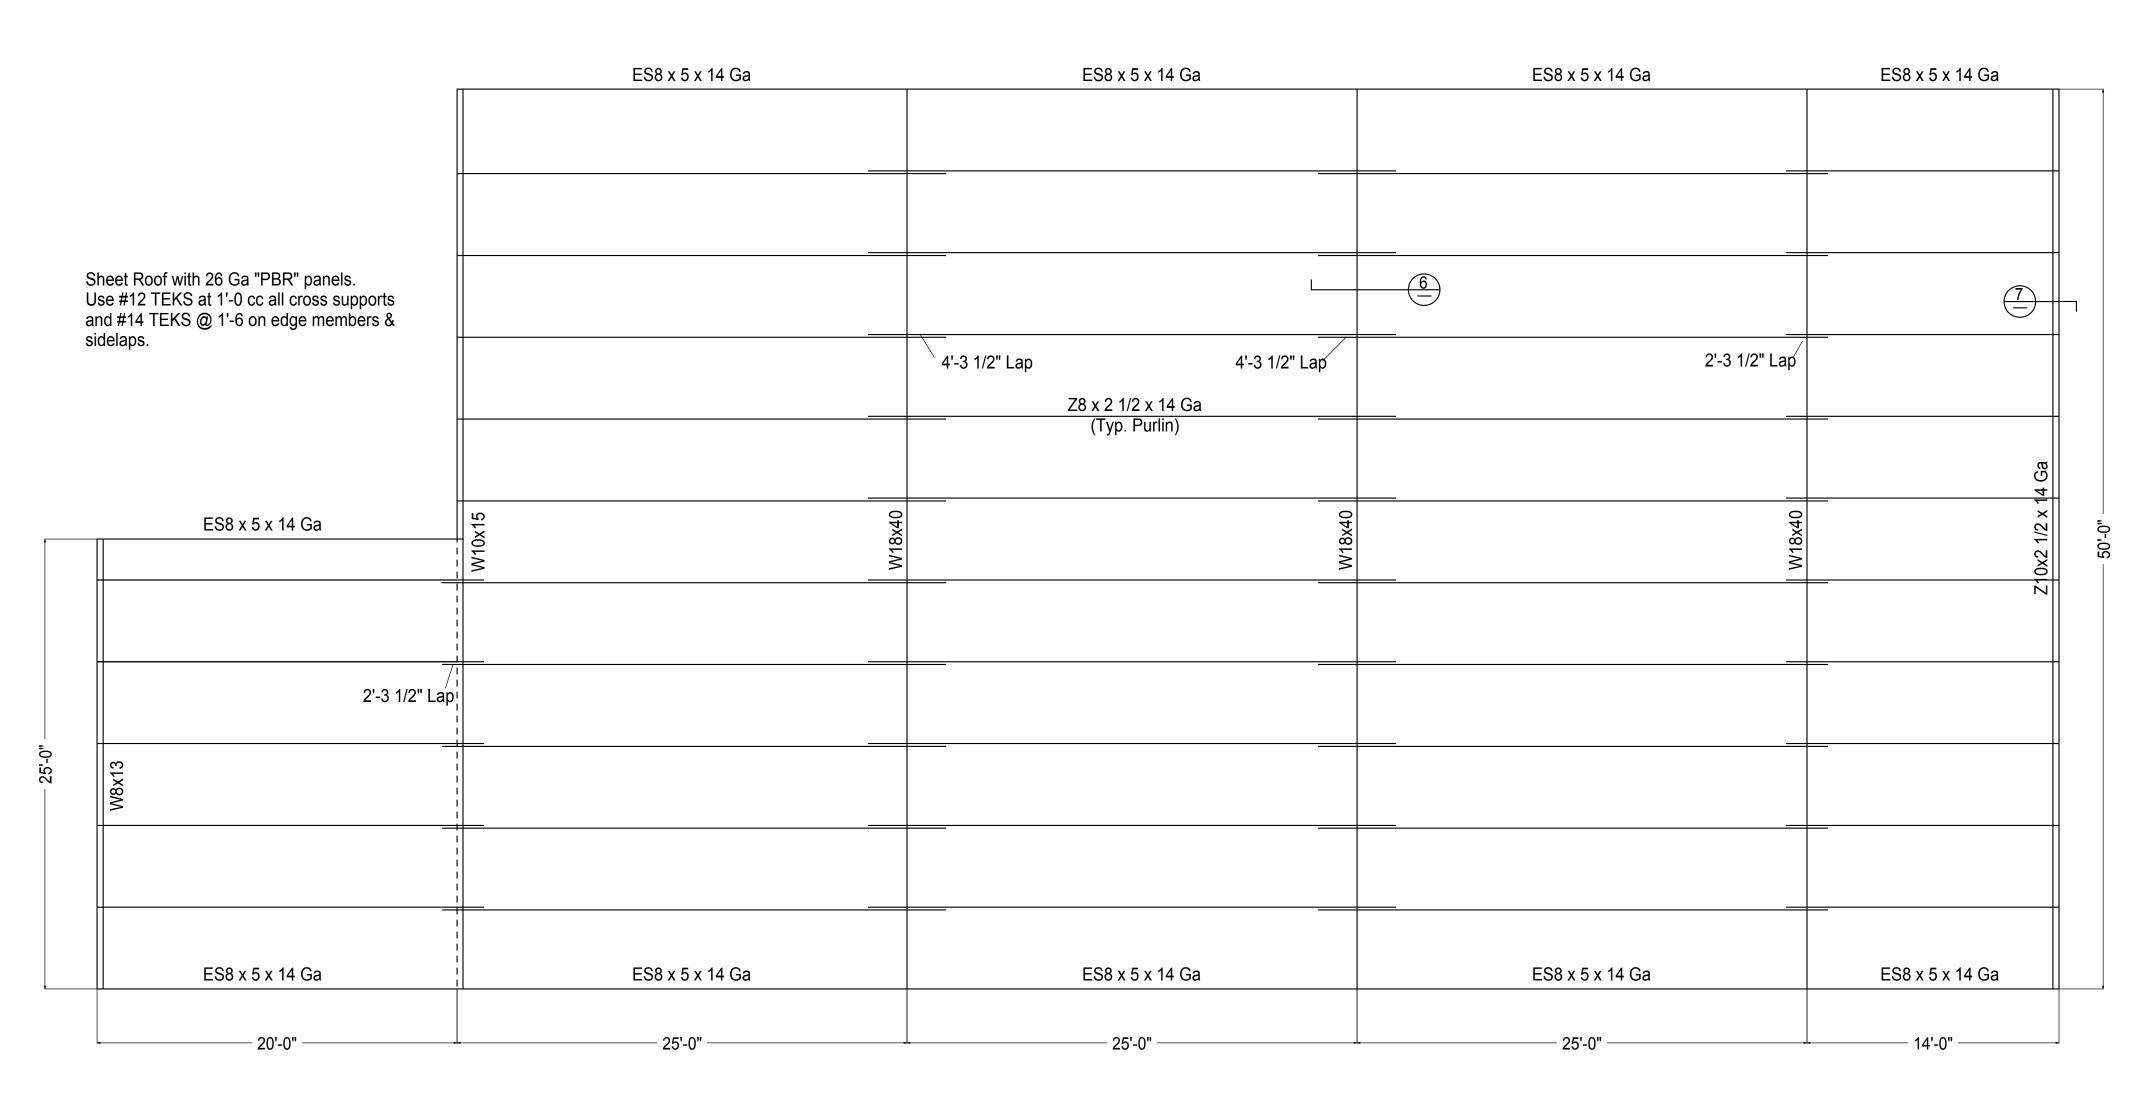

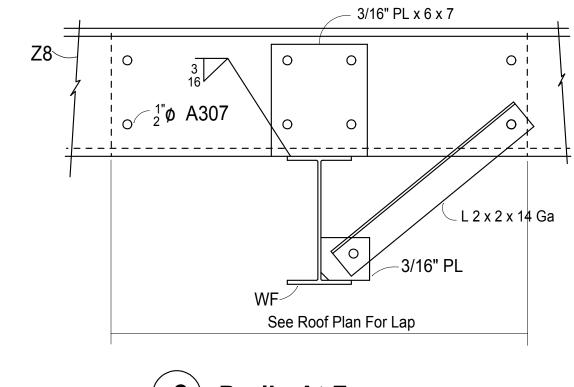


6 Purlin At Frame

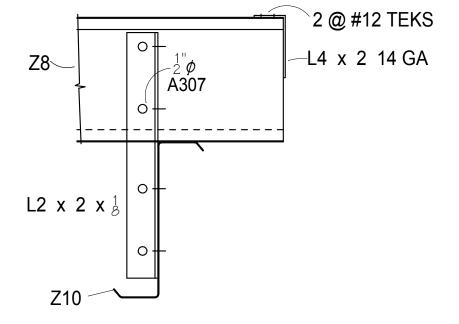

7 Endwall Purlin Connection

ROOF FRAMING PLAN

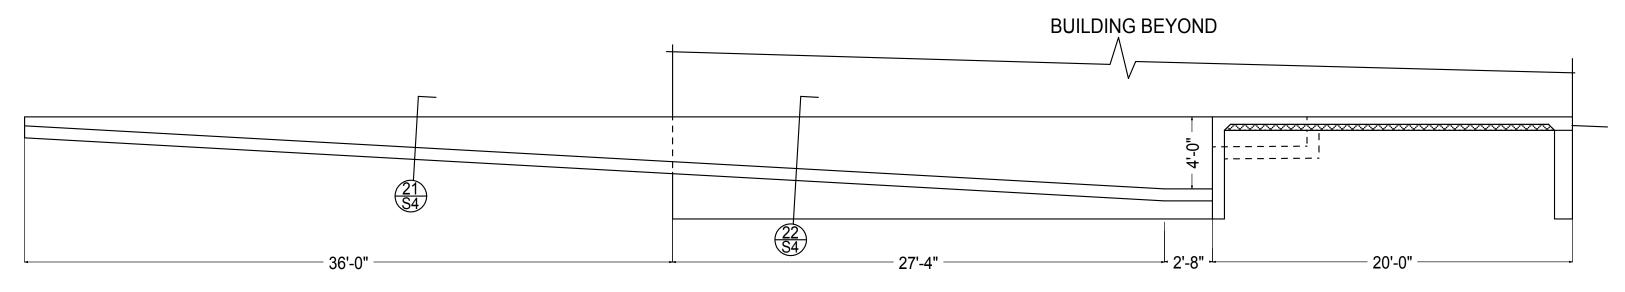

SECTION A TRUCK WELL SECTION

DRAWING: Roof Framing Plan

PROTECT: Ruilders EiretSource

REVISIONS

Associates,

Alan Kenson

These drawings are the property of W. Alan Kenson & Associates P.C., and may not be reproduced in any way without the written consent of W. Alan Kenson & Associates, P.C.

DRAWN BY

JJG

CHECKED BY

JJG

DATE


5/02/17

SCALE


3/16" = 1'-0"

S-2

edtime,0,mon DD"," yyyy - H:MMam/pm)

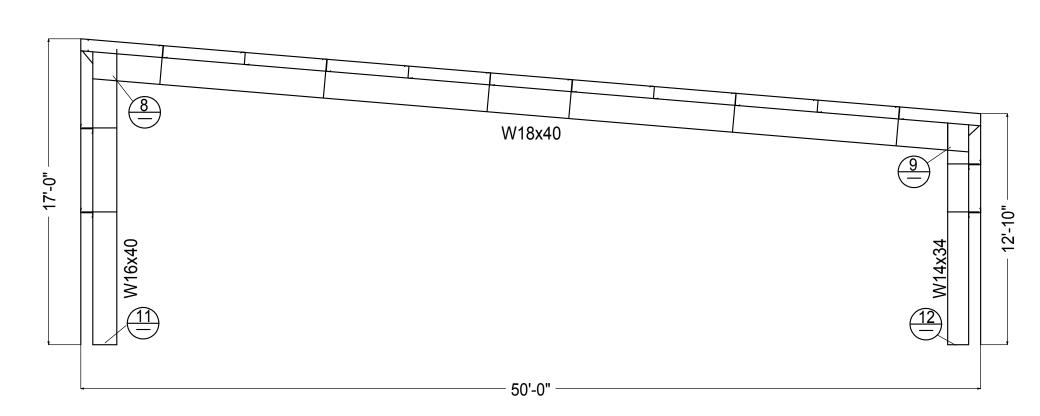


SECTION AT FRAME

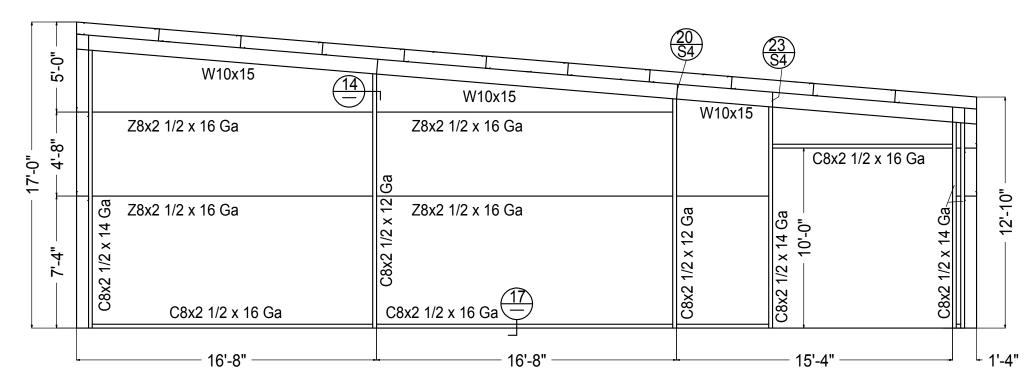

SOUTH ELEVATION


Sheet Wall with 26 Ga "PBR" panels.
Use #12 TEKS at 1'-0 cc all cross supports
and #14 TEKS @ 1'-6 on edge members &
sidelaps. Use #12 TEKS @ 6" cc all panel ends.
Line Interior to 8'-0" with 26 Ga "PBR" Panels.

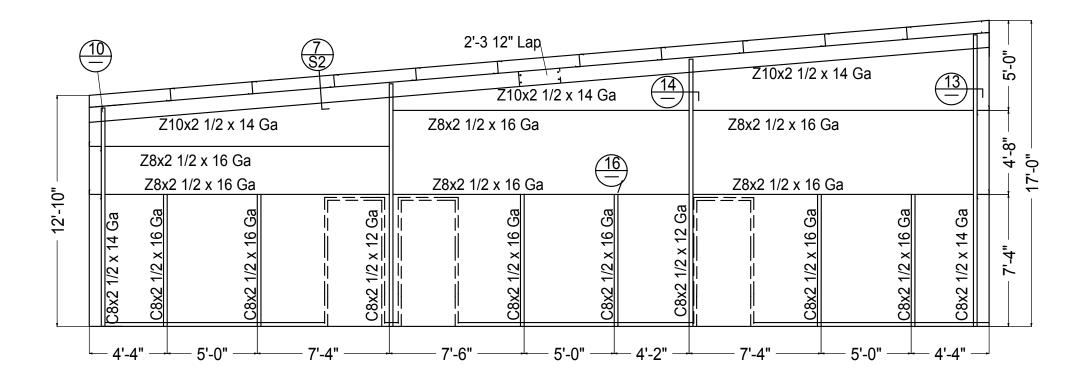


Sheet Wall with 26 Ga "PBR" panels.
Use #12 TEKS at 1'-0 cc all cross supports
and #14 TEKS @ 1'-6 on edge members &
sidelaps. Use #12 TEKS @ 6" cc all panel ends.
Line Interior to 10'-6" with 5/8" GPDW over
2 1/2" 25 Ga Studs at 24"c/c

NORTH ELEVATION


IVATION

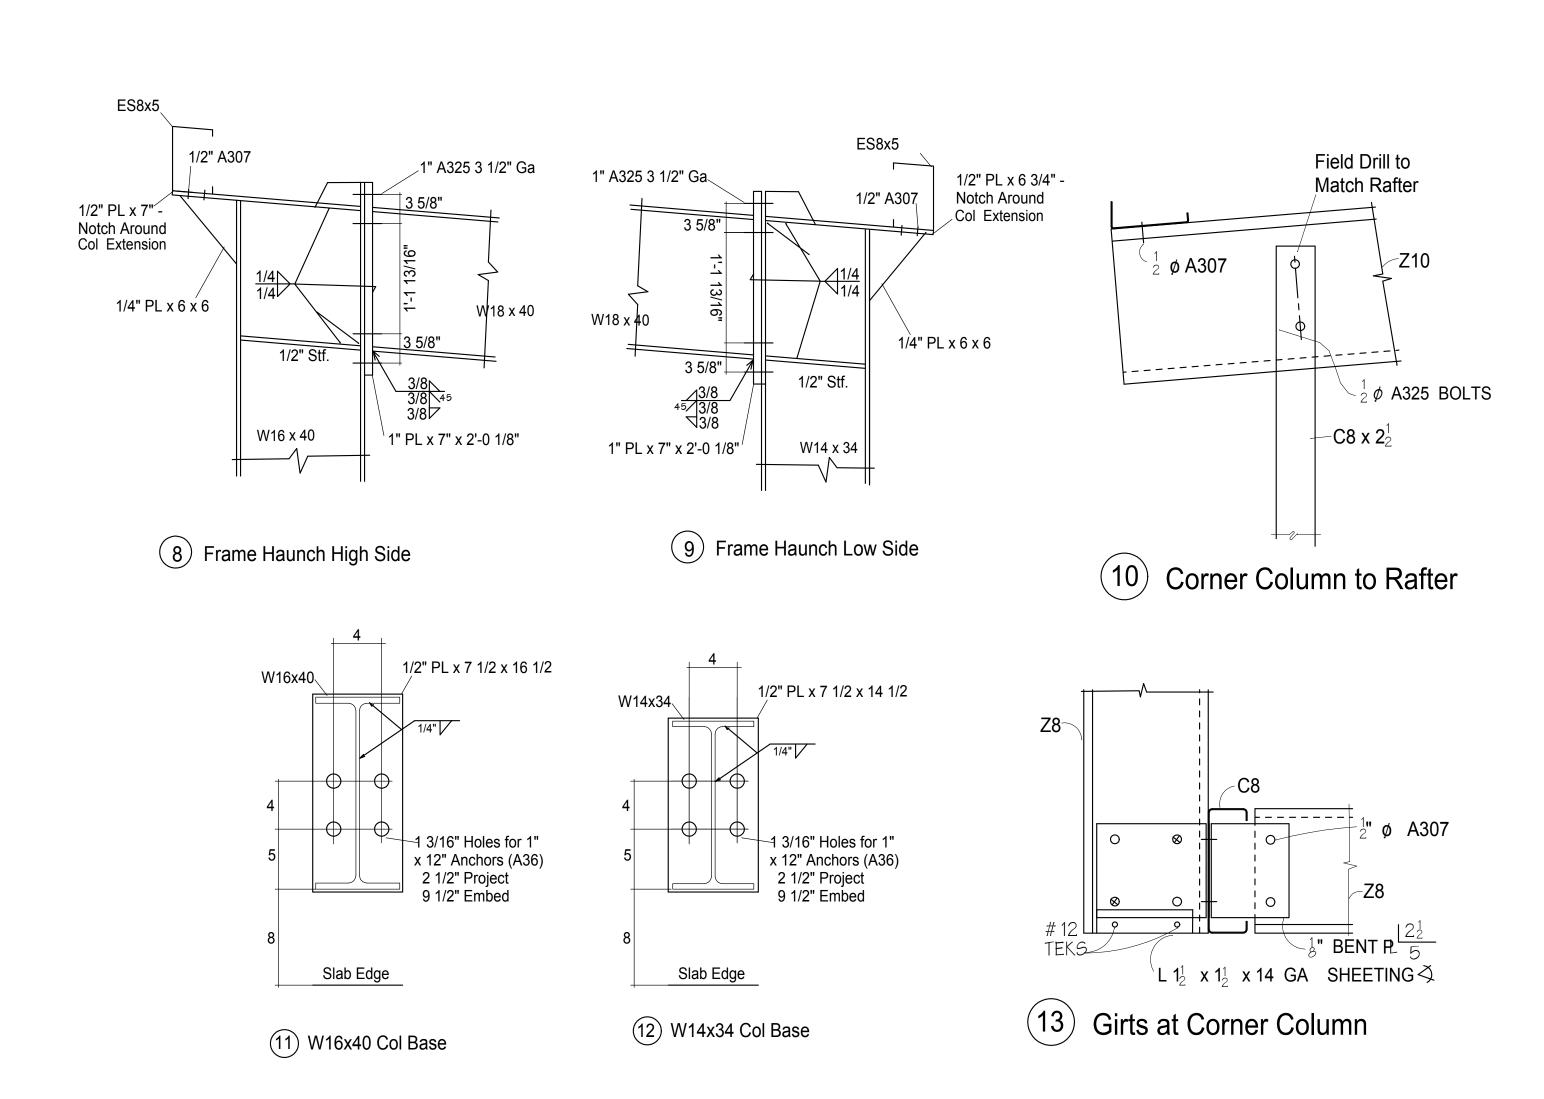

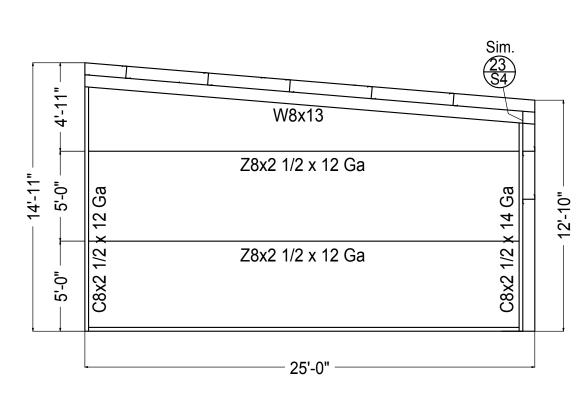





Sheet Wall with 26 Ga "PBR" panels.
Use #12 TEKS at 1'-0 cc all cross supports
and #14 TEKS @ 1'-6 on edge members &
sidelaps. Use #12 TEKS @ 6" cc all panel ends.
Line Interior to 8'-0" with 26 Ga "PBR" Panels.

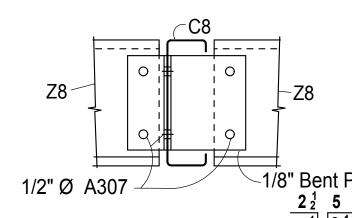


 $\begin{array}{c|c}
1/2 & 6 & 6 & 6 \\
\hline
2 & 5 \\
\hline
2 & 2 \\
2 & 2 \\
\hline
2 & 2 \\$

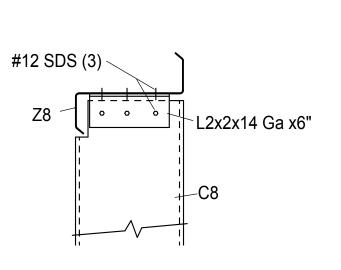

16) Jamb to Zee Girt

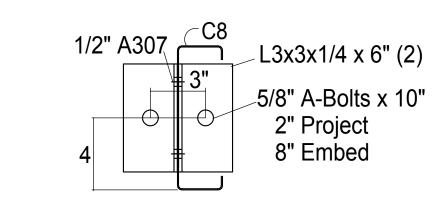

(15) Cee Col Base

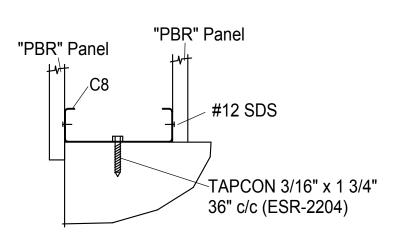

(17) Base Cee at Liner Panels

DRAWING:
DRAWING:
JJG
DATE
DATE

REVISIONS

These drawings are the property of W. Alan Kenson & Associates P.C.,

and may not be reproduced in any way without the written consent of

W. Alan Kenson & Associates, P.C

JOHN JAMES

Associates,

JJG

CHECKED BY
JJG


DATE
5/02/17


SCALE
3/16" = 1'-0"


JOB NO.
699

SHEET

S-3

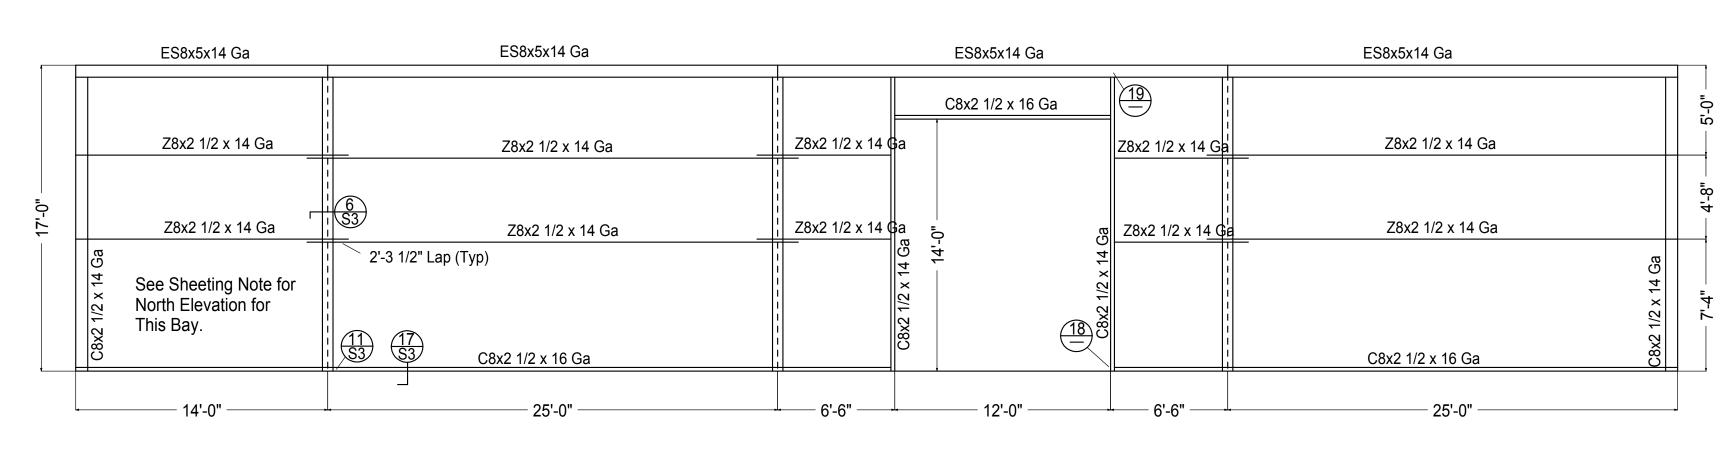

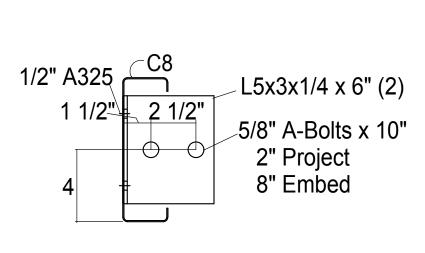

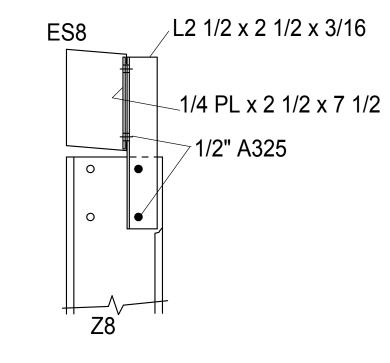

/3/16" PL x 5 1/2 x 5 1/2

18) Jamb Col Base


(19) Jamb to Eave Strut

WEST ELEVATION

Sheet Walls with 26 Ga "PBR" panels.
Use #12 TEKS at 1'-0 cc all cross supports
and #14 TEKS @ 1'-6 on edge members &
sidelaps. Use #12 TEKS @ 6" cc all panel ends.
Line Interior to 8'-0" with 26 Ga "PBR" Panels.

1	ES8x5x14 Ga	ES8x5x14 Ga	ES8x5x14 Ga	ES8x5x14 Ga	ES8x5x14 Ga
	Z8x2 1/2 x 14 Ga	Z8x2 1/2 x 14 Ga	Z8x2 1/2 x 14 Ga	Z8x2 1/2 x 14 Ga	Z8x2 1/2 x 14 Ga
0	Z8x2 1/2 x 14 Ga	Z8x2 1/2 x 14 Ga	Z8x2 1/2 x 14 Ga	Z8x2 1/2 x 14 Ga	Z8x2 1/2 x 14 Ga
	C8x2 1/2 x 14 Ga	C8x2 1/2 x 16 Ga	2'-3 1/2" Lap (Typ) 75	C8x2 1/2 x 16 Ga	See Sheeting Note for North Elevation for This Bay.
	20'-0"	25'-0"	25'-0"	25'-0"	14'-0"


1/2" A325 3/16 3/16 C8 W10 W10 1/4" PL x 5 1/2 x 6 1/4" PL x 6 x 6

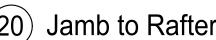


W10 3/16 1/2" A325 3/16 3/16 1/4" PL x 6 x 6

23) Jamb to Rafter


EAST ELEVATION

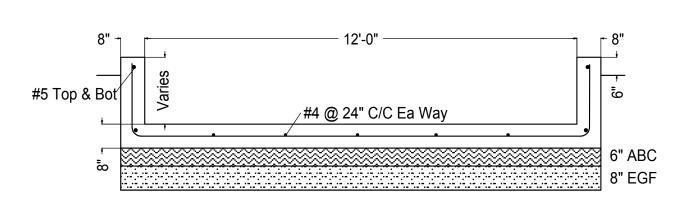

21) Truck Well Section

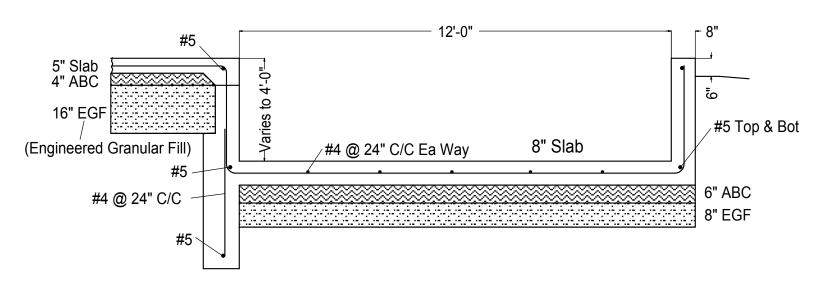

(22) Truck Well Section

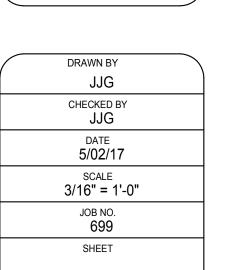

DRAWING:

REVISIONS

These drawings are the property of W. Alan Kenson & Associates P.C.,

and may not be reproduced in any way without the written consent of W. Alan Kenson & Associates, P.C.

JOHN JAMES

GLANCY ,4

Expires 12/31/17

P.C.

Associates,

Alan Kenson

GENERAL REQUIREMENTS

1 - PROVIDE VIBRATION ISOLATORS FOR ALL MECHANICAL EQUIPMENT SUPPORTED FROM STRUCTURE.

2 - PROVIDE CLEARANCES AS PER MANUFACTURER'S RECOMMENDATIONS.

3 - PITCH CONDENSATE DRAIN LINE 1/8" PER 12" RUN TOWARDS TERMINATION. INSULATE IN CONDENSATE DRAIN LINE WITH 3/8" CLOSED CELL "ARMIFLEX" TUBE INSULATION, TO PREVENT CONDENSATE DRIP.

4 - PROVIDE EQUIPMENT IDENTIFICATION PER IMC 2012.

5 - THE CONTRACTOR SHALL DO ALL NECESSARY CUTTING OF WALLS AND CEILING. NO STRUCTURAL MEMBER SHALL BE CUT WITHOUT PERMISSION FROM THE ARCHITECT. PATCH AROUND ALL OPENINGS TO MATCH EXISTING CONSTRUCTION.

6 - PRIOR TO THE CONTRACTOR ORDERING OR SETTING ANY AIR CONDITIONING EQUIPMENT, DUCTWORK, OR AIR DEVICE, HE SHALL VERIFY LOCATION OF PLACEMENT WITH STRUCTURAL DRAWINGS AND CONFIRM WEIGHTS, DISCHARGE CONFIGURATION, SIZES, ELECTRICAL CHARACTERISTICS AND ANY OTHER DIMENSIONAL DATA WHICH MIGHT AFFECT THE SUCCESSFUL INSTALLATION OF THE EQUIPMENT.

7 - KEEP ALL VENTS THROUGH ROOF AND EXHAUST DISCHARGE DUCTS A MINIMUM OF 10'-0" FROM OUTSIDE AIR INTAKES OR WINDOWS AND FROM ALL VERTICAL PORTIONS OF THE BUILDING.

8 - UPON COMPLETION AND TESTING OF AIR CONDITIONING EQUIPMENT, THE CONTRACTOR SHALL REPLACE ALL CONSTRUCTION AIR FILTERS WITH NEW FILTERS OF THE SIZED SPECIFIED BY THE MANUFACTURER.

DUCT CONSTRUCTION NOTES

1 - ALL DUCTWORK SHALL BE CONSTRUCTED AND INSTALLED IN ACCORDANCE WITH "ASHRAE GUIDE" AND "SMACNA STANDARDS" AND IN CONFORMANCE WITH REQUIREMENTS OF LOCAL BUILDING, MECHANICAL AND ENERGY CONSERVATION CODES. WHERE MORE THAN ONE REGULATION OR CODE APPLIES, THE MORE STRINGENT REQUIREMENT SHALL GOVERN.

2 - FLEXIBLE DUCTWORK SHALL COMPLY WITH THE CLASS I REQUIREMENTS OF THE NFPA BULLETIN NO. 90A AND SHALL BE INSULATED WITH 1" FIBERGLASS, SUPPORTED BY HELICALLY WOUND STEEL WIRE WITH REINFORCED METALIZED OUTER JACKET RATED FOR USE IN PLENUMS. ATTACHMENT SHALL BE WITH WORM DRIVE CLAMPS. LENGTH SHALL NOT EXCEED 6'-0"

3 - PROVIDE MANUAL BALANCING DAMPER AT EACH BRANCH DUCT TAKE OFF.

4 - ALL DUCTWORK JOINTS, LONGITUDINAL AND TRANSVERSE SEAMS AND CONNECTION ON DUCTWORK SHALL BE LISTED AND LABELED BY UL 181A OR 181B TAPES AND MASTICS.

5 - PROVIDE RADIUS ELBOWS, TURNING VANES, AND SPLITTER DAMPERS IN BRANCHES AND EXTRACTORS WHERE APPLICABLE.

6 - TURNING VANES SHALL BE INSTALLED IN ALL MITERED ELBOWS.

7 - TAKE-OFF FITTINGS SHALL BE CONICAL OR BELL MOUTH TYPE WITH BALANCING DAMPER.

8 - BRANCH DUCT SERVING DIFFUSERS SHALL BE SAME SIZE AS NECK DIAMETER.

9 - ALL DUCT DIMENSIONS SHOWN ARE INSIDE CLEAR DIMENSIONS. IF DUCT LINER IS USED FOR INSULATION, CONTRACTOR SHALL INCREASE DUCT SIZE ACCORDINGLY.

10 - HANGERS FOR SHEET METAL DUCTWORK SHALL BE INSTALLED AS REQUIRED BY 2012 IMC.

COORDINATION NOTES


1 - COORDINATE OPENING'S FOR GRILLES, REGISTERS, DIFFUSERS AND DUCTWORK WITH FRAMING CONTRACTOR PRIOR TO ROUGH-IN.

2 - COORDINATE EXACT LOCATION OF ALL GRILLES, REGISTERS AND DIFFUSERS WITH ARCHITECTURAL PLANS.

3 - LIGHTING & SPRINKLER HEADS TAKE PRECEDENCE OVER DIFFUSER LOCATION. CONTRACTOR SHALL MAKE NECESSARY ADJUSTMENTS TO DIFFUSERS TO AVOID ANY CONFLICT WITH LIGHTING LAYOUT & SPRINKLER HEADS.

4 - CONTRACTOR TO COORDINATE ALL FINAL THERMOSTAT LOCATIONS WITH OWNER & ARCHITECT PRIOR TO MOUNTING.

5 - ALL THERMOSTATS ARE TO BE MOUNTED AT A HEIGHT OF 48" ABOVE THE FLOOR LEVEL FOR DISABLED ACCESS.

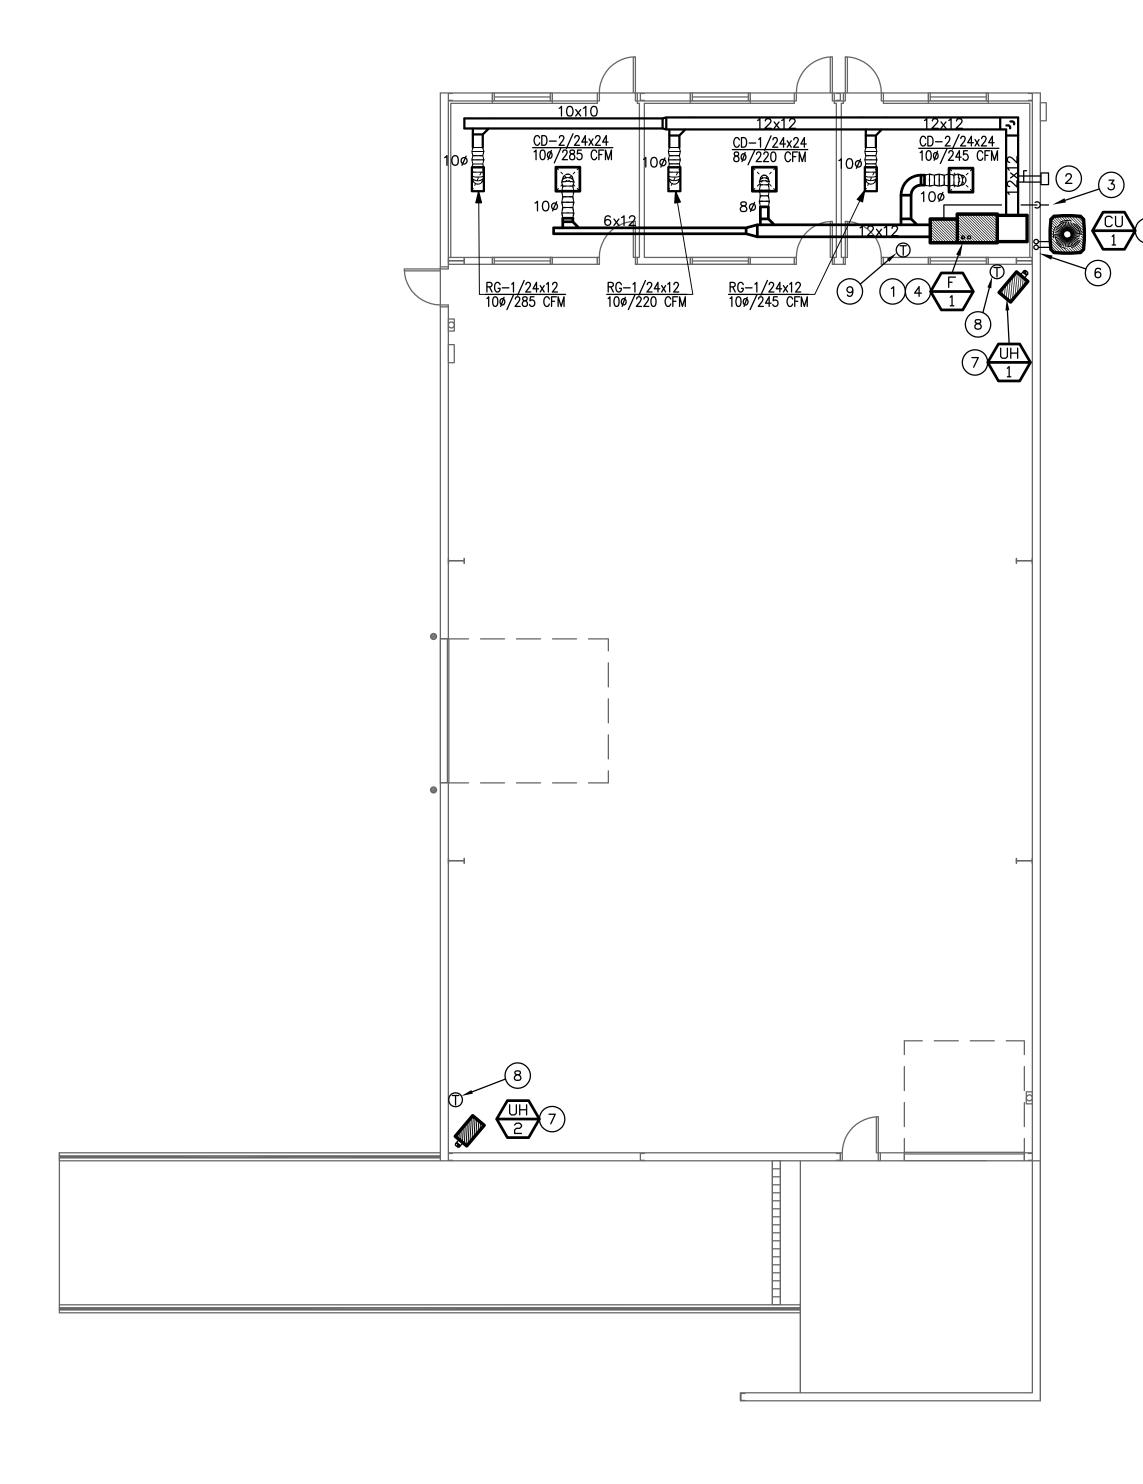






KEYNOTES

- STRUCTURE ABOVE CEILING. MAINTAIN ALL NECESSARY CLEARANCES AND MAINTENANCE ACCESS REQUIREMENTS.
- WC-8. INTAKE SHALL BE A MINIMUM OF 10' FROM EXHAUST DISCHARGE.
- (4) PVC COMBUSTION AIR INTAKE AND VENT PIPING UP THROUGH ROOF TO CONCENTRIC TERMINATION PER MANUFACTURER. SHALL BE IN ACCORDANCE TO INSTALLED LENGTH AND FITTINGS.
- NEW CONDENSING UNIT ON 4" CONCRETE PAD. PROVIDE CLEARANCES AS PER MANUFACTURER'S RECOMMENDATIONS. COORDINATE FINAL LOCATION WITH ARCHITECT AND STRUCTURAL ENGINEER PRIOR TO COMMENCING WORK.
- 6 SLEEVE REFRIGERANT LINES THROUGH INTO WALL AND ROUTE UP INTO CEILING SPACE AND TO FAN-COIL UNIT. SIZE AND INSTALL AS PER MANUFACTURER'S RECOMMENDATIONS.
- (7) GAS-FIRED UNIT HEATER SUPPORTED FROM STRUCTURE, WITH TYPE "B" FLUE UP THROUGH ROOF. COORDINATE UNIT HEATER MOUNTING HEIGHT.
- INSULATED SUB-BASE.
- WALL AT 48" ABOVE FINISHED FLOOR. VERIFY EXACT LOCATION AND MOUNTING HEIGHT WITH ARCHITECT/OWNER.

NEW HORIZONTAL NATURAL GAS FURNACE SUPPORTED FROM ROUTE AND CONNECT REFRIGERANT LINES FROM CONDENSING

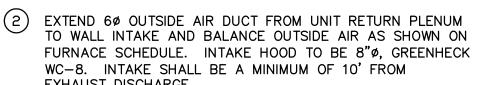

(3) EXTEND NEW 3/4" TYPE 'M' COPPER CONDENSATE DRAIN PIPING FROM UNIT CONNECTION AND ROUTE TO EXTERIOR. SLOPE ALL DRAIN PIPING AT A MINIMUM 1/8" PER FOOT TOWARD DISCHARGE LOCATION.

MANUFACTURER'S INSTALLATION INSTRUCTIONS FOR THE

8 PROVIDE UNIT HEATER WITH LOW VOLTAGE THERMOSTAT WITH

(9) PROVIDE HEATING/COOLING PROGRAMMABLE THERMOSTAT ON

SS

ens

REVISIONS

These drawings are the property of W. Alan Kenson & Associates P.C., and may not be reproduced in any way without the written consent of W. Alan Kenson & Associates, P.C.

33491

WILLIAM MARK

ODELL 🔨

DRAWN BY

CHECKED BY JOB NO. 699 SHEET

Design Group, LLC Consulting Engineers 611 West Delano Ave Prescott, AZ 86301 Project Surprise, AZ 85379 (928) 443.7353 #17028 (623) 444-6143

MECHANICAL SPECIFICATIONS

GENERAL REQUIREMENTS

GENERAL PROVISIONS WHICH MAKE SPECIFIC REFERENCE TO ELECTRICAL DIVISION ONLY ARE INCLUDED HEREIN FOR CLARITY AND SIMPLIFICATION OF SPECIFICATIONS WRITING AND ARE NOT PART OF THE MECHANICAL WORK. THE WORK OF DIVISION 15, MECHANICAL, IS SUBJECT TO THE CONDITIONS OF THE CONDITIONS OF THE CONTRACT, DIVISION 1, GENERAL REQUIREMENTS, AND APPLICABLE REQUIREMENTS OF OTHER PORTIONS OF THE CONTRACT DOCUMENTS. EXAMINE AND BECOME FAMILIAR WITH ALL CONTRACT DOCUMENTS AND COORDINATE THE MECHANICAL WORK ACCORDINGLY.

IT IS THE INTENTION OF THE SPECIFICATIONS AND DRAWINGS TO CALL FOR FINISHED WORK, TESTED AND READY FOR OPERATION. ANY APPARATUS, APPLIANCE, MATERIAL OR WORK NOT SHOWN ON THE DRAWINGS, BUT MENTIONED IN THE SPECIFICATIONS OR VICE VERSA, OR ANY INCIDENTAL ACCESSORIES NECESSARY TO MAKE THE WORK COMPLETE AND READY FOR OPERATION, EVEN IF NOT PARTICULARLY SPECIFIED, SHALL BE PROVIDED WITHOUT ADDITIONAL EXPENSE TO THE OWNER. SHALL THERE APPEAR TO BE DISCREPANCIES OR QUESTIONS OF INTENT IN THE CONTRACT. DOCUMENTS, REFER THE MATTER TO THE ARCHITECT FOR HIS DECISION BEFORE ORDERING ANY MATERIALS OR EQUIPMENT OR BEFORE THE START OF ANY RELATED WORK. THE DECISION OF THE ARCHITECT SHALL BE FINAL, CONCLUSIVE AND BINDING.

DRAWINGS AND DATA

DRAWINGS ARE GENERALLY DIAGRAMMATIC AND ARE INTENDED TO CONVEY SCOPE OF WORK AND TO INDICATE GENERAL ARRANGEMENT OF EQUIPMENT, DUCTS, CONDUITS, PIPING AND FIXTURES. THEY ARE NOT INTENDED TO SHOW EVERY OFFSET OR FITTINGS OR EVERY STRUCTURAL DIFFICULTY THAT MAY BE ENCOUNTERED DURING INSTALLATION OF THE WORK. LOCATION OF ALL ITEMS NOT DEFINITELY FIXED BY DIMENSIONS ARE APPROXIMATE ONLY. EXACT LOCATIONS NECESSARY TO SECURE BEST CONDITIONS AND RESULTS MUST BE DETERMINED AT PROJECT AND SHALL HAVE APPROVAL OF ARCHITECT BEFORE BEING INSTALLED. DO NOT SCALE DRAWINGS. IF SO DIRECTED BY ARCHITECT, WITHOUT EXTRA CHARGE, MAKE REASONABLE MODIFICATIONS IN LAYOUT AS NEEDED TO PREVENT CONFLICT WITH WORK OF OTHER TRADES OR FOR PROPER EXECUTION OF WORK. INCLUDE MINOR DETAILS NOT USUALLY SHOWN OR SPECIFIED, BUT NECESSARY FOR PROPER INSTALLATION AND OPERATION OF A SYSTEM OR PIECE OF EQUIPMENT IN BID PRICE.

CODES

INCLUDE IN WORK, WITHOUT EXTRA COST TO OWNER, LABOR, MATERIALS, SERVICES, APPARATUS, DRAWINGS (IN ADDITION TO CONTRACT DRAWINGS AND DOCUMENTS) REQUIRED TO COMPLY WITH APPLICABLE LAWS, ORDINANCES, RULES AND REGULATIONS. DRAWINGS AND SPECIFICATIONS TAKE PRECEDENCE WHEN THEY ARE MORE STRINGENT THAN CODES, ORDINANCES, STANDARDS AND STATUTES. CODES, ORDINANCES, STANDARDS AND STATUES TAKE PRECEDENCE WHEN THEY ARE MORE STRINGENT OR CONFLICT WITH DRAWINGS OR SPECIFICATIONS. FOLLOWING INDUSTRY STANDARDS, SPECIFICATIONS AND CODES ARE MINIMUM

A. APPLICABLE CITY, COUNTY, AND STATE MECHANICAL, ELECTRICAL, GAS, PLUMBING, HEALTH AND SANITARY CODES, LAWS AND ORDINANCES. B. 2012 INTERNATIONAL MECHANICAL CODE WITH LOCAL AMENDMENTS.

MATERIALS AND EQUIPMENT STANDARD PRODUCTS OF A REPUTABLE MANUFACTURER REGULARLY ENGAGED IN MANUFACTURE OF THE SPECIFIED ITEMS. WHERE MORE THAN ONE UNIT IS REQUIRED OF ANY ITEM, FURNISHED BY THE SAME MANUFACTURER, EXCEPT WHERE SPECIFIED OTHERWISE. INSTALL MATERIAL AND EQUIPMENT IN ACCORDANCE WITH MANUFACTURER'S RECOMMENDATIONS. SHOULD VARIANCE BETWEEN PLANS AND SPECIFICATIONS OCCUR WITH THESE, CONTACT ARCHITECT IMMEDIATELY SO THAT VARIATIONS IN INSTALLATION CAN BE KNOWN BY ALL PARTIES CONCERNED. PROVIDE EQUIPMENT FROM MANUFACTURER WHOSE PRODUCTS HAVE LOCAL REPRESENTATION.

EXECUTION

PROTECT EXISTING ACTIVE SERVICES (WATER, GAS, SEWER, ELECTRIC) WHEN ENCOUNTERED, AGAINST DAMAGE FROM CONSTRUCTION WORK. DO NOT PREVENT OR DISTURB OPERATION OF ACTIVE SERVICES WHICH ARE TO REMAIN. IF WORK MAKES TEMPORARY SHUTDOWNS OF SERVICES UNAVOIDABLE, CONSULT WITH OWNER AS TO DATES, PROCEDURES, AND ESTIMATED DURATION OF AT LEAST 10 WORKING DAYS IN ADVANCE OF DATE WHEN WORK IS TO BE PERFORMED. ARRANGE WORK FOR CONTINUOUS PERFORMANCE TO ASSURE THAT EXISTING OPERATING SERVICES WILL BE SHUT DOWN ONLY DURING THE TIME REQUIRED TO MAKE NECESSARY CONNECTIONS. IF A SYSTEM CANNOT SHUT DOWN, INSTALL TEMPORARY BYPASSES OR JUMPERS UNTIL CONNECTIONS ARE COMPLETE CONTRACTOR RESPONSIBLE FOR ALL COSTS INCURRED BY ABOVE SHUTDOWNS, INCLUDING BYPASS OR JUMPER INSTALLATIONS, FOR WORK PERFORMED UNDER THIS SECTION. IF EXISTING ACTIVE UTILITY SERVICES ARE ENCOUNTERED WHICH REQUIRE RELOCATION, MAKE REQUEST TO PROPER AUTHORITIES FOR DETERMINATION OF PROCEDURES. PROPERLY TERMINATE EXISTING SERVICES TO BE ABANDONED IN CONFORMANCE WITH REQUIREMENTS OF AUTHORITIES. WHERE CONNECTIONS OR DISRUPTIONS ARE MADE TO EXISTING SYSTEMS, REACTIVATE, REFILL, AND RECHARGE ALL COMPONENTS AND RESTORE SYSTEMS TO OPERATING CONDITIONS AT TIME OF DISRUPTION.

GUARANTEE

EACH COMPLETE SYSTEM GUARANTEED BY CONTRACTOR FOR A PERIOD OF ONE YEAR, FROM DATE OF ACCEPTANCE OF WORK BY OWNER IN WRITING, TO BE FREE OF DEFECTS OF MATERIALS AND WORKMANSHIP, AND TO PERFORM SATISFACTORILY UNDER ALL CONDITIONS OF LOAD OR SERVICE. THE GUARANTEES PROVIDE THAT ANY ADDITIONAL CONTROLS, PROTECTIVE DEVICES, OR EQUIPMENT BE PROVIDED AS NECESSARY TO MAKE THE SYSTEM OF EQUIPMENT OPERATE SATISFACTORILY. AND THAT ANY FAULTY MATERIALS OR WORKMANSHIP BE REPLACED OR REPAIRED. ON FAILURE OF GUARANTOR TO DO THE ABOVE AFTER WRITTEN NOTICE FROM OWNER, THE OWNER MAY HAVE THE WORK DOWN AT THE COST OF GUARANTOR. LOSS OF REFRIGERANT IS CONSIDERED A DEFECT IN WORKMANSHIP AND/OR EQUIPMENT, TO BE CORRECTED AS REQUIRED AT NO EXTRA COST

PROVIDE EXTENDED FIVE (5) YEAR FACTORY PARTS & LABOR WARRANTY ON ALL AIR CONDITIONING COMPRESSORS.

AIR CONDITIONING, HEATING AND VENTILATING

WORK UNDER THIS SECTION INCLUDES FURNISHING ALL LABOR, MATERIALS AND EQUIPMENT NECESSARY FOR THE REMODELING, INSTALLATION AND PLACING INTO OPERATION THE HEATING. VENTILATING AND AIR CONDITIONING WORK AS SPECIFIED HEREIN AND INDICATED ON THE

VERIFICATION OF DIMENSIONS:

SCALED AND FIGURED DIMENSIONS ARE APPROXIMATE ONLY. BEFORE PROCEEDING WITH WORK, CAREFULLY CHECK AND VERIFY AT THE SITE, AND RESPONSIBLE FOR PROPERLY FITTING EQUIPMENT AND MATERIALS TOGETHER AND TO THE STRUCTURE IN SPACES PROVIDED. DRAWINGS ARE ESSENTIALLY DIAGRAMMATIC AND MANY OFFSETS, BENDS, SPECIAL FITTINGS AND EXACT LOCATIONS ARE NOT INDICATED. CAREFULLY STUDY DRAWINGS AND PREMISES I ORDER TO DETERMINE BEST METHODS, EXACT LOCATIONS, ROUTES AND BUILDING OBSTRUCTIONS, PRESERVE HEADROOM, AND KEEP OPENINGS AND PASSAGEWAYS CLEAR.

CUTTING AND PATCHING:

CUT EXISTING WORK AND PATCH AS NECESSARY TO PROPERLY INSTALL THE NEW WORK. AS THE WORK PROGRESSES, LEAVE NECESSARY OPENINGS, HOLES AND CHASES, ETC., IN THEIR CORRECT LOCATIONS. IF THE REQUIRED OPENINGS, HOLES AND CHASES ETC., ARE NOT IN THEIR CORRECT LOCATIONS, MAKE THE NECESSARY CORRECTIONS AT NO COST TO THE OWNER. AVOID EXCESSIVE CUTTING AND DO NOT CUT STRUCTURAL MEMBERS WITHOUT CONSENT OF ARCHITECT.

REGULATIONS, PERMITS & INSPECTIONS

COMPLY WITH ALL APPLICABLE CODES, RULES AND REGULATIONS. ALL MATERIALS, EQUIPMENT AND WORK MUST CONFORM TO THE INTERNATIONAL MECHANICAL CODE. OBTAIN AND PAY FOR ALL REQUIRED PERMITS AND LICENSES. WHEN REQUIRED BY CODE, ALL WORK MUST BE INSPECTED AND APPROVED BY LOCAL AUTHORITIES.

DUCTWORK

ALL DUCTWORK FABRICATED AS PER LATEST INTERNATIONAL MECHANICAL CODE REQUIREMENTS AND SMACNA MANUAL. EXTENSION OF EXISTING DUCTWORK SHALL BE MADE WITH SOME MATERIAL. DUCTWORK SHALL BE CONSTRUCTED OF NEW HOT-DIPPED GALVANIZED SHEET METAL ASTM A-120 FOR EACH SIDE, WITH 1", 1 1/2 LB. DENSITY DUCT LINER. TAPE ALL CROSS-JOINTS IN SHEET METAL DUCT WITH HARDCAST. TAKE-OFF FITTINGS SHALL BE CONICAL SPIN-IN WITH QUADRANT DAMPER. TURNING VANES SHALL BE INSTALLED IN ALL MITERED ELBOWS. DUCT INSULATION: ACCEPTABLE MANUFACTURERS: CSG, JOHNS-MANSVILLE.

FLEXIBLE DUCT MAY BE USED FOR FINAL CONNECTION TO AIR DISTRIBUTION DEVICES, BUT SHALL NOT EXCEED 6 FEET IN LENGTH. FLEXIBLE DUCT SHALL HAVE A MINIMUM R-5 INSULATION VALUE.

DUCT INSULATION

DUCT SIZES ON DRAWINGS ARE "CLEAR INSIDE." INCREASE SHEET METAL SIZES ACCORDINGLY FOR LINED DUCTWORK. ADHESIVE AND INSULATING MATERIALS SHALL HAVE COMPOSITE FIRE AND SMOKE HAZARD RATINGS MAXIMUM 25 FOR FLAME SPREAD AND 50 FOR SMOKE DEVELOPED. ADHESIVES SHALL BE WATERPROOF.

LINED DUCTWORK - SEMI-RIGID GLASS FIBER INSULATION, 1 1/2 PCF, 1 1/2" THICK, THERMAL CONDUCTIVITY AT 75°. MAXIMUM 0.17 BTU/IN./SQ. FT./DEG./HR. MINIMUM "R-VALUE" SHALL BE 6.0.

WRAPPED DUCTWORK - FIBER GLASS BLANKET WITH FRK VAPOR RETARDING FACING. 1 1/2 PCF, 2" THICK, WITH A MINIMUM INSTALLED "R-VALUE" OF 6.0. (ASSUMES 25% COMPRESSION)

ACCEPTABLE MANUFACTURERS

THE FOLLOWING IS A LIST OF MANUFACTURERS WHOSE EQUIPMENT AND HVAC MATERIALS ARE ACCEPTABLE, SUBJECT TO CONFORMANCE WITH CONTRACT DOCUMENTS. VERIFY THAT THE EQUIPMENT WILL MEET ALL CAPACITIES SPACE ALLOCATIONS, AND THAT THE WEIGHTS WILL NOT EXCEED STRUCTURAL DESIGN LOADS.

FURNACE AND CONDENSERS: CARRIER, TRANE, YORK, UNIT HEATERS: STERLING, MODINE, REZNOR. GRILLES. REGISTERS. DIFFUSERS: KRUEGER. METAL-AIRE. TITUS. FLEXIBLE DUCT: GENFLEX, THERMAFLEX, OR EQUIVALENT. EXHAUST FANS: GREENHECK, LOREN COOK AND PENN VENTILATOR. DUCT AND PIPE INSULATION: KNAUF, OWENS-CORNING, MANVILLE, CERTAIN-TEED, PPG.

EXHAUST FANS

SIZE, CAPACITIES, AND TYPE AS INDICATED ON THE DRAWINGS. FURNISH COMPLETE WITH FACTORY CURBS/ROOF CAPS, BAROMETRIC DAMPER, SPEED CONTROL, DISCONNECT, STARTER (IF REQUIRED), AND BIRDSCREEN. FURNISH ROOF MOUNTED FANS WITH INSULATED ROOF CURB; PROVIDE CEILING MOUNTED FANS WITH WALL/ROOF CAP.

AIR SYSTEM BALANCING

AIR SYSTEMS AND AIR DISTRIBUTION TEST AND BALANCE: THE CONTRACTOR SHALL INCLUDE IN HIS BID TESTING AND AIR BALANCE OF AIR MOVING EQUIPMENT AND AIR DISTRIBUTING OR EXHAUSTING SYSTEMS AS HEREIN SPECIFIED. PROVIDE CERTIFIED REPORT TO ARCHITECT.

CONDENSING UNIT SCHEDULE

MADK	NOMINAL	MFG'R	MODEL #	COOLING	CAPACITY	DESIGN COND.	INDOOR	COIL ENT. AIR DB/WB	E	ELECTRICAL DATA		MINIMUM	REFRIGERANT	NOTES
MARK	TONS	MFG'R	MFG'R MODEL #	TOTAL SENS.	SENS.	DB/WB	COIL MODEL #		MCA	FUSE	V/Ø	SEER	REFRIGERANT	NOTES
CU-1	2	GOODMAN	GSX16024	21.9	17.5	95/67	SELECTED BY MFG.	76 °/ 62°	18.0	30	208/230 1ø	16	R-410A	(1)(2)(3)(4)(5)(6)(7)

- INSTALL UNIT PER MANUFACTURER'S WRITTEN DIRECTIONS. SLEEVE PIPING PENETRATIONS THROUGH ROOF, SEAL WATERTIGHT AND PROVIDE ESCUTCHEONS.
- UNIT SHALL BE PROVIDED WITH TRANE XL800 PROGRAMMABLE THERMOSTAT.
- PROVIDE 10-YEAR COMPRESSOR WARRANTY AND 5-YEAR FOR OTHER COMPONENTS.
- PROVIDE CONTROL TRANSFORMER IN UNIT CONTROL PANEL. PROVIDE UNIT COMPLETE WITH WEATHERPROOF CONTROL PANEL WITH ALL NECESSARY OVERLOADS AND CONTROL COMPONENTS.
- (5) RUN ALL REFRIGERANT PIPING FULL SIZE PER MFG'RS. INSTRUCTIONS.
- (6) PROVIDE INDOOR FAN COIL UNIT COMPLETE WITH MOTOR STARTER. (7) PROVIDE LOW AMBIENT CONTROL KIT FOR OPERATION DOWN TO 30°F.

FURNACE SCHEDULE

<u> </u>																		
MARK	NOMINAL	MFG'R	MODEL #	ORIENTATION	CFM	OSA	E.S.P.	HEA CAP	TING ACITY	VENT	VENTING	FUEL	Min. A.F.U.E.	ELECTRI	CAL DATA	FILTER	WEIGHT	NOTES
WARK	TONS	IVIFGR	MODEL #	ORIENTATION	CFIVI	USA	("W.G.)		OUTPUT	SIZE	TYPE	TOLL	A.I .U.L.	H.P.	V/Ø/Hz	TYPE	W/O COIL	NOTES
F-1	2	GOODMAN	GCSS92060	HORIZONTAL	750	60	0.50	60,000	55,260	2"	2-PIPE SEALED	PROPANE	92%	1/3	120/1/60	DISPOSABLE	112	1234

- (1) INSTALL WITH CLEARANCES PER MANUFACTURER'S RECOMMENDATIONS.
- 2 SIZE AND INSTALL 2 PIPE VENT PIPING PER MANUFACTURER'S INSTRUCTIONS FOR ACTUAL INSTALLED LENGTHS. PROVIDE CONCENTRIC ROOF OR WALL TERMINATION AS REQUIRED.
- (3) PROVIDE LEFT OR RIGHT CONNECTIONS AS REQUIRED FOR ACCESS.
- (4) HORIZONTAL UNIT.

\ <u>-</u> /'	C-/ONIT TILATER SCHEDULE													
501115			BLOWER MOTOR HEATER											
EQUIP. NO.	MANUFACTURER	MODEL NO.	SERVICE/ LOCATION	CFM	ESP	MIN. THROW	HP	VOLTS/ PHASE	FUEL	MAX. INPUT MBH	MIN. OUTPUT MBH	FLUE (DIA.)	WT. (LBS)	REMARKS
1	REZNOR	F-100	SERVICE BAY	1250	0	50'	1/30	120/1	PROPANE	100	80	5" OVAL	97	1 2 3
2	REZNOR	F-100	SERVICE BAY	1250	0	50'	1/30	120/1	PROPANE	100	80	5" OVAL	97	1 2 3

- PROVIDE UNIT HEATER WITH LOW VOLTAGE THERMOSTAT WITH INSULATED
- 2) PROVIDE UNIT WITH ELECTRONIC SPARK IGNITION.
 - (3) PROVIDE UNIT WITH 2-POINT SUSPENSION KIT.

350RFL 10ø NECK. 1" FILTER

GRI	GRILLES/REGISTERS/DIFFUSERS SCHEDULE												
MARK	DESCRIPTION	MODULE SIZE	TYPE	OBD	FRAME	MATERIAL	FINISH	MANUF.	MODEL	REMARKS			
CD-1	SUPPLY DIFFUSER	24" × 24"	ROUND	NO	SURFACE	STEEL	WHITE	TITUS	TMS	8ø NECK			
CD-2	SUPPLY DIFFUSER	24" x 24"	ROUND	NO	SURFACE	STEEL	WHITE	TITUS	TMS	10ø NECK			
				l									

SURFACE

OUTSIDE AIR CALCULATION

RETURN GRILLE

Outside Air for Unit F-1

Space	Area	Occ Density	Rp	Pz	Ra	Az	Vbz
Office	609	5	5	3.045	0.06	609	51.8
Balance F-1 to 52 CFM		•		Total N	et OSA Re	equired	52

SINGLE DFL

6.2.2.1 Breathing Zone Outdoor Airflow. The design outdoor airflow required in the breathing zone of the occupiable space or spaces in a zone, i.e., the breathing zone outdoor airflow (V_{ba}) , shall be determined in accordance with Equa-

$$V_{bz} = R_p \cdot P_z + R_a \cdot A_z \tag{6-1}$$

 $A_z = zone floor area$: the net occupiable floor area of the zone m2 (ft2)

 $P_z = zone population$: the largest number of people expected to occupy the zone during typical usage. If the number of people expected to occupy the zone fluctuates, P_{τ} may be estimated based on averaging approaches described in Section 6.2.6.2

> Note: If P₂ cannot be accurately predicted during design, it shall be an estimated value based on the zone floor area and the default occupant density listed in Table 6-1.


 R_n = outdoor airflow rate required per person as determined from Table 6-1

 R_a = outdoor airflow rate required per unit area as determined from Table 6-1

Note: These values are based on adapted occupants.

Design Group, LLC Consulting Engineers 611 West Delano Ave Prescott, AZ 86301 Project Surprise, AZ 85379 (928) 443.7353 #17028 (623) 444-6143 REVISIONS


These drawings are the property of W. Alan Kenson & Associates P.C. and may not be reproduced in any way without the written consent of

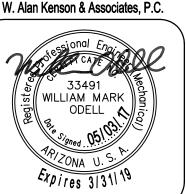


SSOC

DRAWN BY CHECKED BY


DATE JOB NO. SHEET

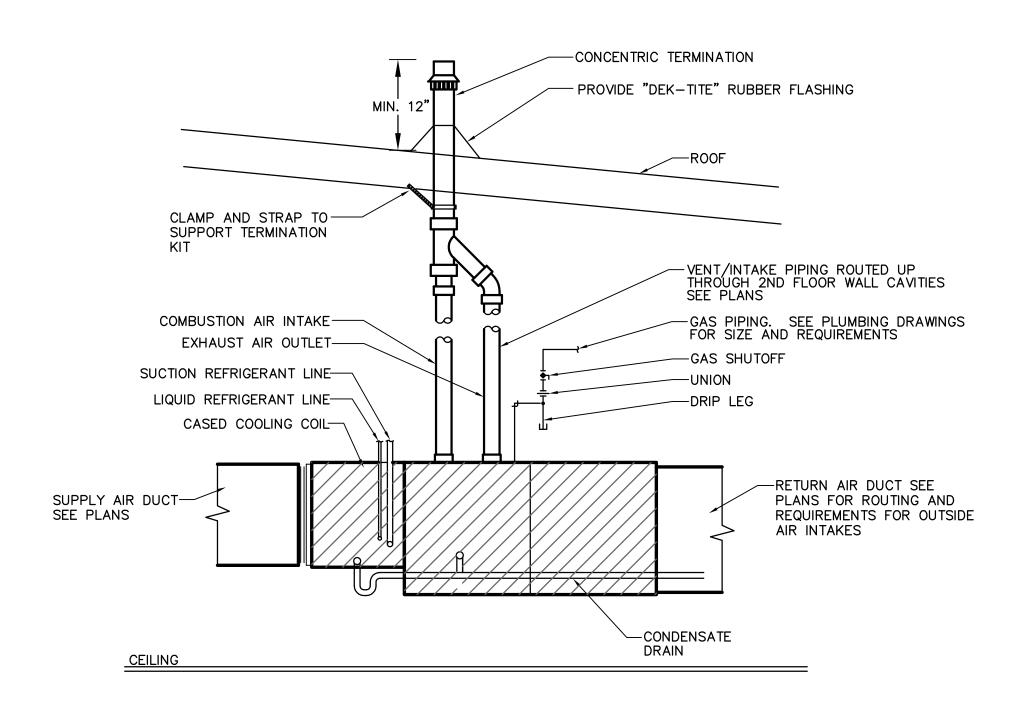


HORIZONTAL GAS FURNACE DETAIL

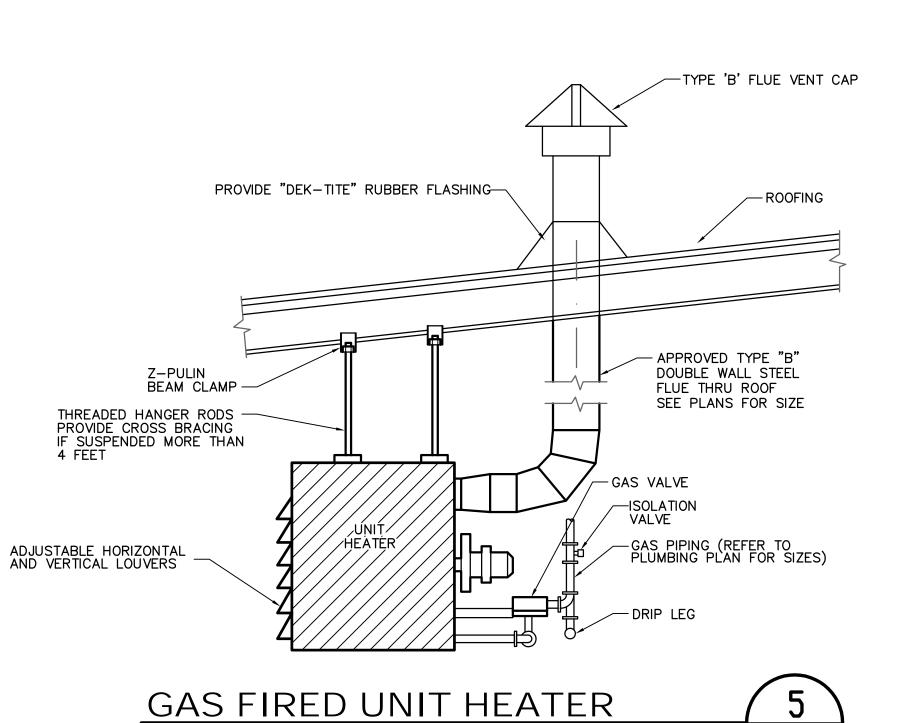


M3.1

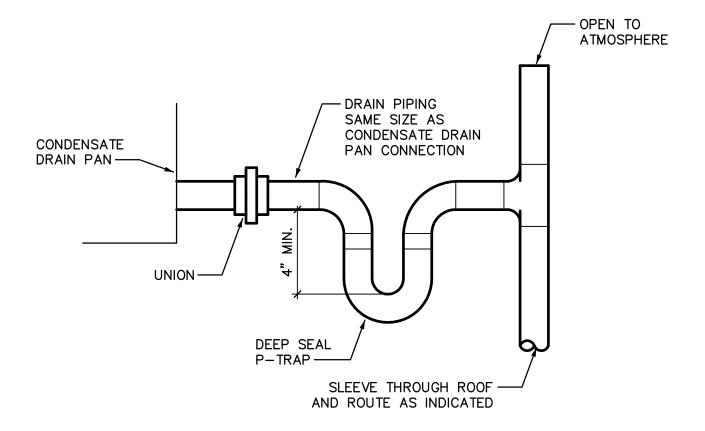



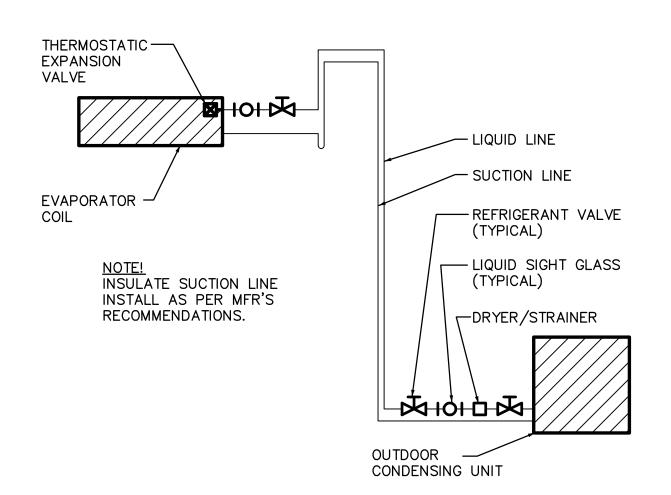

SPLIT SYSTEM REFRIGERANT PIPING DETAIL NOT TO SCALE M3.1

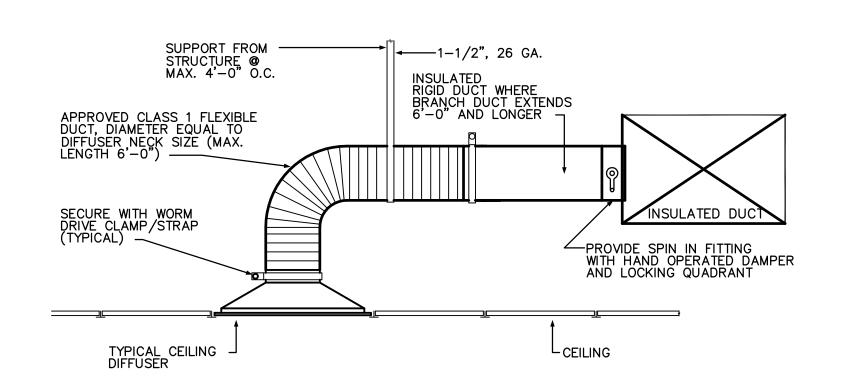






REVISIONS

These drawings are the property of W. Alan Kenson & Associates P.C., and may not be reproduced in any way without the written consent of W. Alan Kenson & Associates, P.C.

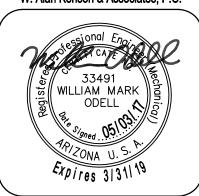

ssociates,


PROJECT:

DRAWING:

DRAWN BY CHECKED BY JOB NO. 699

M3.1

SHEET

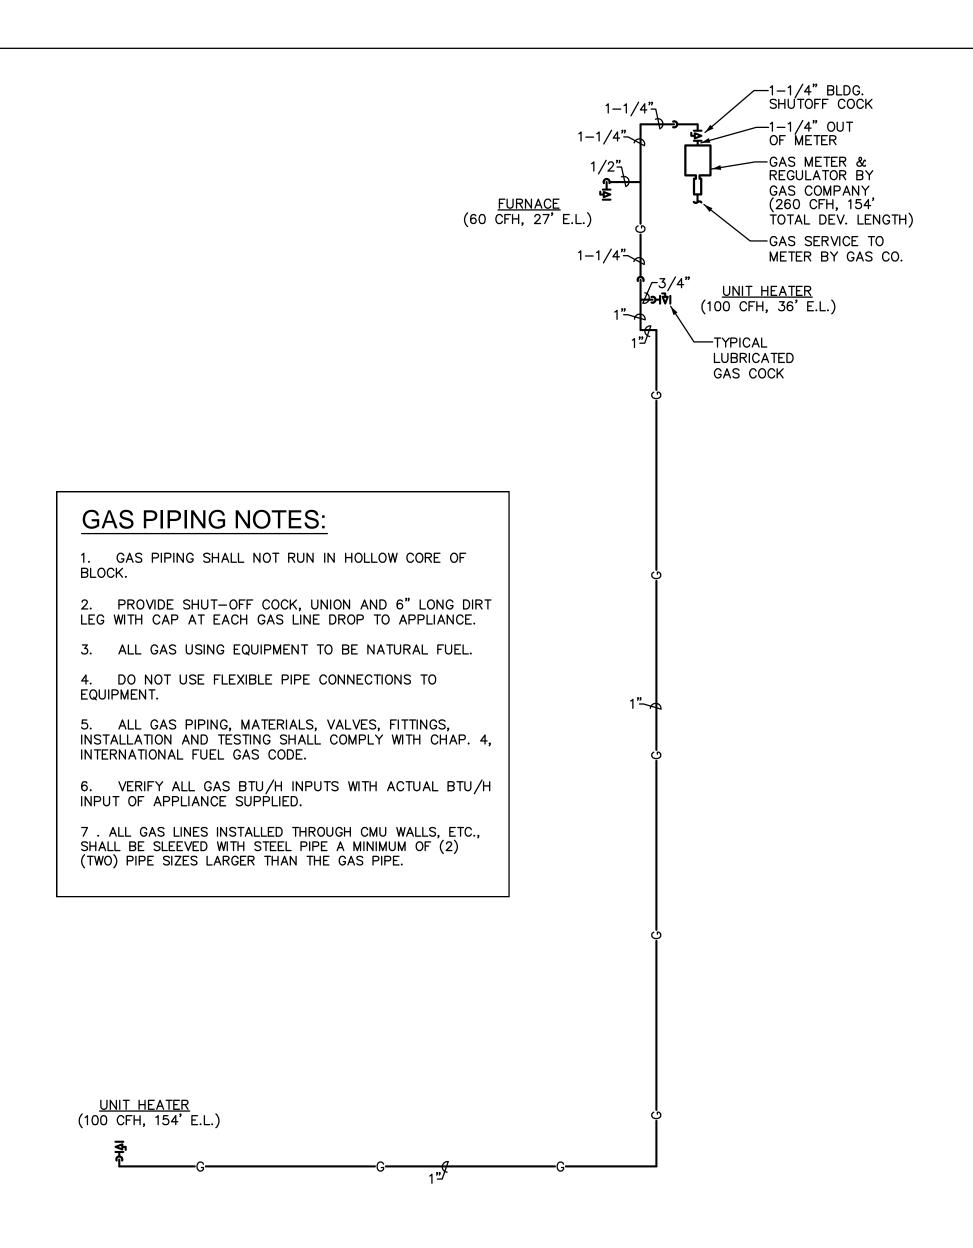

GAS PIPING DIAGRAM

PLUMBING FIXTURE SPECIFICATIONS

SYMBOL DESCRIPTION

TRENCH DRAIN: ABT, INC. "POLYDRAIN" PRESLOPED TRENCH DRAIN SYSTEM, CONSISTING OF INTERLOCKING, PRECAST MODULAR TRENCH DRAIN SECTIONS. TRENCH AND BASIN BODIES SHALL BE FORMED OF CHEMICAL RESISTANT POLYESTER POLYMER CONCRETE MATERIAL. STARTER SECTIONS SHALL HAVE APPROPRIATE SEALING CAPS. PIPE OUTLETS SHALL BE PROVIDED AS LOCATED ON THE DRAWINGS. FURNISH WITH MODEL 512AF DUCTILE IRON FRAME AND GRATE ASSEMBLY.


PLUMBING SPECIFICATIONS:

GENERAL

1..1 Scope: Work under this section includes coordinating and furnishing all labor and material necessary to install a complete plumbing system as shown and specified and in accordance with the codes. Contractor shall pay for all permits, meters, fees, city inspections, legal notices, etc., as required.

- 1..2 Submittals: Within 15 days after award of contract, submit 8 copies of all items.
- 1..3 Record Drawings: Provide a set to the Architect at completion of project.
- 1..4 Instructions: Provide maintenance manual and instruct Owner in the proper operation and maintenance of the equipment.
- 1..5 Guarantee: One year on labor, material and equipment.
- 2. PRODUCTS
- 2..1.1 Gas Piping:
- 2..1.1.1 (Above grade, exterior): All pipe sizes, black steel pipe, Schedule 40, wrought steel buttwelded fittings.
- 2..1.1.2 (Above grade, inside building): Schedule 40 black steel. Pipe fittings shall conform to the following:
- Pipe 2" and Smaller: Malleable iron threaded fittings.
- Pipe 2-1/2" and Larger: Wrought steel buttwelded fittings.
- 2..2 Valves:
- 2..2.1 Gas Valves, 1/2" and Smaller: Milwaukee BB-1-102.
- 2..2.2 Gas Valves, 1" to 1-1/2": Rockwell-Nordstrom #142 with #555 lubricant for natural gas
- 2..2.3 Gas Valves, 2" and Larger: Rockwell—Nordstrom #143 with #555 lubricant for natural gas

- 2..3 Pipe Hangers and Supports: Fee & Mason Figure 103 clevis hanger for insulated pipe and Figure 104 clevis hanger for cast iron pipe. Install #500 Trisolators on uninsulated copper lines at all hangers and wall penetrations.
- 2..4 Acceptable Manufacturers: The following is a list of manufacturers whose equipment is acceptable as to manufacturer, subject to conformance with all drawings, specifications and addenda items:
- Valves: Milwaukee, Rockwell-Nordstrom, Butterball.
- Hangers: Grinnell, Fee & Mason, Elcen, Kin-Line, F & S, B-Line, Michigan.
- 3. EXECUTION
- 3..1 Tests and Inspections:
- 3..1.1 All work to be tested and approved before covering as directed by Architect. Remake all
- 3..1.2 Gas System: Hold at 50 psi pneumatic for four hours with no pressure loss.
- 3..2 Flashing, Sleeves and Escutcheon Plates:
- 3..2.1 Flashing: Supply flashing for all vent pipe and other types of piping through roof to be installed with roofing. Flash vents with Stoneman S1300—4 or with sheet lead weighing not less than 4 pounds per square foot or equal. Extend flashing into roofing at least 10" from vent and turn flashing over and down into vent opening.
- 3..2.2 Sleeves: Use 20 gauge galvanized steel sleeves around pipes passing through masonry walls and concrete slabs.
- 3..2.3 Escutcheon Plates: Install cast brass split ring with setscrew at all locations where exposed pipes pass through walls, floors and/or ceilings. Provide polished chrome-plated escutcheons in finished rooms, all others polished brass.

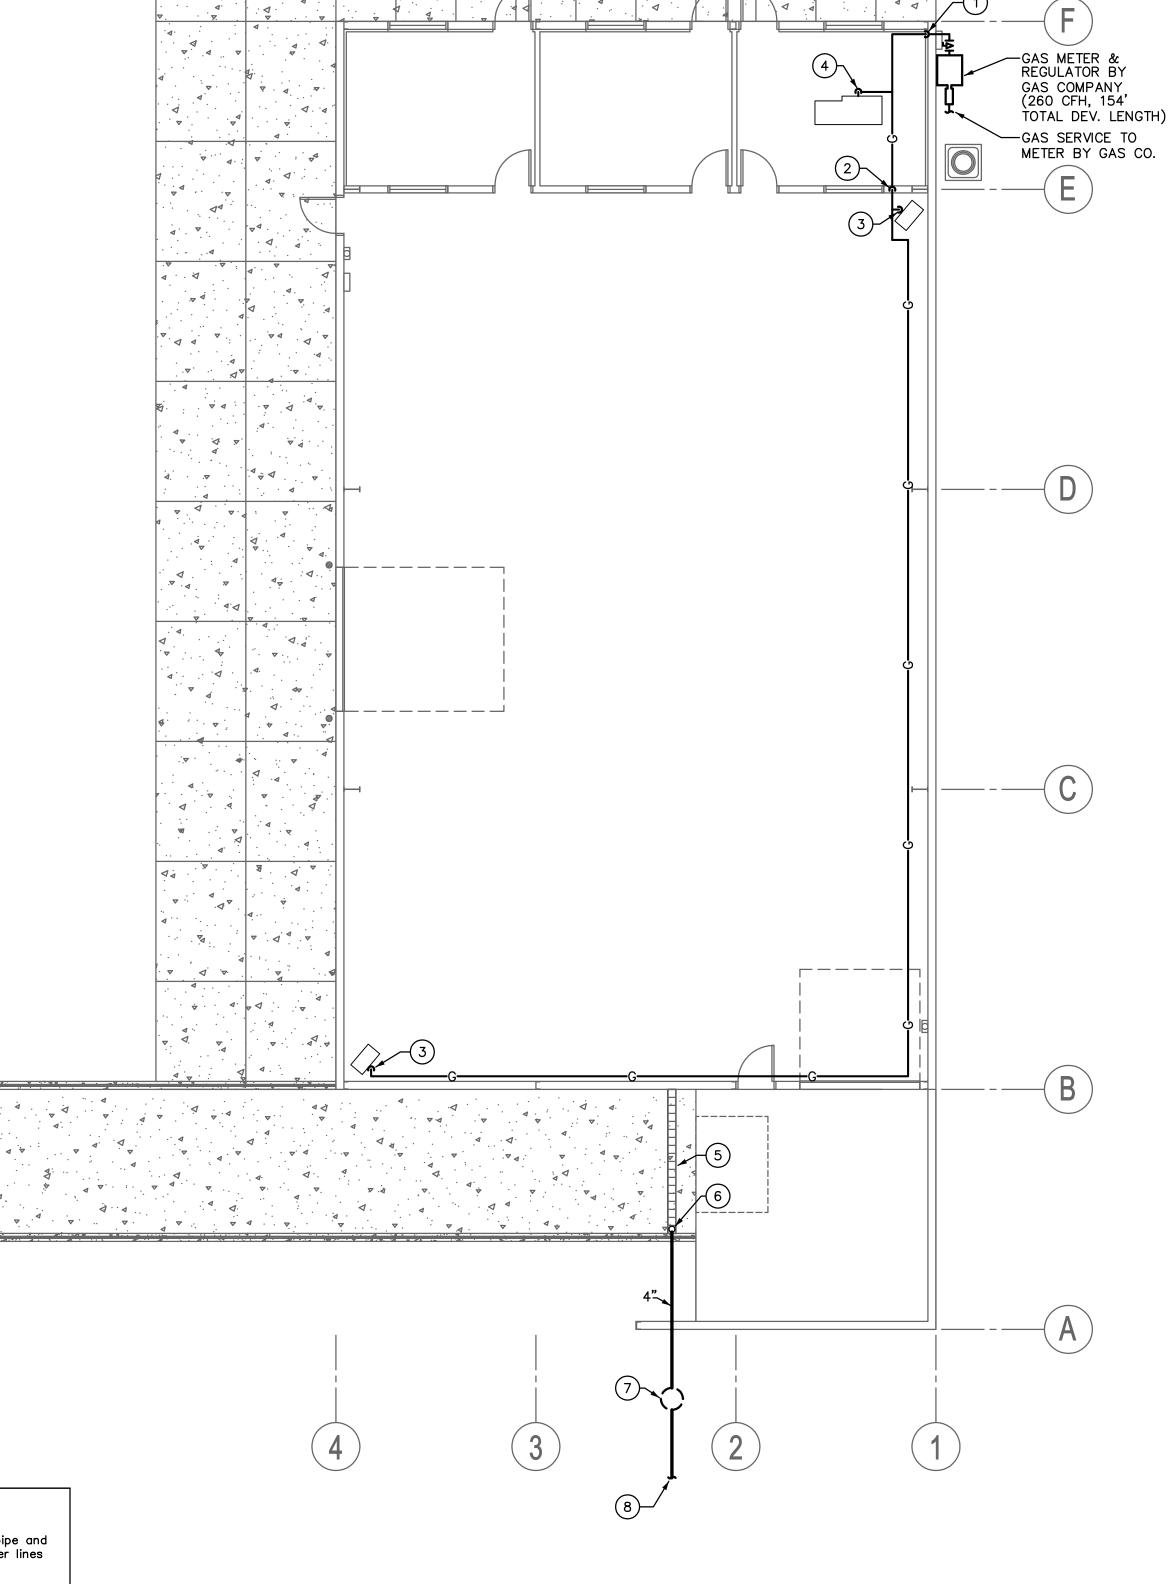

Plumbing Plan

PLUMBING LEGEND										
SYMBOL	ABBR.	DESCRIPTION								
ı √ ı	SOC	SHUTOFF COCK								
<u>——</u> с—	G	NATURAL GAS PIPING								
		PUMP DISCHARGE PIPING								

Scale: 1/8"=1'-0"



KEYNOTES

1) GAS PIPING OUT OF METER, ENTER BLDG. & RISE TO ROUTE ABOVE CEILING.

(2) GAS PIPING RISE TO ROUTE AT ROOF.

3 GAS PPING DOWN TO UNIT HEATER, PROVIDE LUBRICATED GAS COCK & 6" DIRT LEG WITH THREADED PLUG.

(4) GAS PIPING CONNECTION TO ATTIC MTD. FURNACE. PROVIDE LUBRICATED GAS COCK & 6" DIRT LEG WITH THREADED

(5) TRENCH DRAIN <u>TD-1</u>.

6 4" CONNECTION TO BOTTOM OF TRENCH

7 PACKAGED SUMP PUMP SYSTEM EQUAL TO "LIBERTY PUMPS" PRO-370 SERIES, #P372LE51, CONSISTING OF 1/2 HP/120V CAST IRON PUMP WITH INTEGRAL FLOAT SWITCH, 2" DISCHARGE; 41 GALLON CAPACITY. 24" DIAMETER x 24" HIGH POLYETHYLENE BASIN WITH INTEGRAL ANTI-FLOTATION COLLAR AND TORQUE STOPS; AND COVER WITH INTEGRATED RUBBER SEALS. PROVIDE CONCRETE RISER RINGS AS REQUIRED TO MEET GRADE & TRAFFIC RING & COVER.

(8) 2" PUMP DISCHARGE TO RETENTION.

These drawings are the property of

W. Alan Kenson & Associates P.C. and may not be reproduced in any way without the written consent of W. Alan Kenson & Associates, P.C.

REVISIONS

33491 WILLIAM MARK ODELL 🔨


SSO

DRAWN BY

CHECKED BY DATE


> 699 SHEET


JOB NO.

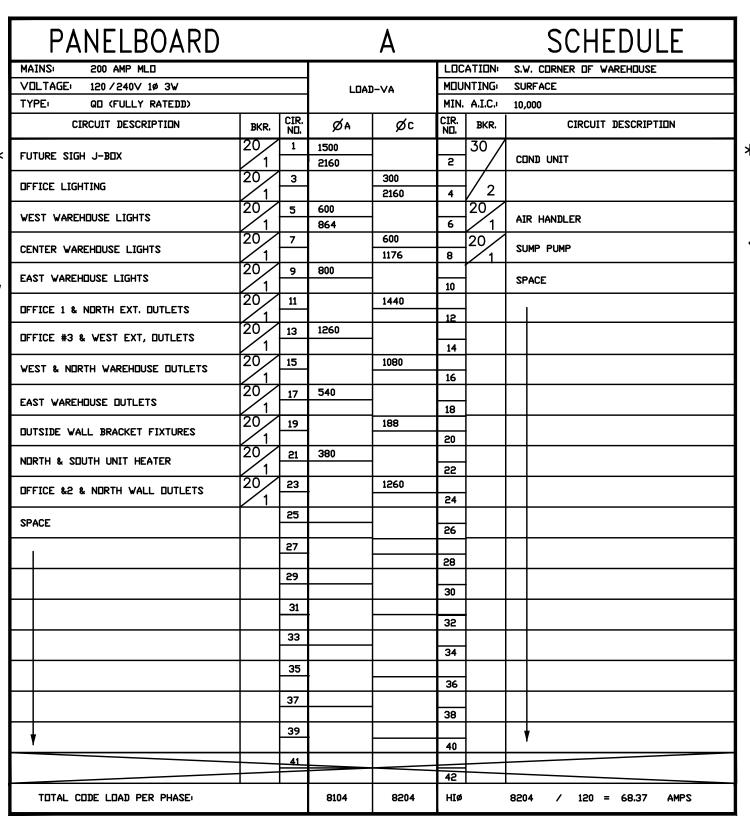

PANELBOARD SYMBOLS

- ★ CONTINUOUS DUTY/LARGEST MOTOR © 125%
- PROVIDE BREAKER W/ HANDLE "LOCK-ON" DEVICE
- ◆ PROVIDE BREAKER W/ HANDLE "LOCK-OFF" DEVICE
- ▲ INDIVIDUAL PHOTO CELL EACH FIXTURE SHUNT TRIP CIRCUIT BREAKER
- KITCHEN EQUIPMENT © 65% per nec 220-20
- O EXISTING BREAKER W/ NEW LOAD
- A NEW BREAKER W/ NEW LOAD

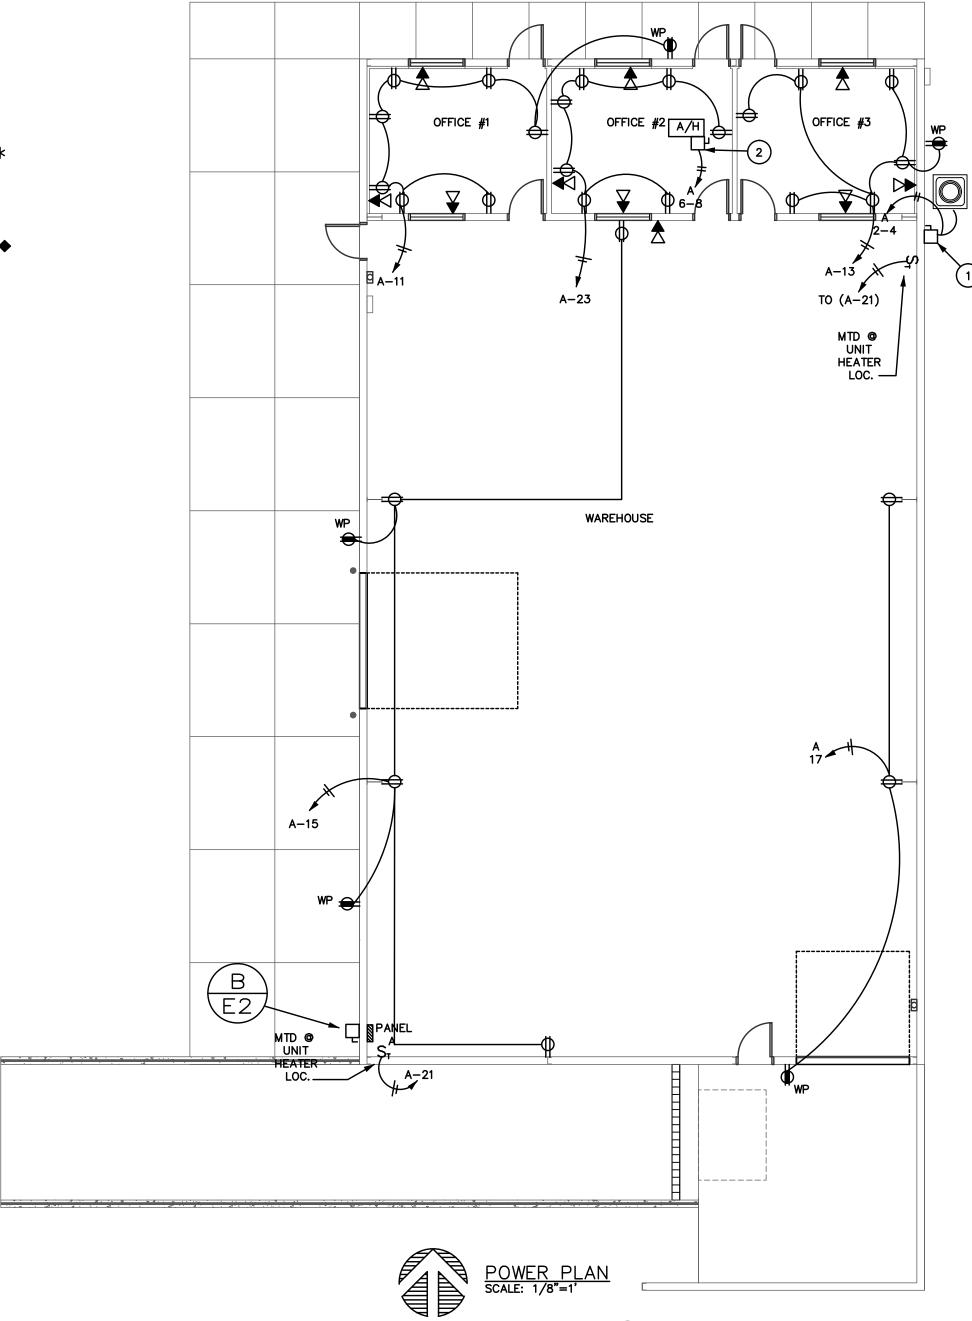

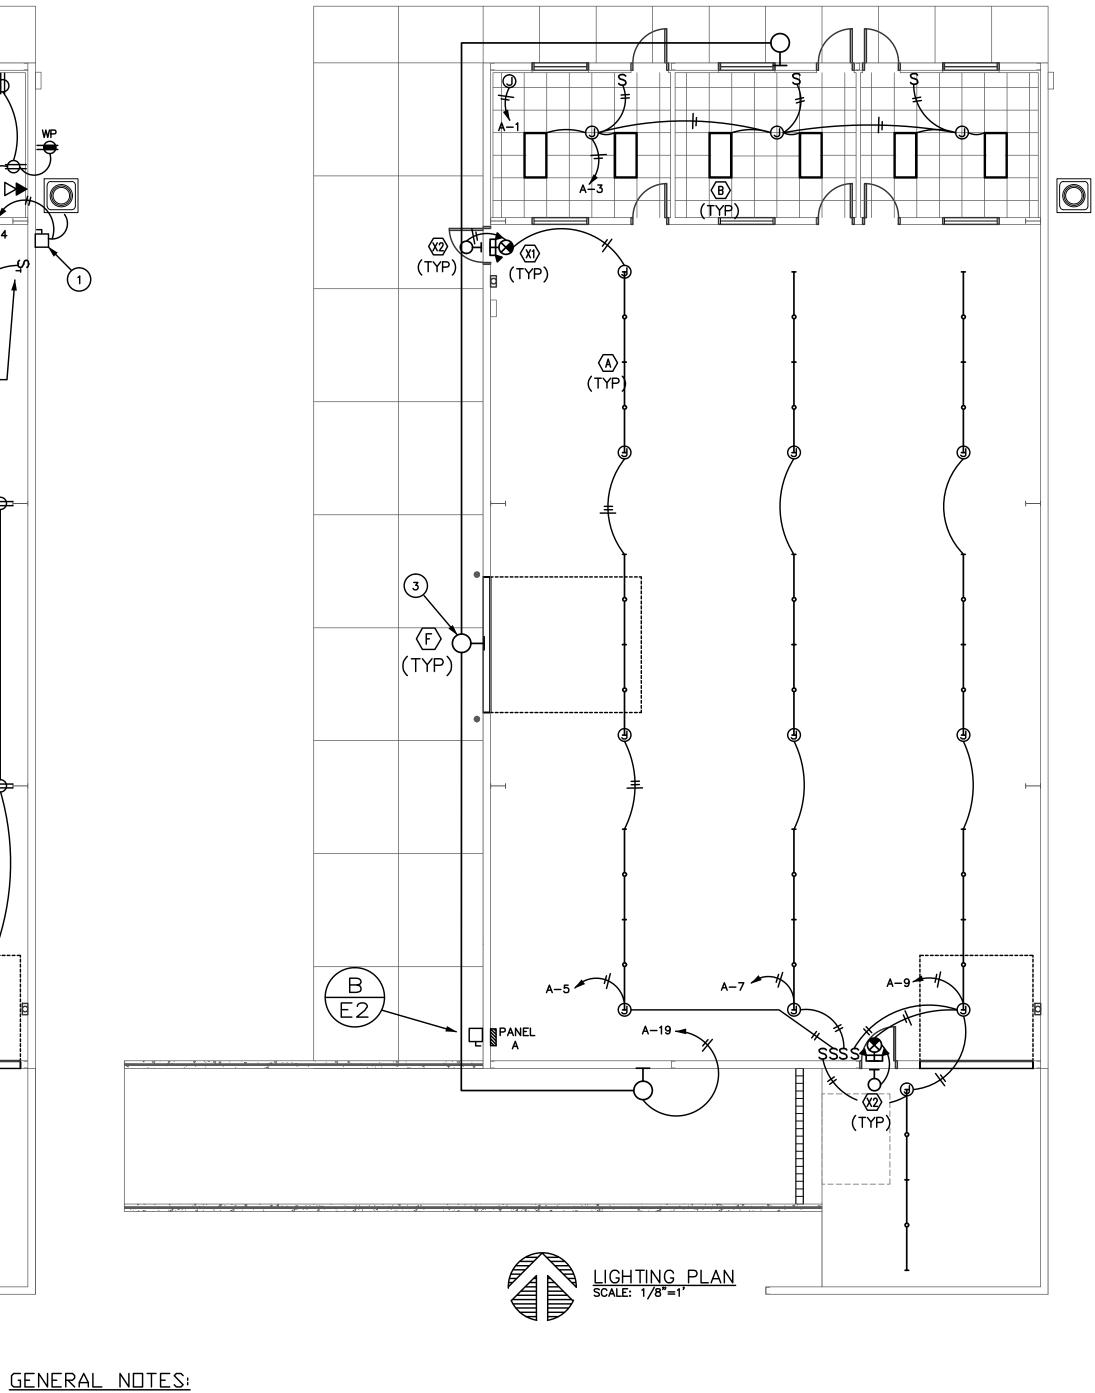

1 30/2P WT DISC FUSE PER MFR REQ'MTS FED W/ 2-#10 THWN CU., 1-#10 GND IN 1/2"C

2 30/2P WT DISC FUSE PER MFR REQ'MTS FED W/ 2-#12 THWN CU., 1-#12 GND IN 1/2"C

PROVIDE CIRCUIT W.T. CONNECTION FOR SUMP PUMP PER MFR'S REQ'MTS. ADD LOCK OFF DEVICE ON CIRCUIT BREAKER (IN PANEL) FOR SUMPP PUMP DISCONNECTING MEANS.

3 EXTERIOR LIGHTS FURNISHED WITH PHOTO CELL AS PART OF FIXTURE (TYP 3).

	LIGH	ΓΙΝΟ	G FIXTU	JRE S	SCHE	DULE
TYPE	MANUFACTURER AND MODEL NO.	VOLTS	LAMPS	MOUNTING	FINISH	REMARKS
A	LITHONIA ZL1NL485000FSTMVOLT35K80CRIV	VH ^{MVOLT}	42W LED	SURFACE		SURFACE MOUNT
В	LITHONIA 2GTL472LLP835	120	40 LED	RECESSED		
E1	LITHONIA ELM2 LED	MVOLT	INCLUDED W/FIX 1.5W	SURFACE ©7' AFF		PROVIDE 90 MIN BATTTERY BACKUP USE IN ALL HALLWAY AREAS.
F	LITHONIA WSTLEDP340KVWMVOLTPEDDBXD	MVOLT	50 LED	WALL @15' AFG		EXTERIOR WALL LIGHTING CONTROLLED BY INDIVIDUAL PHOTO CELL
X1	LITHONIA LQMSW1R	MVOLT	INCLUDED W/FIX	WALL CEILING		PROVIDE LED TYPE ONLY(W/ EMERG. HEADS) FURNISH WITH EM BATTERY BACKUP
X2	LITHONIA AFN	MVOLT	INCLUDED W/FIX	WALL CEILING		PROVIDE EMERGENCY EGRESS LIGHTING FURNISH WITH EM BATTERY BACKUP

HES Inc. CONSULTING ENGINEERS Haines Engineering Services, Inc. 809 WEST MARYLAND AVENUE CELL (602) 818-0068 PHOENIX, AZ 85013 FAX (602) 992-1541 311 STERBA PRESCOTT, AZ 86305

REVISIONS

These drawings are the property of W. Alan Kenson & Associates P.C.


and may not be reproduced in any way without the written consent of

W. Alan Kenson & Associates, P.C.

Expires 3/31/18

DRAWN BY CHECKED BY DATE JOB NO. **699** SHEET

PROJE

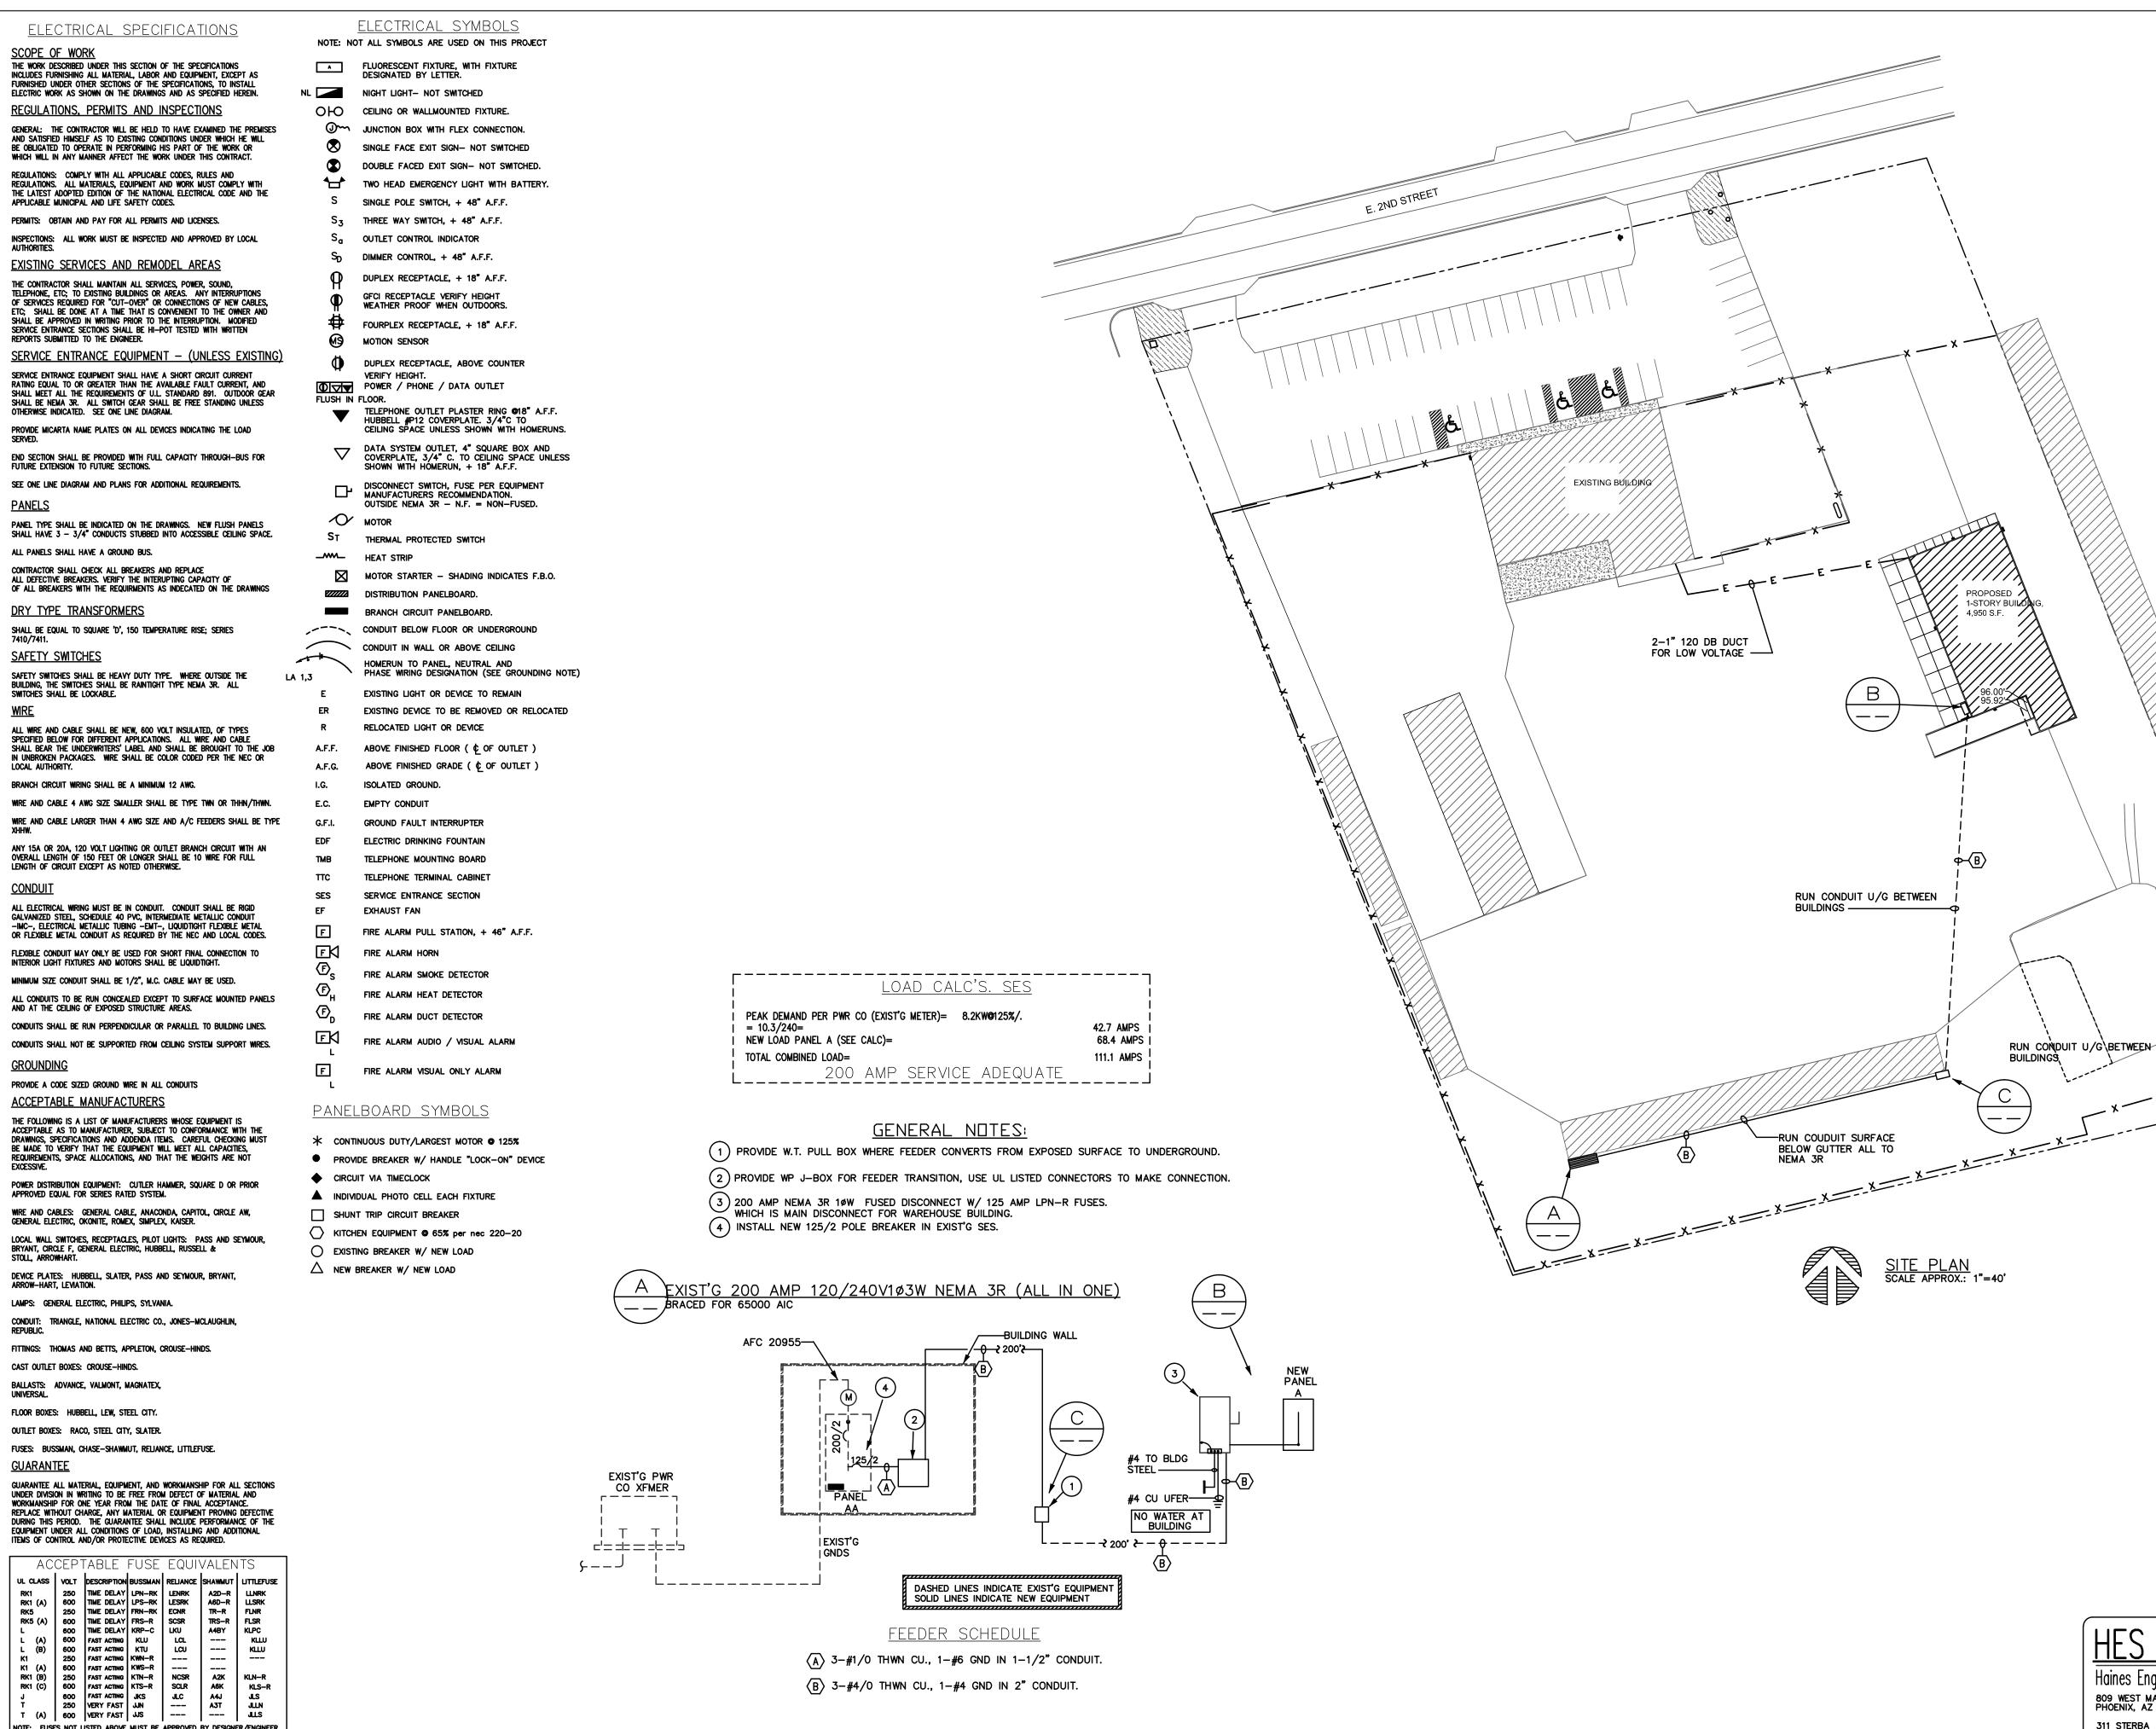

Expires 3/31/18 12 15 DRAWN BY

REVISIONS

These drawings are the property of

W. Alan Kenson & Associates P.C

and may not be reproduced in any

way without the written consent of W. Alan Kenson & Associates, P.C.

> DATE JOB NO. **699** SHEET

HES Inc. CONSULTING ENGINEERS

809 WEST MARYLAND AVENUE CELL (602) 818-0068 PHOENIX, AZ 85013 FAX (602) 992-1541

(520) 776-1915

Haines Engineering Services, Inc.

311 STERBA PRESCOTT, AZ 86305

CHECKED BY

NOTE: FUSES NOT LISTED ABOVE MUST BE APPROVED BY DESIGNER/ENGINEER

 $\langle B \rangle$ 3-#4/0 THWN CU., 1-#4 GND IN 2" CONDUIT.