
# Moject Description Caphic Standards

Embry-Riddle Aeronautical University intends to renovate the restrooms in existing building 53. All existing fixtures will be removed. The restroom will be renovated to comply with ADA, adding new ADA compliant stalls including an ambulatory accessible toilet stall in each restroom. The men's and women's restrooms will be reversed having the men's restroom on the West side (plan) and the Women's restroom on the East side (plan) to maximize the number of toilet fixtures being provided. A new ceiling and lighting will be added as well as a new water heater. A new heater/swamp cooler and ductwork will be provided for the Restrooms. There will be no work to the other half of the

# State / Vicinity Map

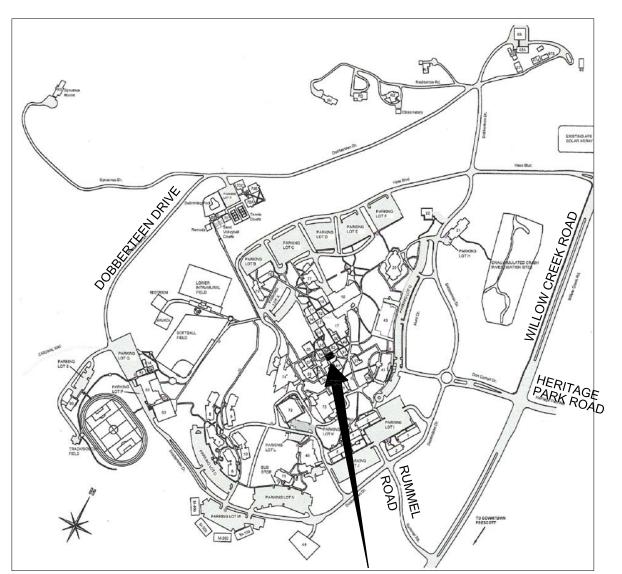

**PROJECT** 



DETAIL DESIGNATOR

**BUILDING SECTION** 

REVISION DESIGNATOR

TYPICALLY INDICATES

TYPICALLY INDICATES

**EXISTING DOOR & FRAME** 


**EXISTING DOOR & FRAME TO** 

DESIGNATOR

BE REMOVED

TO REMAIN

NORTH ARROW INDICATOR

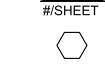

DESCRIPTIVE NOTE DESIGNATOR

**ELEVATION DESIGNATOR** 



ROOM NUMBER / FINISH DESIGNATOR



DOOR TYPE DESIGNATOR

WINDOW TYPE DESIGNATOR

GRID LINE DESIGNATOR

TYPICALLY INDICATES PROPOSED DOOR & FRAME - REFER TO DOOR SCHEDULE

# EVERY-RIDDLE

# RESTROOM REMODEL BUILDING 53

# Roject Information Seet Index

**OWNER:** 

Embry-Riddle Aeronautical University PH: 928-777-6600 3700 Willow Creek Road Prescott, AZ 86301

FAX: 928-777-3950 **CONTACT: Carl Beumer** beumerc@erau.edu

PH: 928-443-5812

FAX: 928-443-5815

waka@cableone.net

**CONTACT: Alan Kenson** 

PREPARED BY:

**CONTRACTOR:** 

W. Alan Kenson & Associates. P.C. P.O. Box 11593 Prescott, AZ 86304

TO BE DETERMINED

**SCOPE OF WORK: Restroom Renovation** 3700 Willow Creek Road (Building 53) Prescott, AZ 86301 (APN: 106-03-004) **PROJECT ADDRESS:** 

**ZONE:** BG - PAD

**OCCUPANCY**:

B (Educational Facility for students above the 12th grade), Non-Separated

CONSTRUCTION TYPE: V-B Non Sprinklered

**ACTUAL AREA** 

**BUILDING 53:** 1,644 SQUARE FEET **RENOVATION AREA: 822 SQUARE FEET** 

**ARCHITECTURAL** 

**CS** Cover Sheet

**A0.0** Construction Access Plan

A1.0 Demolition plan, Reference plan,

Dimension plan and Door Schedule A2.0 Demolition & Proposed Reflected Ceiling

plans and Ceiling Framing Plan A3.0 Interior & Exterior Elevations, and

**Toilet Accessory Schedule** A4.0 Building Sections and Materials & Finish

**A5.0** Specifications

**MECHANICAL** 

M1.0 Mechanical Floor Plan

**M2.0** Mechanical Schedules **PLUMBING** 

P1.0 Plumbing Floor Plan

P2.0 Waste & Vent Schematic, Details and Specifications

**ELECTRICAL** 


E1.0 Electrical Lighting Plan

**E2.0** Electrical Power Plan

**E3.0** Electrical One-Line Diagram

**E4.0** Electrical Specifications



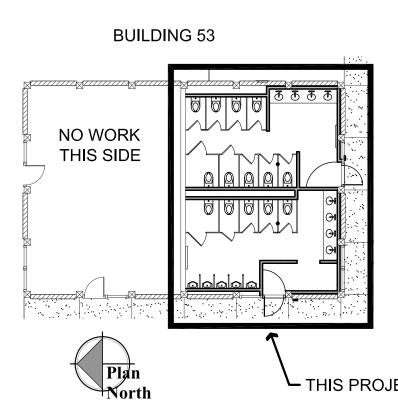

### **Architect:**

W. Alan Kenson & Associates, P.C.

P 928-443-5812 F 928-443-5815 P.O. Box 11593 Prescott, AZ 86304

email: waka@cableone.net www.kenson-associates.com

ARCHITECTURE & PLANNING



REVISIONS

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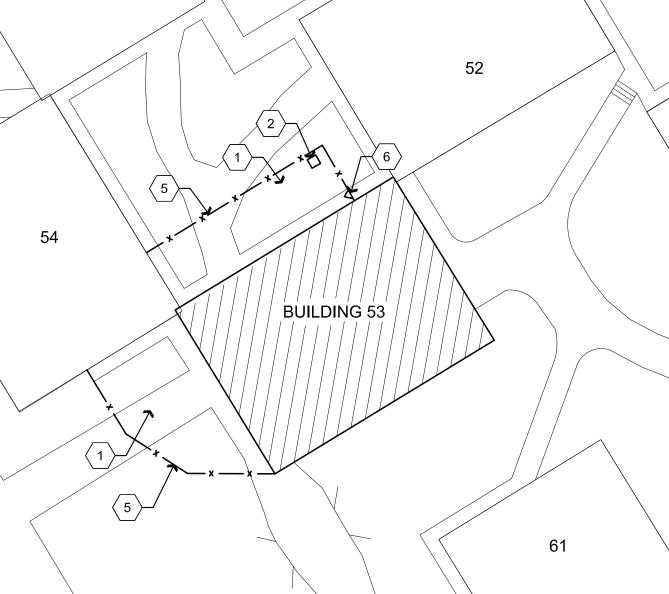
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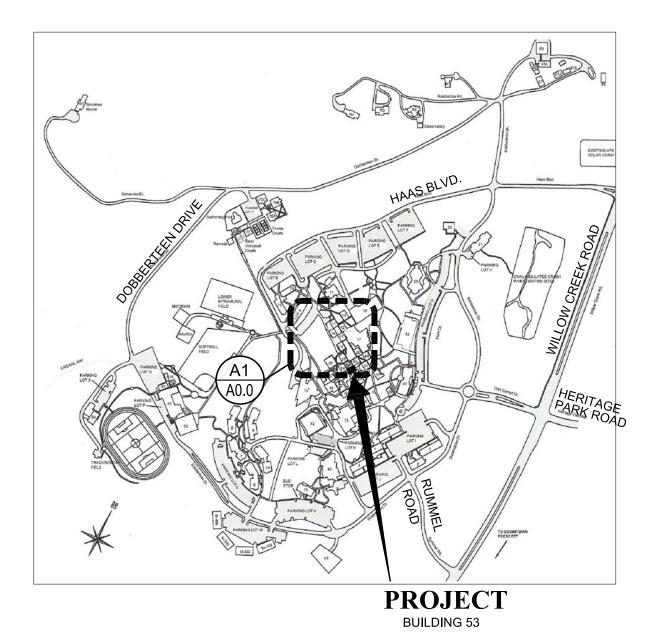
- 1. CONSTRUCTION MATERIAL STAGING AREA.
- 2. LOCATION FOR J-JON.
- 3. LOCATION OF TRASH DUMPSTER BY OWNER. 4. CONTRACTOR PARKING AREA. 6 SPACES AVAILABLE.
- CONTRACTOR TO PROVIDE SIGNAGE DESIGNATING SPACES

5. 6' TALL TEMPORARY CHAIN LINK FENCING BY CONTRACTOR.
6. TEMPORARY ±4' WIDE, HINGED, SWINGING GATE WITH LOCK MECHANISM.










B Vicinity Map




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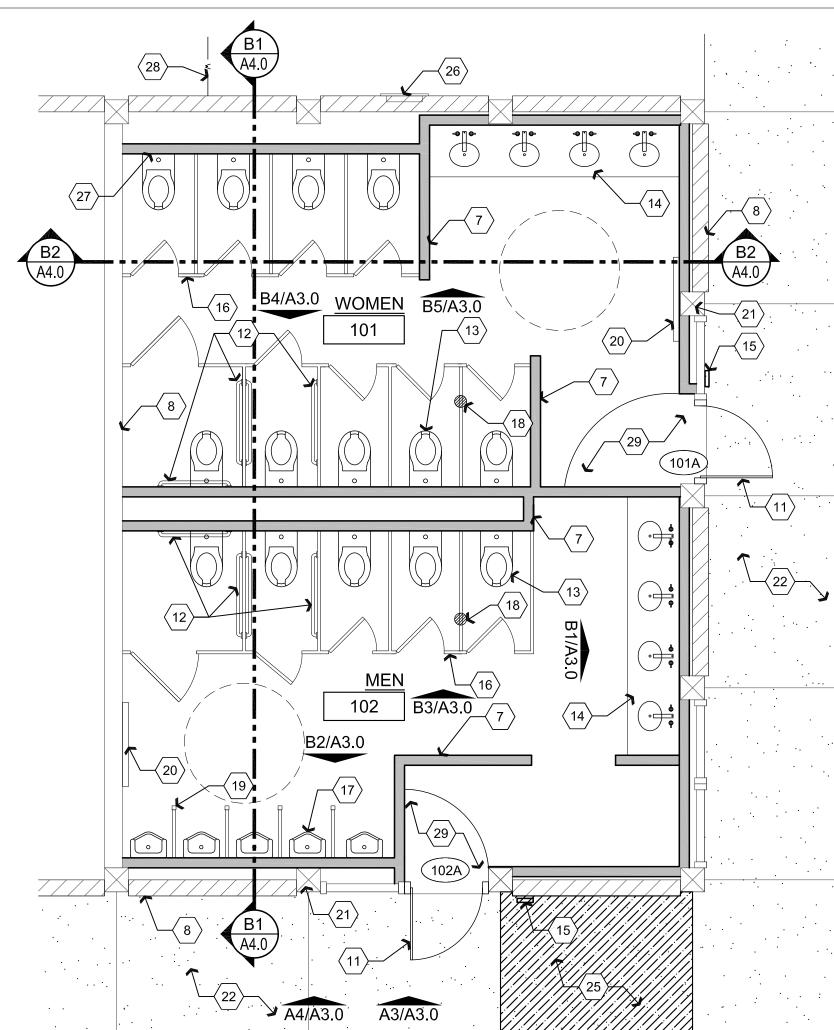



<u>llardwar</u>	e Schedul	<u>e</u>		
Heading # HW-01				
1 SGL	Door 101A	Exterior from Women's 101	LHR	90 Deg
1 SGL	Door 102A	Exterior from Men's 102	LHR	90 Deg
Single Opening	3-0 x 7-0 x 1-3/4 H	HMD x HMF		
Each Door to Receiv	/e:			
3 EA.	Hinge	FBB168 4-1/2 x 4-1/2 NRP	652	Stanley
1 EA.	Classroom D.B.	83T 7S STK	626	Best
1 EA.	Core	By Owner	626	Best
1 EA.	Closer	4040XP S Cush	689	LCN
1 EA.	Push Plate	8200 4" x 16"	630	Ives
1 EA.	Pull Plate	8302G - 8" 4" x 16"	630	Ives
1 EA.	Kick Plate	8400 10" x 34"	630	Ives
1 EA.	Weather-strip	303AS 36" x 84"	Alum	Pemko
1 EA.	Door Sweep	315CN - 36"	Alum	Pemko
1 EA.	Threshold	171A – 36" MS/ES	Alum	Pemko


Door	Schedule							
NO.	ROOM NAME	SIZE	TYPE	DOOR MATERIAL	DOOR FINISH	FRAME MATERIAL	FRAME FINISH	HARDWARE TYPE
101A	WOMEN	3'-0"x6'-8"	А	НМ	PAINT	НМ	PAINT	01
102A	MEN	3'-0"x6'-8"	А	НМ	PAINT	НМ	PAINT	01
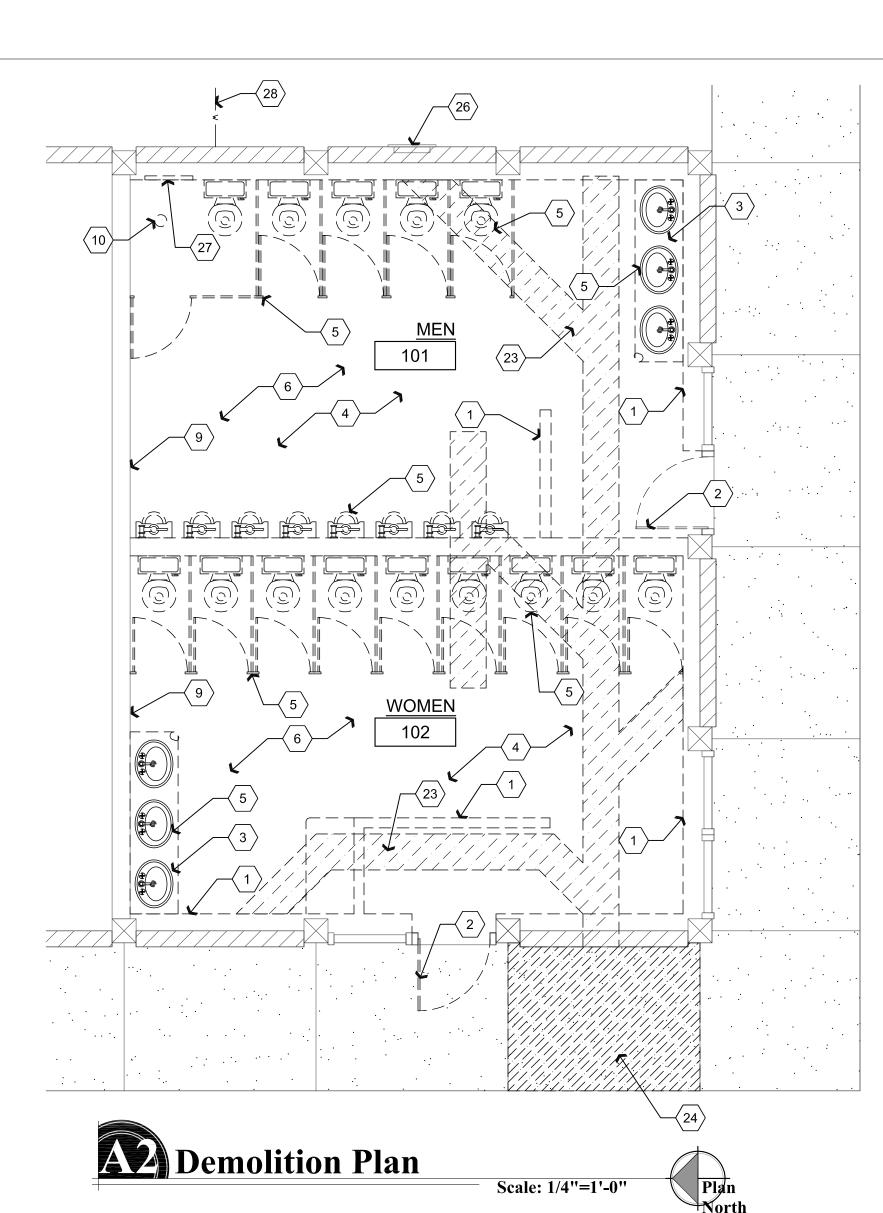
#### NOTES:

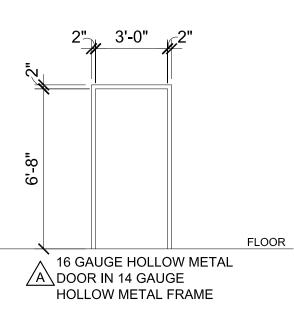- 1. ALL EXIT DOORS & HARDWARE SHALL COMPLY WITH THE 2012 I.B.C.
- 2. DOOR THRESHOLDS SHALL HAVE A MAX HEIGHT OF 1/2" FOR H.C. ACCESSIBILITY. THRESHOLD SHALL HAVE A
- MAXIMUM RISE OF 1/4" AND 1/2" RISE WHEN BEVELED WITH MAXIMUM 1:2 SLOPE.
- ALL GLAZING IN DOORS SHALL BE SAFETY GLAZING.
- 4. ALL INTERIOR DOORS SHALL BE OPERABLE FOR EMERGENCY EXITING PURPOSES WITHOUT THE USE OF A KEY, SPECIAL KNOWLEDGE NOR EFFORT.
- 5. ALL GLAZING WITHIN 24" OF OPENINGS SHALL BE SAFETY GLASS.
- 6. IF A DOOR HAS A CLOSER, THEN THE SWEEP PERIOD OF THE CLOSER SHALL BE ADJUSTED SO THAT FROM AN OPEN POSITION OF 70 DEGREES, THE DOOR WILL TAKE AT LEAST 3 SECONDS TO MOVE TO A POINT 3" FROM THE LATCH, MEASURED TO THE LEADING EDGE OF THE DOOR.
- 7. DOOR HANDLES, PULLS, LATCHES, LOCKS, AND OTHER OPERATING DEVICES ON ACCESSIBLE DOORS SHALL HAVE A SHAPE THAT IS EASY TO GRASP WITH ONE HAND AND DOES NOT REQUIRE TIGHT GRASPING, TIGHT PINCHING, OR TWISTING OF THE WRIST TO OPERATE. HARDWARE REQUIRED FOR DOOR PASSAGE SHALL BE MOUNTED NO HIGHER THAN 48" ABOVE FINISH FLOOR.
- 8. DOOR OPENING FORCE SHALL BE: 5lbf MAX INTERIOR HINGED, SLIDING OR FOLDING DOORS; FIRE DOORS SHALL HAVE THE MINIMUM OPENING FORCE ALLOWABLE BY THE APPROPRIATE ADMINISTRATIVE AUTHORITY.




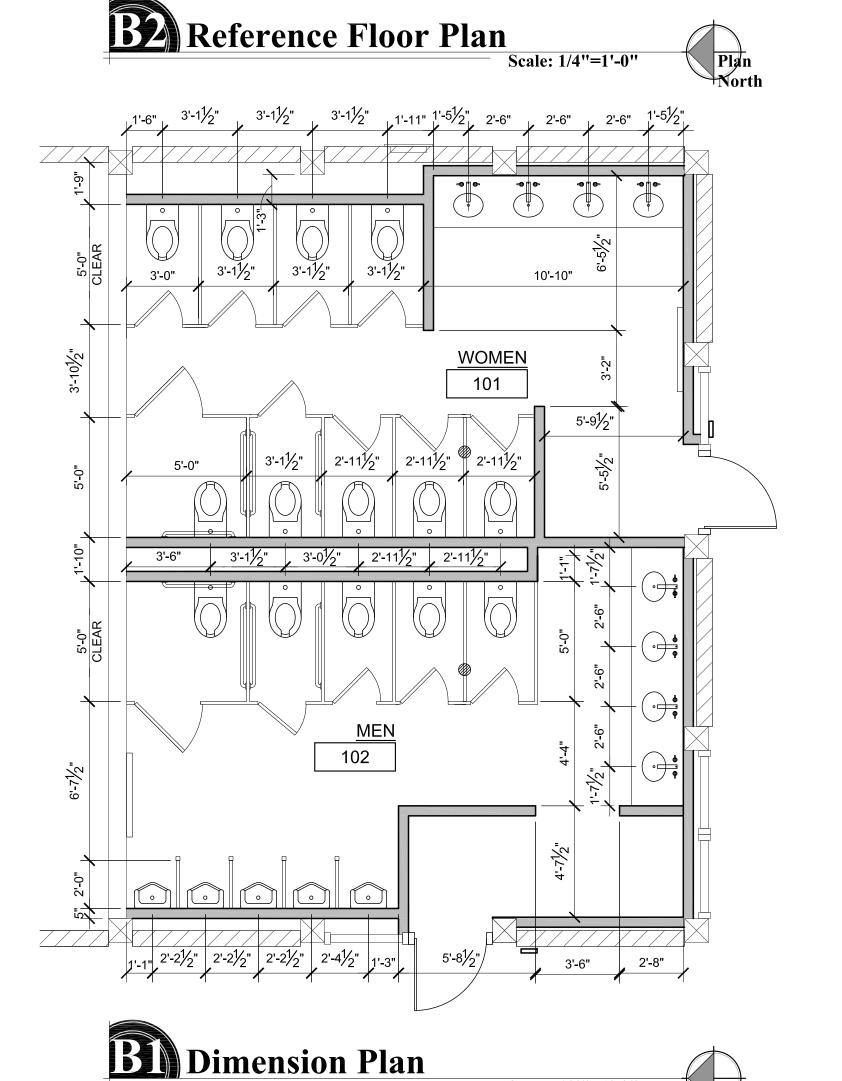


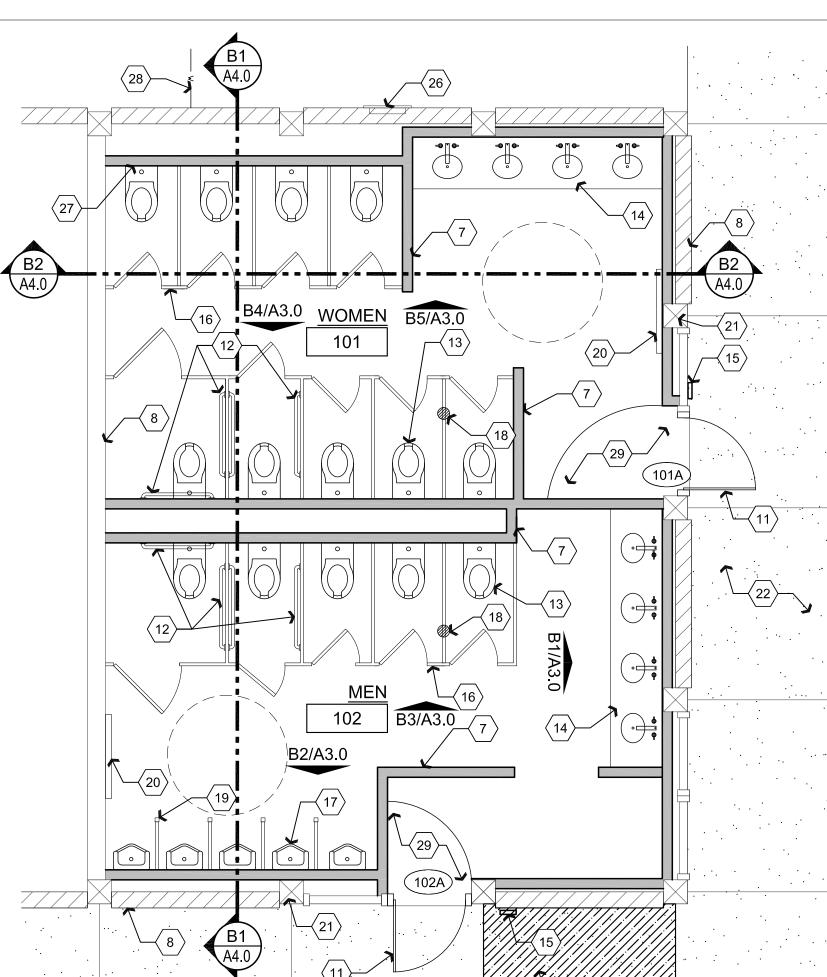



- TYPICALLY INDICATES EXISTING WALL TO BE REMOVED.
- 2. TYPICALLY INDICATES EXISTING DOOR TO BE REMOVED
- REMOVE WATER HEATER BELOW.
- 4. REMOVE FLOORING IN THIS AREA 5. TYPICALLY INDICATES PLUMBING FIXTURES, TOILET PARTITIONS,
- ACCESSORIES, ETC. TO BE REMOVED. REFER TO PLUMBING PLANS. REMOVE ENTIRE CEILING THIS AREA, INCLUDING ALL MECHANICAL AND ELECTRICAL. EXISTING TONGUE AND GROOVE SHEATHING & GLULAM
- 7. TYPICALLY INDICATES PROPOSED STEEL STUD PARTITION WALL. REFER TO WALL TYPES LEGEND.
- 8. TYPICALLY INDICATES EXISTING WALL TO REMAIN. PROVIDE NEW GPDW, TEXTURE AND PAINT.
- 9. REMOVE GPDW THIS SIDE OF WALL ONLY.
- 10. REMOVE FLOOR DRAIN. 11. INSTALL NEW DOOR AND HOLLOW METAL FRAME, REFER TO DOOR
- SCHEDULE, TYPICAL. 12. PROVIDE 1-1/2" DIAMETER GRAB BARS PER A.D.A. REQUIREMENTS, 42" LONG
- AT SIDE OF WATER CLOSET / 36" LONG AT REAR OF WATER CLOSET PROVIDE SOLID BLOCKING. IN AMBULATORY STALL, PROVIDE 42" GRAB BARS EACH SIDE.
- 13. PROVIDE WALL HUNG WATER CLOSET, REFER TO PLUMBING DRAWINGS. 14. PROVIDE SELF-RIMMING LAVATORY IN SOLID SURFACE COUNTER TOP.
- REFER TO PLUMBING DRAWINGS. 15. PROVIDE ACCESSIBILITY SIGNAGE MOUNTED PER A.D.A. REQUIREMENTS.
- 16. PROVIDE HEAD RAIL-BRACED METAL TOILET PARTITION.
- 17. PROVIDE WALL HUNG URINAL, REFER TO PLUMBING PLANS.
- 18. FLOOR DRAIN. REFER TO PLUMBING PLANS.
- 19. PROVIDE 2"X2" FLOOR TO CEILING URINAL SCREEN POST. 20. PROVIDE ADA COMPLIANT BABY CHANGING TABLE, INSTALL PER
- MANUFACTURER INSTRUCTIONS, PROVIDE SOLID BLOCKING
- 21. EXISTING 12x12 WOOD COLUMN. 22. EXISTING CONCRETE SIDEWALK.
- 23. SAWCUT AND REMOVE CONCRETE FLOOR TO ACCOMMODATE PLUMBING
- WASTE LINE. REFER TO PLUMBING PLANS. 24. SAWCUT AND REMOVE CONCRETE SIDEWALK TO ACCOMMODATE PLUMBING
- SIDEWALK. PROVIDE 8" TURNDOWN 26. EXISTING ELECTRIC PANEL TO REMAIN. REFER TO ELECTRICAL PLANS. 27. PLUMBING SHUT OFF VALVES. REFER TO PLUMBING PLANS. PROVIDE NEW
- ACCESS PANEL AS REQUIRED.
- 28. EXISTING BELOW GRADE WATER LINE. REFER TO PLUMBING PLANS. 29. WALK-OFF MAT. PROVIDED BY OWNER, INSTALLED BY CONTRACTOR

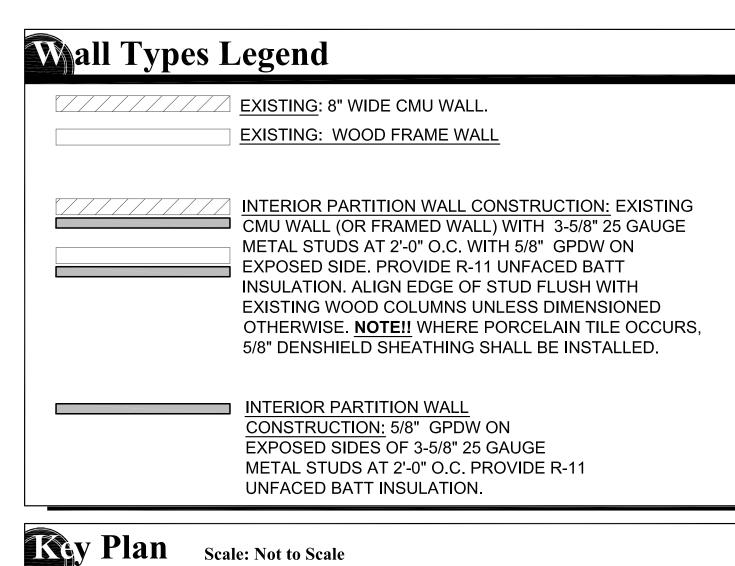

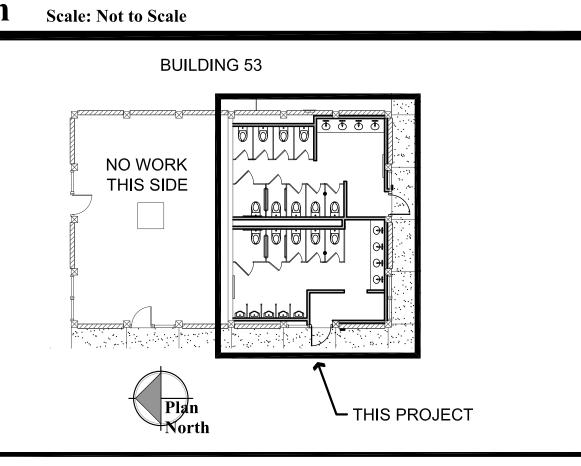

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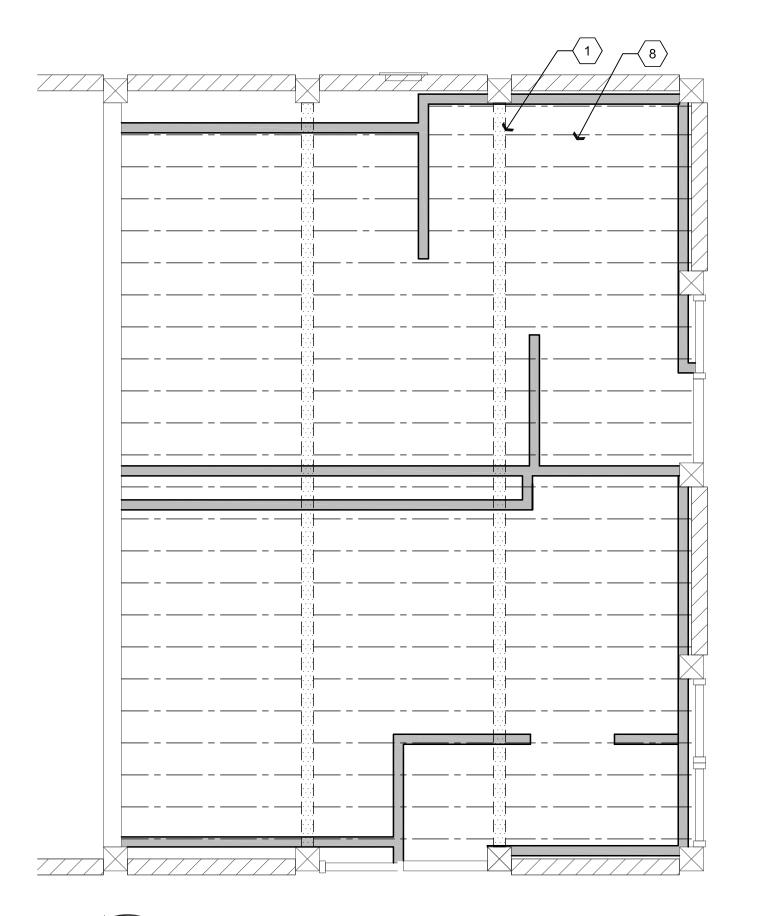
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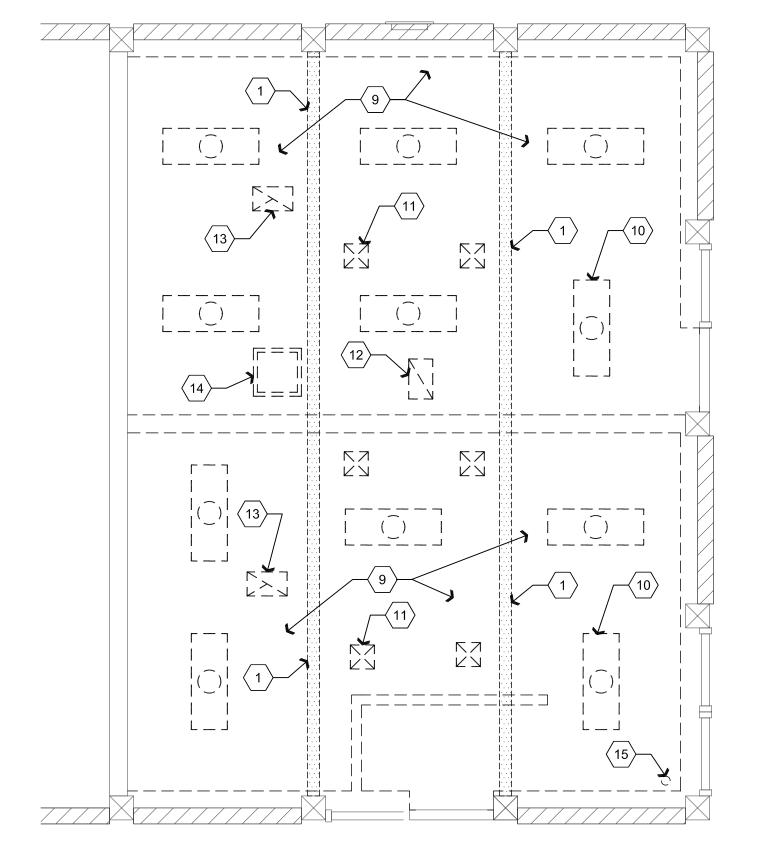
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Discriptive Keynotes (

EXISTING GLULAM BEAMS @ 8'-0" A.F.F. TO REMAIN. 2. LIGHT FIXTURE(S) SHOWN FOR QUANTITY AND LOCATION ONLY. REFER TO ELECTRICAL PLANS.

3. PROVIDE 5/8" GPDW CEILING.

4. HVAC SUPPLY DIFFUSER, REFER TO MECHANICAL PLANS, TYPICAL.

5. NOT USED.

6. HVAC EXHAUST FAN, REFER TO MECHANICAL PLANS,

7. NOT USED. 8. 2x4 FRAMING @ 16" O.C.

9. REMOVE ENTIRE GPDW CEILING.

10. REMOVE LIGHT FIXTURE AND ASSOCIATED WIRING, TYPICAL

11. REMOVE HVAC SUPPLY DIFFUSER AND ASSOCIATED DUCTWORK, TYPICAL

12. REMOVE HVAC RETURN AND ASSOCIATED DUCTWORK,

13. REMOVE EXHAUST FAN AND ASSOCIATED DUCTWORK,

TYPICAL. 14. REMOVE ATTIC SCUTTLE.

15. REMOVE OCCUPANCY SENSOR.

16. INSTALL ROOF CURB AT NEW MECHANICAL UNIT. REFER TO MECHANICAL PLANS. REPAIR ROOF AS REQUIRED.

17. EXISTING HVAC UNIT TO REMAIN

18. INSTALL NEW EXHAUST FAN AND ROOF CURB. REFER TO MECHANICAL PLANS. REPAIR ROOF AS REQUIRED.

Ceiling Framing Plan
Scale: 1/4"=1'-0"

ALL ROOF PENETRATIONS WILL BE MADE BY A CERTIFIED TREMCO ROOF INSTALLER. NO OTHER CONTRACTOR OR

ROOFING SYSTEM IS ACCEPTABLE. PROVIDE TREMCO APPROVED ROOF JACK TO ROOFING CONTRACTOR FOR

CONTACT TREMCO ROOFING REPRESENTATIVE:

EMAIL: WALT.HITCHCOCK@ME.COM

INSTALLATION.


WALT HITCHCOCK CELL: 480-694-3433








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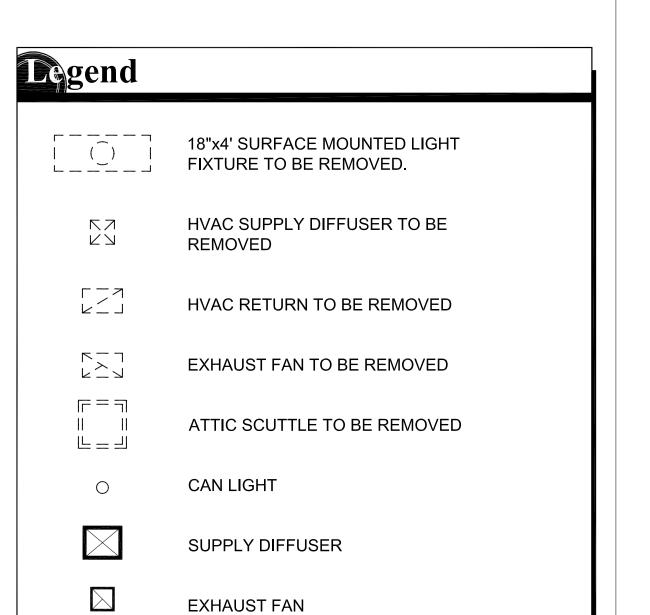


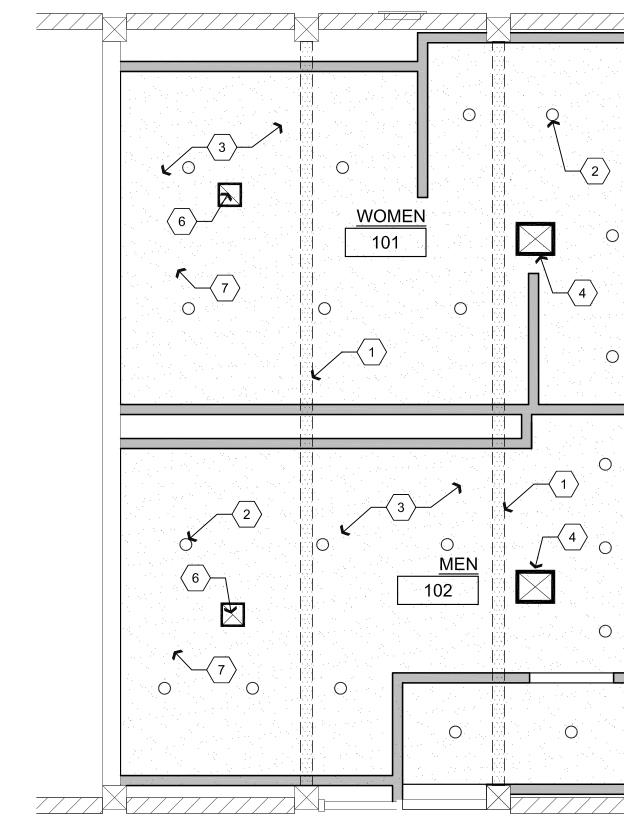


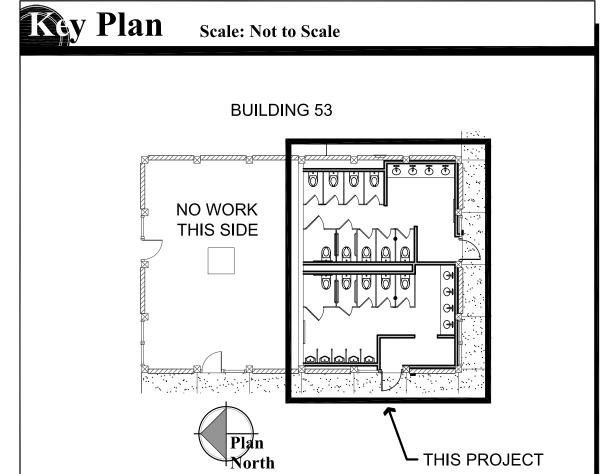







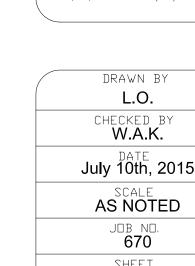

EMBRY-RIDDLE AERONAUTICAL UNIVERSI BUILDING 53 RESTROOMS RENOVATIONS Prescott, AZ DEMOLITION & PROPOSED REFLECTED PLAN AND CEILING FRAMING PLAN DRAWING:

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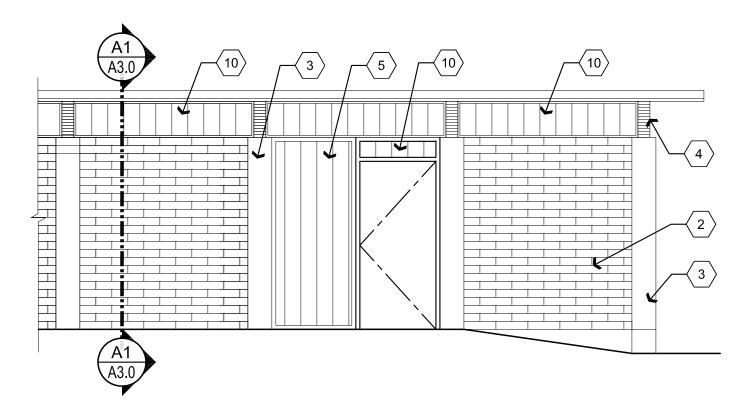
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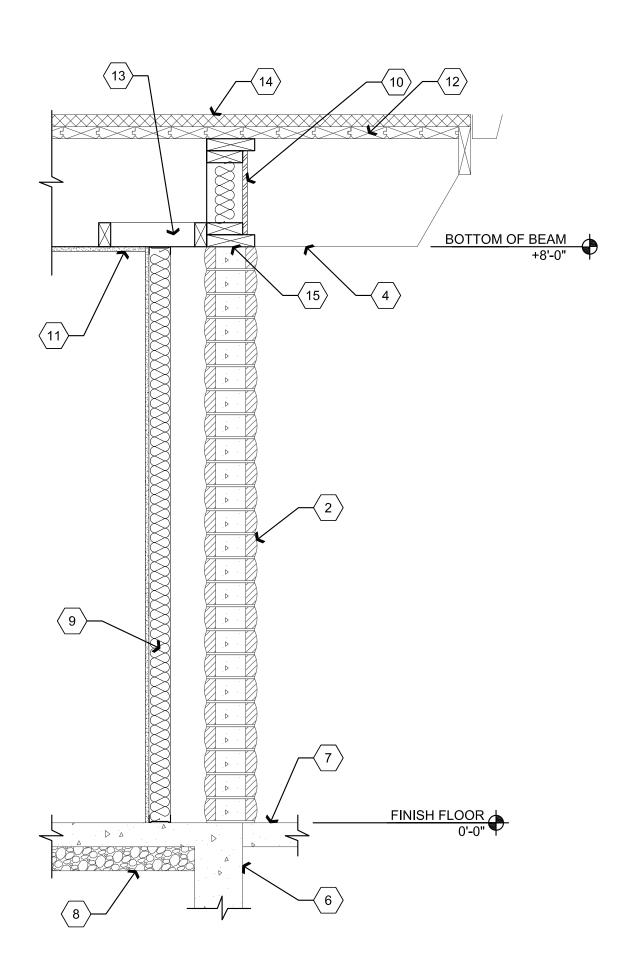
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July 10th, 2015


# Existing Partial West Elevation Scale: 1/4"=1'-0"




# **Proposed Partial West Elevation**






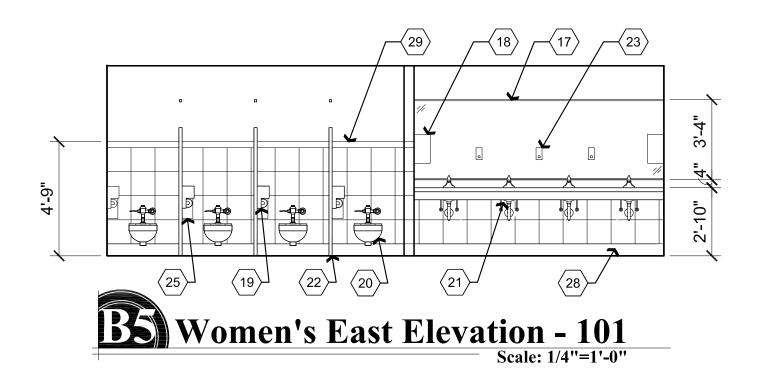


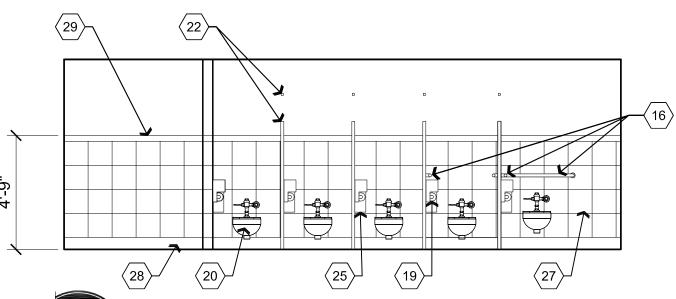


**B** Women's West Elevation - 101

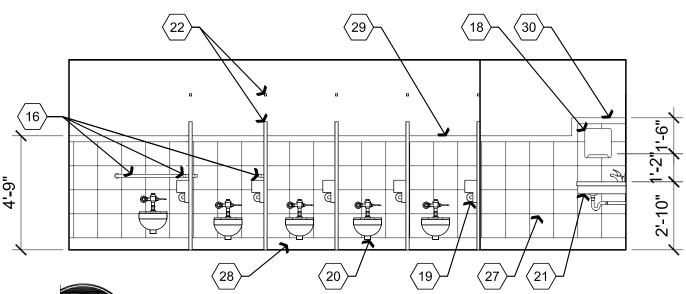

Men's East Elevation - 102
Scale: 1/4"=1'-0"

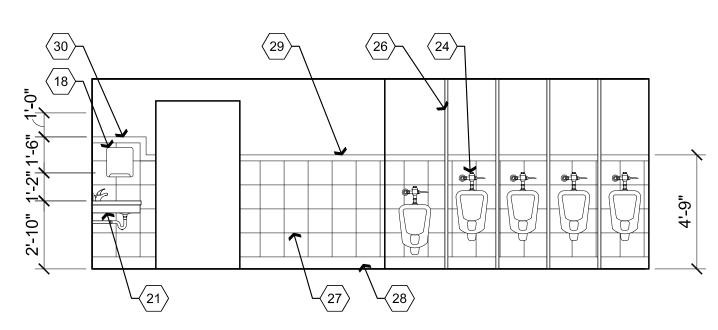

**B2** Men's West Elevation - 102
Scale: 1/4"=1'-0"

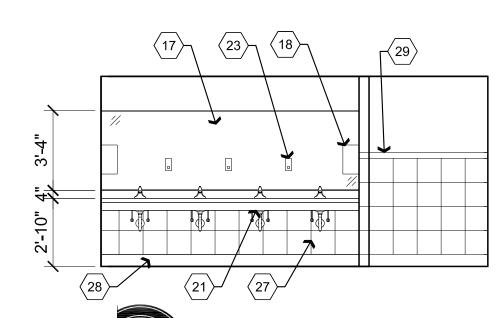

**B** Men's South Elevation - 102
Scale: 1/4"=1'-0"

Discriptive Keynotes (

REMOVE EXISTING ALUMINUM FRAME CLERESTORY WINDOWS, TYPICAL.

2. EXISTING 8"X4"X16" SLUMP BLOCK INFILL WALL.

3. EXISTING 12"X12" STRUCTURAL WOOD COLUMN.

4. EXISTING 6"X18" GLU-LAM BEAMS.

5. EXISTING WOOD FRAMED INFILL WALL, WITH T-111 SIDING.

6. EXISTING FOUNDATION.

7. EXISTING EXTERIOR CONCRETE SLAB.

8. EXISTING COMPACTED ABC.

STEEL STUD WALL, REFER TO WALL TYPES PLAN.

10. INFILL OPENING WITH 2X8 WOOD STUD OUTER FRAME, AND 2X6 INNER FRAME WITH STUDS @ 16" O.C., PROVIDE 5/8" T-111 INSET SHEATHING TO MATCH EXISTING, PROVIDE SEALANT AT ALL EDGES WHERE SHEATHING MEETS OUTER FRAME, PAINT SHEATHING TO MATCH EXISTING AT EXTERIOR. PROVIDE R-19 FRICTION FIT BATT INSULATION AT EACH STUD CAVITY. ON INTERIOR SIDE, PROVIDE 5/8" GPDW, UP TO T&G WOOD ROOF DECK. SECURE WOOD INFILL FRAME WITH SHOT PIN

ANCHORS TO MASONRY, AND NAILS TO WOOD MEMBERS 11. PROVIDE 5/8" GPDW CEILING, REFER TO REFLECTED CEILING

12. EXISTING 2x6 TONGUE AND GROOVE WOOD DECK.

13. PROVIDE 2x4 WOODEN BLOCKING @ 4'-0" O.C. 14. EXISTING ROOFING.

15. CUT NAIL / EXPANSION BOLT TO CMU. 16. PROVIDE 1-1/2" DIAMETER GRAB BARS PER A.D.A.

REQUIREMENTS, 42" LONG AT SIDE OF WATER CLOSET / 36" LONG AT REAR OF WATER CLOSET. PROVIDE SOLID BLOCKING IN AMBULATORY STALL PROVIDE 42" GRAB BARS EACH SIDE

17. PROVIDE 1/4" PLATE MIRROR FULL LENGTH OF WALL ABOVE VANITY TOP.

18. PAPER TOWEL DISPENSER PROVIDED BY OWNER, INSTALLED BY CONTRACTOR.

19. TOILET PAPER HOLDER PROVIDED BY OWNER, INSTALLED BY CONTRACTOR.

20. PROVIDE WALL HUNG WATER CLOSET, REFER TO PLUMBING

21. PROVIDE SELF-RIMMING LAVATORY IN SOLID SURFACE COUNTER TOP, WITH 4" BACK SPLASH. INSULATE PIPES, REFER TO PLUMBING DRAWINGS. SS-1

22. PROVIDE HEAD RAIL-BRACED TOILET PARTITION. TC-1 23. SOAP DISPENSER PROVIDED BY OWNER, INSTALLED BY

CONTRACTOR. 24. PROVIDE WALL HUNG URINAL, REFER TO PLUMBING PLANS.

25. SANITARY NAPKIN DISPOSAL PROVIDED BY OWNER, INSTALLED BY CONTRACTOR.


26. PROVIDE 2"X2" FLOOR TO CEILING URINAL SCREEN POST.

27. PROVIDE 12" X 12" THINSET WALL TILE. CT-4

28. PROVIDE 6" X 12" THINSET COVE BASE TILE. CT-2 CT-5

29. PROVIDE 3" THINSET BULLNOSE TILE. CT-3 30. MODIFY TILE AT PAPER TOWEL DISPENSER LOCATION, SO THE ENTIRE PAPER TOWEL DISPENSER IS FLUSH WITH THE TILE. HEIGHT OF TILE FROM THE FLOOR AND DISTANCE OF SURROUNDING TILE TO BE CONSISTENT WITH ALL 4 PAPER

Toilet Accessory Schedule CONTACT KB108-12 WWW.KOALABEAR.COM **BABY CHANGING STATION** KOALA KARE **GREY GRANITE** HAND SOAP DISPENSER PROVIDED BY OWNER PAPER TOWEL DISPENSER PROVIDED BY OWNER **TOILET PAPER DISPENSER** PROVIDED BY OWNER TOILET SEAT COVER DISPENSER PROVIDED BY OWNER SANITARY NAPKIN RECEPTACLE PROVIDED BY OWNER GRAB BARS 36" & 42" 150Sx36, 150Sx42 WWW.GAMCOUSA.COM GAMCO

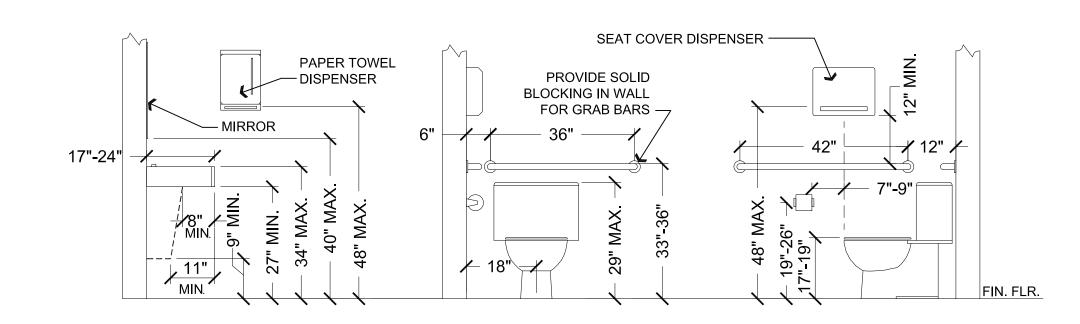



Scale: 1/2"=1'-0"

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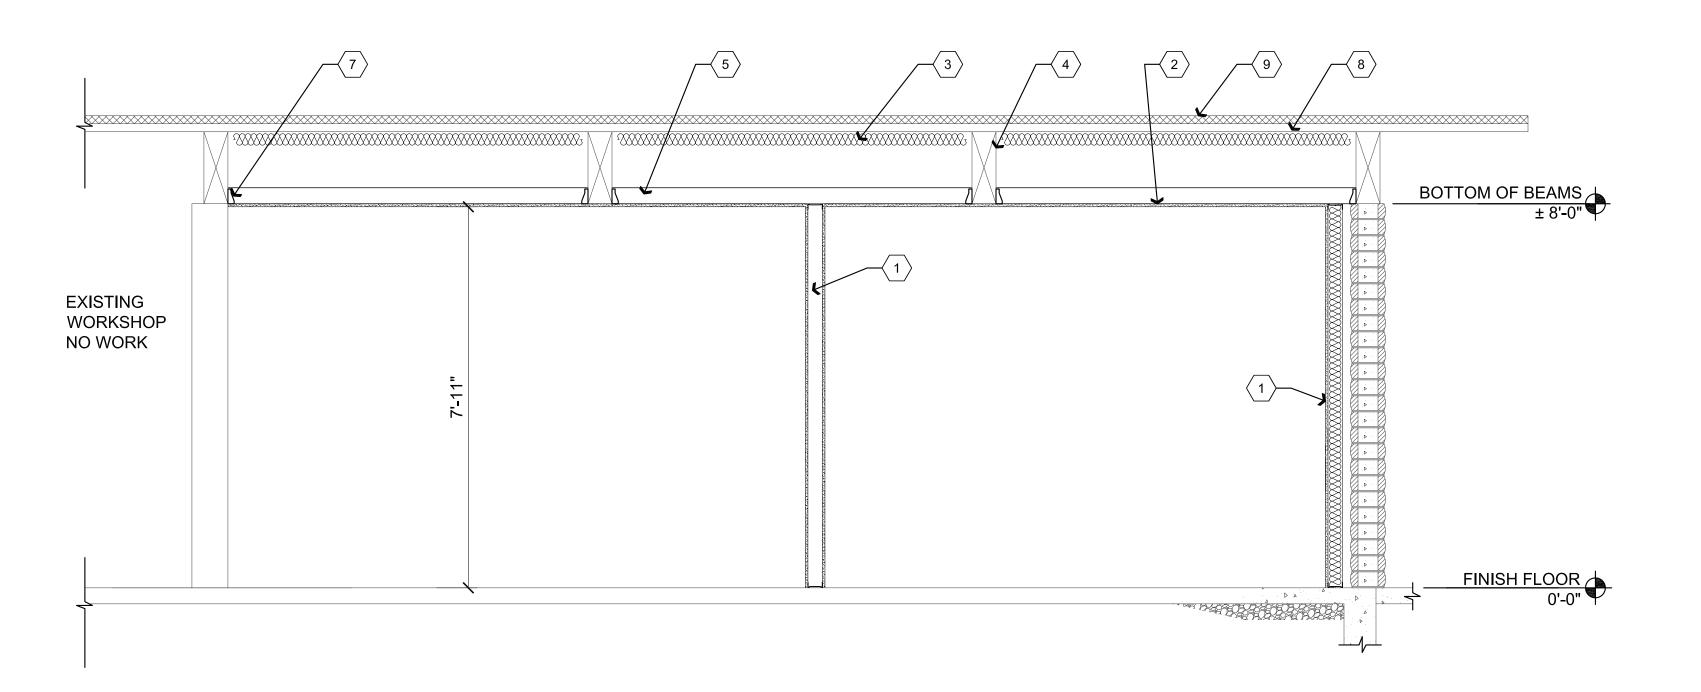
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INTERIOR AND EXTERIOR ELEVATIONS, DOOR SCHEDULE AND TOILET ACCESSORY SCHEDUI EMBRY-RIDDLE AERONAUTICAL UNIVERSI BUILDING 53 RESTROOMS RENOVATIONS Prescott, AZ

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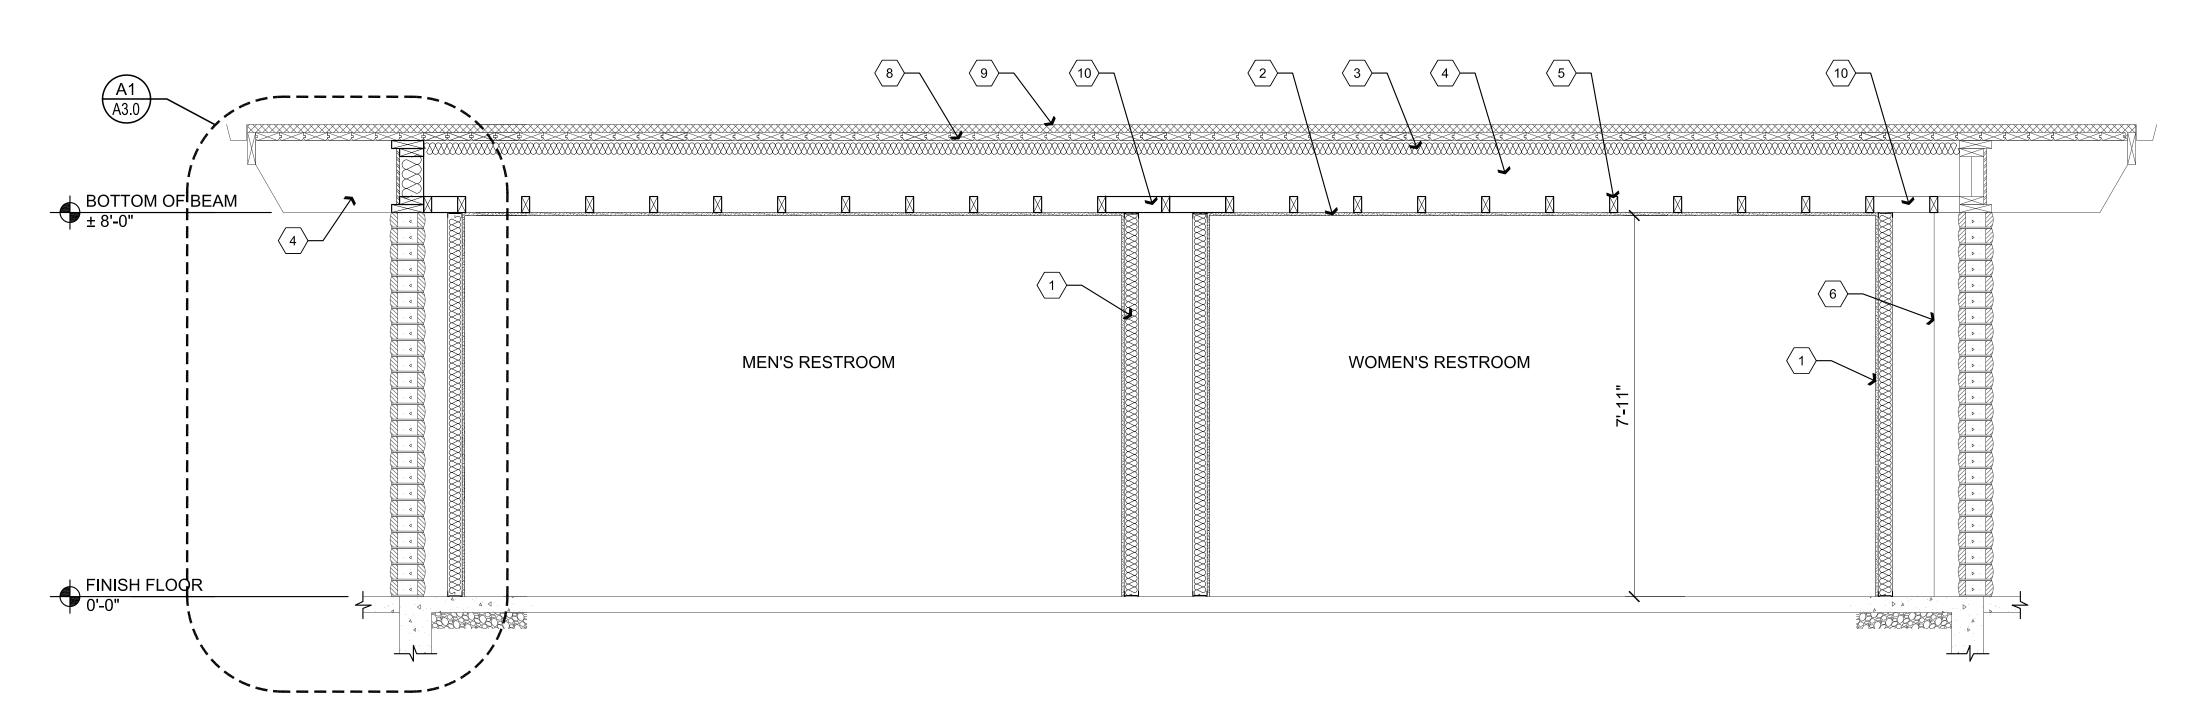
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To to	rials and Finish Sahas	lule (interior and exterio	. 20)	
Wete.	nais and rinish Sched	iule (interior and exterio	)1 )	
CODE	MATERIAL	LOCATION	MANUFACTURER	SPECIFICATION
CT-1	CERAMIC TILE	RESTROOM FLOORS	DALTILE	12x12, CITY VIEW, URBAN EVENING CY08(2)
CT-2	CERAMIC TILE COVE BASE	RESTROOM WALLS	DALTILE	6x12 COVE BASE, CITY VIEW, SEASIDE BOARDWALK CY06 (1)
CT-3	CERAMIC TILE BULLNOSE	RESTROOM WALLS	DALTILE	3x12, BULLNOSE, CITY VIEW, SEASIDE BOARDWALK CY06 (1)
CT-4	CERAMIC WALL TILE	RESTROOM WALLS	DALTILE	12x12, CITY VIEW, SEASIDE BOARDWALK CY06 (1)
CT-5	CERAMIC WALL TILE	RESTROOM WALLS	DALTILE	1x6, COVE BASE OUTCORNER, CITY VIEW, SEASIDE BOARDWALK CY06 (1)
GR-1	GROUT	WALLS AND FLOORS	CUSTOM	PEWTER #19
PT-1	PAINT	INTERIOR CEILINGS & WALLS ABOVE TILE	SHERWIN WILLIAMS	PACER WHITE SW6098
PT-2	PAINT	EXTERIOR NEW SIDING	SHERWIN WILLIAMS	SANDS OF TIME SW 6101 (MATCH EXISTING)
PT-3	PAINT	EXTERIOR TRIM	SHERWIN WILLIAMS	PORTABELLO SW6102 (MATCH EXISTING)
PT-4	PAINT	EXTERIOR OF EXTERIOR DOOR & FRAME	SHERWIN WILLIAMS	RAINSTORM SW6230
PT-5	PAINT	INTERIOR OF EXTERIOR DOOR & FRAME	SHERWIN WILLIAMS	PV 6153, ALL SURFACE WATER BASE ENAMEL, LOW SHEEN
SS-1	SOLID SURFACE	RESTROOM COUNTERTOPS	LG SURFACES	HI-MACS SEA OAT QUARTZ 638
TC-1	POWDER COATED METAL TOILET PARTITIONS	RESTROOMS	HADRIAN	504 LINEN, HEADRAIL BRACED
WM-1	WALK-OFF MAT	RESTROOM ENTRY	TANDUS	BIRCH BARK NRG714 - PROVIDED BY OWNER





SCALE: 1/2" = 1'-0"



**B** Building Section

Descriptive Keynotes

1. TYPICALLY INDICATES INTERIOR PARTITION WALL, REFER TO WALL TYPES LEGEND AND REFERENCE FLOOR PLAN.

2. PROVIDE 5/8" GPDW CEILING.

3. PROVIDE R-19 UNFACED BATT INSULATION, WIRED IN PLACE.

4. EXISTING ROOF BEAM.

5. 2x4 FRAMING AT 16" O.C.

6. EXISTING WOOD COLUMN BEYOND.
7. SIMPSON U24 JOIST HANGAR, TYPICAL.

8. EXISTING 2X6 TONGUE AND GROOVE WOOD DECK.
9. EXISTING ROOFING.

SCALE: 1/2" = 1'-0"

10. 2x4 BLOCKING AS REQUIRED.

W. Alan Kenson & Associates, P. P. 928-443-5812 P.O. Box 11593

REVISIONS

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SCHEDULE
EMBRY-RIDDLE AERONAUTICAL UNIVERSITY
BUILDING 53 RESTROOMS RENOVATIONS
Prescott, AZ

DRAWN BY
L.O.

CHECKED BY
W.A.K.

DATE
July 10th, 2015

SCALE
AS NOTED

JOB NO.
670

A4.0

refuse created in the scope of work.

03 - CONCRETE

- all dimensions, both horizontal and vertical

- Utility locations, buried and overhead

- existing conditions affecting this project

REVISIONS

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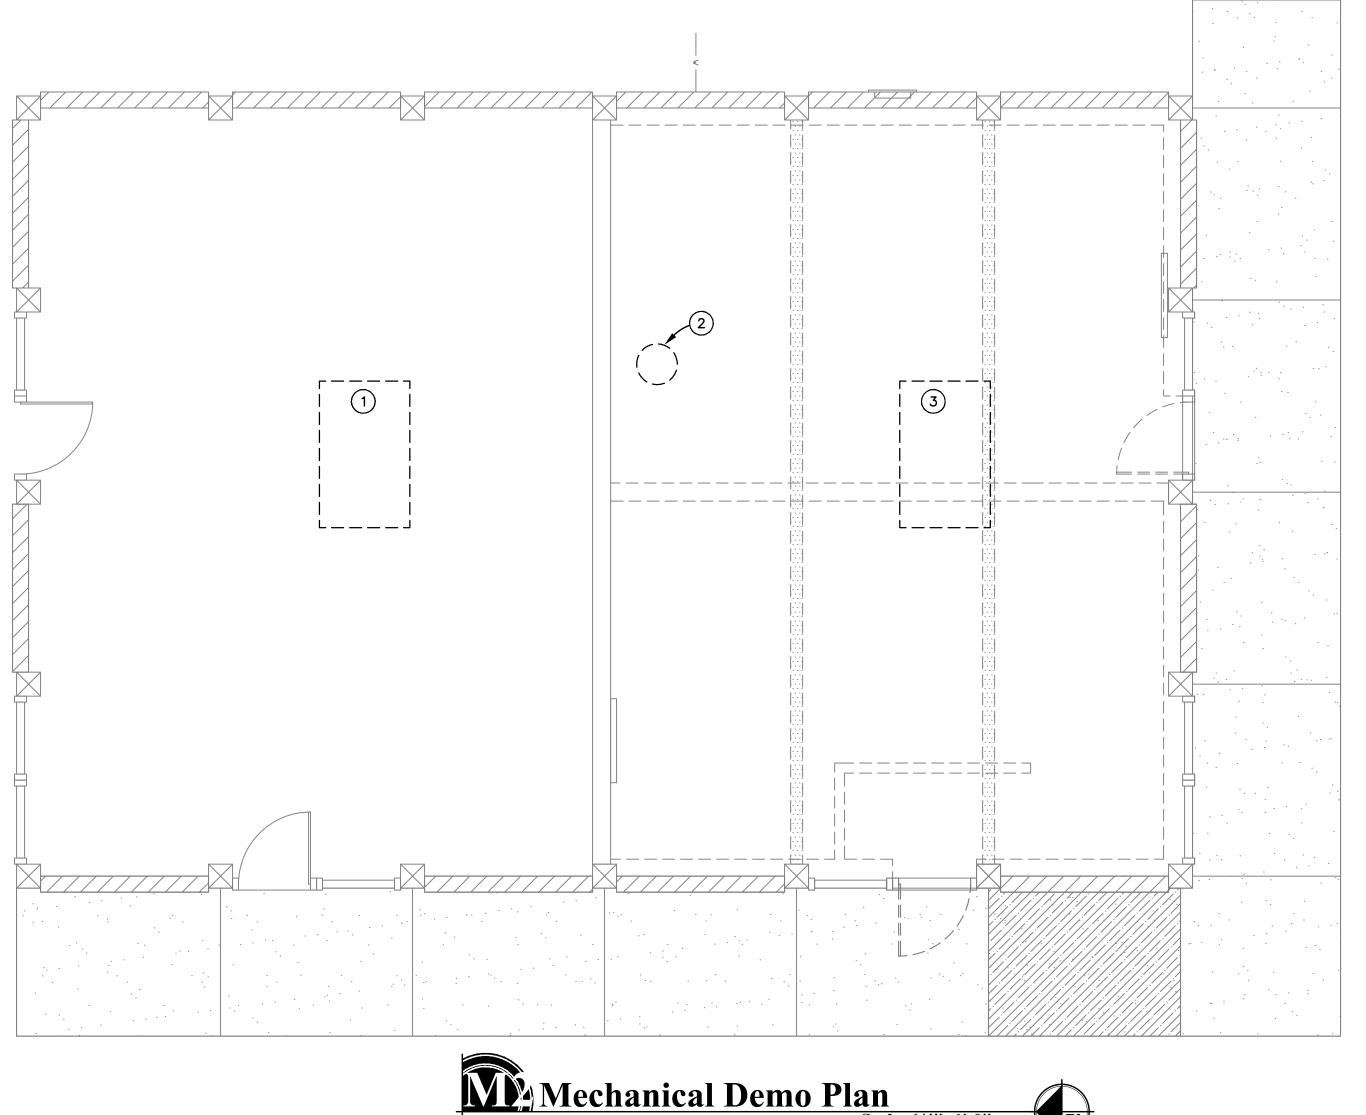
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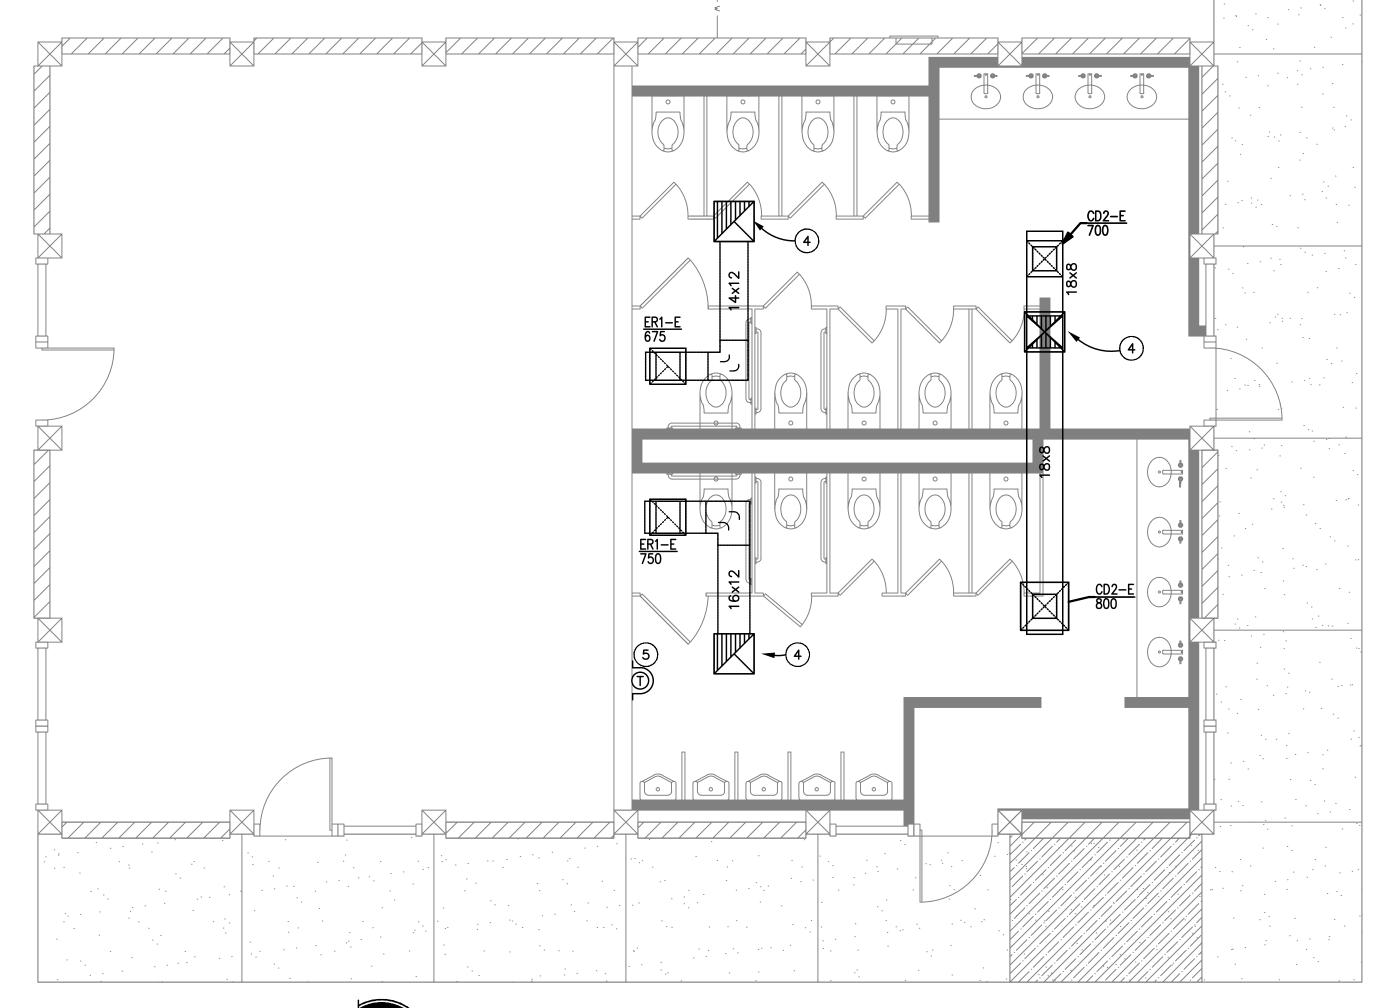
EMBRY-RIDDLE AERONAUTICAL UNIVERSI BUILDING 53 RESTROOMS RENOVATIONS Prescott, AZ AWING:

DRAWN BY L.O. CHECKED BY W.A.K. July 10th, 2015 AS NOTED

DR

color and location.















REPRESENTATIVE: WALT HITCHCOCK

CELL: 480-694-34-33 EMAIL: WALT.HITCHCOCK@ME.COM

Mechanical Roof Plan

MINIMUM 10 FT FROM OSA INTAKE

### **KEYED NOTES:**

- 1. EXISTING AC UNIT TO REMAIN.
- 2. EXISTING EXHAUST FAN AND ALL CONNECTED DUCTWORK TO BE REMOVED. EXISTING OPENING MAYBE REUSED VERIFY IN FIELD.
- 3. EXISTING AC UNIT AND ALL CONNECTED DUCTWORK TO BE REMOVED. PATCH OPENING AS REQUIRED.
- 4. DUCT UP TO EQUIPMENT ON ROOF. SEE ROOF PLAN.
- 5. T'STAT WITH LOCKABLE COVER.

#### **FIELD VERIFICATION NOTES:**

- THE HVAC CONTRACTOR SHALL VISIT THE SITE PRIOR TO BID TO FIELD VERIFY ALL EXISTING CONDITIONS WHICH MAY AFFECT HIS BID. THE FOLLOWING ITEMS SHALL BE VERIFIED.
- 2. ALL REFERENCES ON THESE DRAWINGS TO EXISTING EQUIPMENT DUCTWORK, DIFFUSERS, THERMOSTATS AND PIPING ARE FOR REFERENCE ONLY. IT IS THE RESPONSIBILITY OF THE CONTRACTOR TO VERIFY ALL THESE ITEMS PRIOR TO BID AND INCLUDE IN HIS BID ANY AND ALL AMOUNTS REQUIRED TO ACCOMMODATE EXISTING CONDITIONS.
- 3. NO ALLOWANCES WILL BE MADE AFTER THE PROJECT HAS BEEN AWARDED FOR FAILURE TO VERIFY EXISTING CONDITIONS.
- 4. ANY DISCREPANCIES WHICH MAY AFFECT THE CONTRACTORS BID SHALL BE BROUGHT TO THE ATTENTION OF THE ENGINEER AND ARCHITECT FOR DIRECTION

#### **GENERAL NOTES:**

- 1. MOUNT THERMOSTATS 48" ABOVE FINISH FLOOR TO CENTER.
- 2. DUCTWORK AND EQUIPMENT SHOWN IS DIAGRAMMATIC. COORDINATE AND ROUTE DUCTWORK TO MEET JOB REQUIREMENTS. LOCATION OF EQUIPMENT MUST BE COORDINATED WITH ALL DISCIPLINES BEFORE FINAL LOCATIONS ARE SELECTED. WEIGHTS OF EQUIPMENT MUST BE VERIFIED AND COORDINATED WITH STRUCTURAL SYSTEMS BEFORE EQUIPMENT CAN BE INSTALLED AT JOBSITE.
- 3. SPACE ALLOCATED FOR MECHANICAL AND OTHER WORK ABOVE THE SUSPENDED CEILINGS IS CRITICAL. LIGHT FIXTURES AND AIR DIFFUSERS HAVE BEEN LOCATED TO ACHIEVE A DEFINITE ARCHITECTURAL EFFECT AND MAY NOT BE CHANGED WITHOUT THE CONSENT OF THE ARCHITECT. BECOME FAMILIAR WITH THE ARCHITECTURAL, STRUCTURAL, MECHANICAL AND ELECTRICAL DRAWINGS PRIOR TO FABRICATING AND INSTALLING ANY MATERIALS. HANG DUCTWORK AS CLOSE AS POSSIBLE TO THE STRUCTURE ABOVE, UNLESS INDICATED OTHERWISE.
- 4. COORDINATE THE LOCATION OF CEILING DIFFUSERS, REGISTERS AND GRILLES WITH THE ARCHITECTURAL REFLECTED CEILING PLANS.
- 5. PASSAGES OF PIPES, CONDUITS, BUS DUCTS, CABLES, WIRES, AIRDUCTS, PNEUMATIC DUCTS, AND SIMILAR BUILDINGS SERVICE EQUIPMENT THROUGH FIRE BARRIERS SHALL BE PROTECTED AS FOLLOWS: THE SPACE BETWEEN THE PENETRATING ITEM AND FIRE BARRIER SHALL: BE FILLED WITH A MATERIAL CAPABLE OF MAINTAINING THE FIRE RESISTANCE RATING OF THE FIRE BARRIER PRODUCT. PRODUCT USED MUST MEET TEST METHODS ASTM E814 OR NFPA 251 FOR FIRE RATING.
- 6. CONTRACTOR SHALL BALANCE ALL SYSTEMS TO CFM'S SHOWN. PROVIDE 3RD PARTY INSPECTION & PROVIDE COPY OF REPORT TO THE ARCHITECT.
- 7. PLANS SHALL CONFORM TO THE 2012 IMC, 2012 IECC AND ALL CITY OF PRESCOTT ADOPTED CODES AND AMENDMENTS.
- MECHANICAL DESIGN IS INTENDED SO THAT THE MAKE-UP AIR SYSTEM WILL OPERATE CONTINUOUSLY DURING OCCUPIED HOURS TO MAINTAIN CURRENT VENTILATION REQUIREMENTS.
- 9. ALL DIFFUSERS AND GRILLES ARE LESS THAN 20LBS, CONTRACTOR SHALL POSITIVELY ATTACH TO CEILING.
- 10. VENTS SHALL BE TERMINATED A MINIMUM OF 1'-0" ABOVE ROOF AND 2'-0" ABOVE OR 8'-0" AWAY FROM PARAPETS OR WALLS.
- 11. PROVIDE FACTORY PROGRAMMABLE THERMOSTATS AND ARE TO BE LOCATED AS SHOWN.
- 12. REFER TO ARCHITECTURAL LOCATION OF DRAWINGS FOR EXACT REGISTERS, GRILLES & DIFFUSERS.
- 13. CALL FOR INSPECTION OF ALL MECHANICAL SYSTEM PRIOR TO COVER AND CONCEALMENT.

MAVEN Job #15EMB084
Tel: (480) 303-0180 ENGINEERING Fax: (480) 303-0184 2245 West University Drive, Suite 10 Tempe, Arizona 85281 Note: Any changes made to final bid

documents due to field changes will be billed hourly to the contractor.

W. Alan Kenson & Associates, F



DR

DRAWN BY AJW CHECKED BY DATE July 10, 2015 SCALE AS NOTED JOB NO. 670

#### AIR CONDITIONING SPECIFICATIONS

#### GENERAL REQUIREMENTS AND SCOPE OF WORK:

THE WORK INCLUDED UNDER THIS SECTION CONSISTS OF FURNISHING ALL MATERIALS, EQUIPMENT AND LABOR, AND THE PERFORMING OF ALL FUNCTIONS, EXCEPT AS OTHERWISE SPECIFIED HEREIN OR SHOWN ON THE DRAWINGS TO BE PERFORMED BY OTHERS, FOR THE INSTALLATION OF COMPLETE AND WORKING AIR CONDITIONING, HEATING AND VENTILATING SYSTEMS WHICH COMPLIES WITH ALL CODES. CHECK FIELD CONDITIONS AND MAKE MEASUREMENTS BEFORE ORDERING MATERIALS.

MAINTENANCE MANUAL SHALL INCLUDE ALL AVAILABLE MANUFACTURERS' OPERATION AND MAINTENANCE INSTRUCTIONS TOGETHER WITH THE RECORD DRAWINGS TO PROPERLY OPERATE AND MAINTAIN THE EQUIPMENT. THE MANUAL SHALL ALSO INCLUDE THE NAME, ADDRESS, AND PHONE NUMBER OF THE GENERAL CONTRACTOR AND ALL SUBCONTRACTORS INVOLVED IN ANY OF THE WORK SPECIFIED HEREIN.

THE CONTRACTOR MUST COMPLY WITH ALL STATE AND MUNICIPAL BUILDING AND SAFETY LAWS, ORDINANCES AND REGULATIONS RELATING TO BUILDING AND PUBLIC HEALTH & SAFETY. ALL WORK AND MATERIALS SHALL BE IN CONFORMANCE WITH THE GOVERNING CODES.

PROVIDE MECHANICAL EQUIPMENT HAVING MOTORS WITH MOTOR PROTECTORS AND INTEGRAL STARTERS. WIRING AND PROPER OPERATION OF THE MECHANICAL EQUIPMENT IS THE RESPONSIBILITY OF THE MECHANICAL CONTRACTOR. ALL WIRING SHALL BE ROUTED IN CONDUIT OR IN PLENUM RATED

THE SYSTEM SHALL HAVE A WARRANTY COVERING LABOR, MATERIALS AND EQUIPMENT FOR A PERIOD OF ONE YEAR AFTER COMPLETION AND ACCEPTANCE. REPLACE OR REPAIR ALL DEFECTIVE WORKMANSHIP, EQUIPMENT, AND MATERIALS AT NO ADDITIONAL COST TO THE OWNER.

THE MECHANICAL CONTRACTOR SHALL COORDINATE EXACT DIFFUSER AND GRILLE LOCATIONS WITH ELECTRICAL CONTRACTOR AND ALL OTHER TRADES AND ALSO COORDINATE SPACE AVAILABILITY FOR DUCTWORK ABOVE RECESSED LIGHTING TO AVOID RELOCATING DUCTWORK AT THE MECHANICAL CONTRACTORS

SHOULD A CHANGE ORDER TO THE CONTRACT DOCUMENTS BE NECESSARY. THE CONTRACTOR SHALL SUBMIT A FORMAL CHANGE ORDER TO THE ARCHITECT/ENGINEER FOR REVIEW BEFORE ANY WORK COMMENCES. ANY WORK DONE WITHOUT PRIOR WRITTEN APPROVAL IS SUBJECT TO COMPLETION AT THE CONTRACTOR'S EXPENSE. CHANGE ORDERS SHALL INCLUDE A DETAILED MATERIAL, EQUIPMENT, AND LABOR TAKE-OFF IDENTIFYING ALL NEW AND CREDITED ITEMS. COSTS FOR SUCH ITEMS SHALL NOT EXCEED THE VALUES LISTED IN THE LATEST EDITION OF THE MEANS ESTIMATING GUIDE.

PERFORM COMPLETE TESTING AND BALANCING OF ALL MECHANICAL SYSTEMS IN ACCORDANCE WITH AABC OR NEBB LATEST STANDARDS WITH REPORT. MECHANICAL CONTRACTOR TO PROVIDE BALANCE REPORT TO ARCHITECT AT FINAL INSPECTION.

USE TYPE "M" HARD DRAWN COPPER FOR ALL CONDENSATE DRAIN LINES WITH MINIMUM FALL 1/8" PER FOOT FROM UNITS TO APPROVED PLUMBING CONNECTION. PROVIDE TRAPS AT UNIT AND INSTALL OVERFLOW DRAINS AS REQUIRED BY MECHANICAL CODE. TEST CONDENSATE PIPING TO HIGHEST POINT IN SYSTEM AND HOLD FOR FOUR HOURS.

#### 3. <u>DUCTWORK:</u>

INSTALL ALL DUCTWORK IN ACCORDANCE WITH SMACNA GUIDELINES AND LOCAL STANDARDS FOR A MINIMUM OF 1" STATIC PRESSURE. RADIUS ELBOWS SHALL HAVE A MINIMUM RADIUS OF 1.5 TIMES THE DUCT DIMENSION IN THE DIRECTION OF TURN, AND SQUARE ELBOWS SHALL HAVE SINGLE THICKNESS TURNING VANES. ALL JOINTS SHALL BE TAPED WITH GLASS CLOTH AND HARDCAST OR ADHESIVE (UL LISTED). ALL DUCT SIZES ARE TO THE INSIDE OF LINING, INCREASE OUTSIDE DIMENSIONS AS NECESSARY. COVERINGS, LININGS, ADHESIVES AND INSULATION SHALL HAVE A SPREAD INDEX OF NOT OVER 25 AND A SMOKE-DEVELOPED INDEX OF NOT OVER 50. ALL INSULATION SHALL COMPLY WITH THE INTERNATIONAL ENERGY CONSERVATION CODE.

ALL INSULATION ADHESIVES & INSTALLATION SHALL COMPLY WITH NFPA\_E 84.

CONCEALED DUCTS INSIDE OF BUILDING: SHALL BE SHEET METAL WRAPPED WITH 1" THERMAL INSULATION (MINIMUM OF R-5), WITH VAPOR BARRIER COVER.

EXPOSED SQUARE DUCTS INSIDE BUILDING AND DUCTS WITHIN 10 FEET OF A MECHANICAL UNIT SHALL BE SHEET METAL LINED WITH 1" ACOUSTICAL INSULATION. EXPOSED ROUND DUCTS DO NOT REQUIRE INSULATION.

FLEX DUCT: FLEX DUCT SHALL BE CLASS 0 OR 1 AND TESTED PER UL 181.

DUCTS OUTSIDE BUILDING OR IN UNCONDITIONED CEILING OR ATTIC SHALL BE SHEET METAL LINED WITH 2" ACOUSTICAL INSULATION (MINIMUM OF R-8).

#### 4. GRILLES AND REGISTERS

GRILLES AND REGISTERS SHALL BE OF THE TYPE AND FINISH AS INDICATED ON THE DRAWINGS, COMPLETE WITH OPPOSED BLADE DAMPERS EXTRACTORS AND STRAIGHTENING GRIDS AS REQUIRED.

#### 5. START-UP FOR MECHANICAL EQUIPMENT

ALL UNITS SHALL BE INSPECTED, CHECKED, AND STARTED UP BY MANUFACTURER'S FACTORY CERTIFIED HVAC TECHNICIAN. UPON COMPLETION, MANUFACTURER SHALL PROVIDE ONE YEAR PARTS AND LABOR WARRANTY.

DESCRIPTION: PROVIDE ALL LABOR, MATERIALS, EQUIPMENT, AND SERVICES NECESSARY TO FURNISH AND INSTALL EXHAUST FANS AND BLOWERS FOR A COMPLETE AND OPERATIONAL SYSTEM. ITEMS NOT LISTED BUT REQUIRED DUE TO LOCAL CODES OR OPERATIONAL REQUIREMENTS SHALL BE INCLUDED UNDER

AND DUCT CONNECTIONS AS INDICATED OR SPECIFIED. PROVIDE INTERNAL DISCONNECTING MEANS AND OVERLOAD PROTECTION ON ALL UNITS 1/2 HP AND SMALLER AND/OR 120 VOLT, SINGLE PHASE. TWO SPEED MOTOR SHALL BE TWO WINDING TYPE. ALL BELT DRIVEN EXHAUST FANS SHALL HAVE ADJUSTABLE MOTOR PULLEYS FOR FAN SPEED CONTROL. RATE BELTS FOR 150% OF MOTOR RATED HP. ALL FANS, EXCEPT TOILET EXHAUST FANS 200 CFM AND BELOW, SHALL BE AMCA CERTIFIED AND APPROVED.

PROVIDE ROOF CAPS, WALL CAPS, FLASHINGS, BASES, SPEED SWITCHES, APPROVED VIBRATION ISOLATORS, INTEGRAL INLET GRILLES, INTEGRAL STARTERS

#### 7. FURNACE WITH EVAP COOLER: DESCRIPTION: PROVIDE ALL LABOR, MATERIALS, EQUIPMENT, AND SERVICES NECESSARY TO FURNISH AND INSTALL FURNACE, EVAP SECTION AND BLOWERS FOR A COMPLETE AND OPERATIONAL SYSTEM. ITEMS NOT LISTED BUT REQUIRED DUE TO LOCAL CODES OR OPERATIONAL REQUIREMENTS SHALL BE INCLUDED

PROVIDE FLASHINGS, BASES, SPEED SWITCHES, APPROVED VIBRATION ISOLATORS, INTEGRAL INLET GRILLES, DISPOSABLE FILTER AND ALUM MESH PREFILTER, INTEGRAL STARTERS AND DUCT CONNECTIONS AS INDICATED OR SPECIFIED. PROVIDE INTERNAL DISCONNECTING MEANS AND OVERLOAD PROTECTION ON ALL UNITS 1/2 HP AND SMALLER AND/OR 120 VOLT, SINGLE PHASE. TWO SPEED MOTOR SHALL BE TWO WINDING TYPE. ALL BELT DRIVEN EXHAUST FANS SHALL HAVE ADJUSTABLE MOTOR PULLEYS FOR FAN SPEED CONTROL. RATE BELTS FOR 150% OF MOTOR RATED HP. ALL FANS SHALL BE AMCA CERTIFIED AND APPROVED. FURNACE SECTION SHALL BE STAINLESS STEEL AND EVAPORATIVE COOLING SECTION SHALL HAVE AUTOMATIC DRAIN FEATURE FOR COLD WEATHER AND BE CEL-DECK TYPE MEDIA.

#### MECHANICAL EQUIPMENT SCHEDULE

NOTE: 1. AMBIENT TEMPERATURE 96 F COOLING, 20 F HEATING. 2. NO EQUIPMENT WITH LESS THAN 98% OF LISTED CAPACITIES WILL BE APPROVED. COOLING CAPACITY INCLUDES FAN HEAT.

PROVIDE ONE ELECTRICAL CONNECTION FOR EACH UNIT.

 APPROVED HVAC MANUFACTURERS ARE: REZNOR, CAPTUREAIRE. 5. ALL UNITS SHALL BE INSPECTED, CHECKED, AND STARTED UP BY MANUFACTURER'S FACTORY CERTIFIED HVAC TECHNICIAN. UPON COMPLETION, MANUFACTURER SHALL PROVIDE ONE YEAR PARTS AND LABOR WARRANTY.

6. RTU-A1 PROVIDE WITH TWO STAGE MAKE UP AIR HEATING, 70% AND 100%, PROGRAMMABLE T'STAT W/ AUTO CHANGE OVER AND NIGHT SETBACK, EVAP COOLER SECTION WITH ECD2 AND 12" MEDIA. PROVIDE WITH THE FOLLOWING OPTIONS AC2, AG8, AN2, AQ8, ASC4, AW21, BA6, CL52, CJ8B, CT3, CT6, DR2, ECD2, PF5, AND RC9.

		UNIT									COC	LING			HEA	TING					
MARK	MANUFACTURER	MODEL	SEER	CFM	ESP	HP	VOLT	PH	1404	SEN	тот	ENT	AIR	GAS				OSA CFM	WEIGHT LBS	NOTES	
MAKK	MANUFACIURER	MODEL	/EER	CFM	"WG"	ПР	VOLI	РП	MCA	мвн	мвн	DB	WB	мвн	STAGES			OI W	LDS		
RTU-A1	REZNOR	RDH-125	-	1500	0.5	1/2	230	1	8.6	ı	-	-	_	125	2	-	-	-	1075	NOTE 6	
EF-A1	GREENHECK	GB-091	-	675	0.5	1/4	120	1	-	1	-	-	_	-	_	-	-	-	65	INTERLOCK W/RTU-A1	41
EF-B1	GREENHECK	GB-091	-	750	0.5	1/4	120	1	-	1	-	-	_	-	_	-	-	-	65	INTERLOCK W/RTU-A1	41

LEGEND: EXHAUST FAN (EF), SPLIT SYSTEM: INDOOR UNIT (IU), OUTDOOR UNIT (OU), HEATPUMP (HP), AIR HANDLING UNIT (AHU), AIR CONDITIONER (AC), EVAPORATIVE COOLER (EC), MAKE-UP AIR UNIT (MUA)

### GRILLES, REGISTERS AND DIFFUSER SCHEDULE

NOTE: 1. PROVIDE OBD'S SHALL BE PROVIDED AT TAKE-OFF OF MAIN DUCT FOR ALL LAY-IN TYPE DIFFUSERS OR GRILLES AND OBD'S AT


THE DIFFUSER OR GRILLE WHEN FLANGE TYPE. 2. SEE SIZING SCHEDULES FOR NECK AND FLEX DUCT SIZES, UNLESS OTHERWISE DIRECTED.


3. ALL LAY-IN DIFFUSERS OR GRILLES SHALL BE WHITE IN COLOR UNLESS DIRECTED OTHERWISE. ALL FLANGE TYPE DIFFUSERS, REGISTERS OR GRILLE COLORS SHALL BE AS DIRECTED BY THE ARCHITECT.

4. CONTRACTOR SHALL PROVIDE SQUARE TO ROUND ADAPTERS AS REQUIRED FOR INSTALLATION.


MARK	DESCRIPTION	MANUFACTURER	MODEL	MATERIAL	BORDER	FRONT BLADES	DAMPER	REMARKS
CD1	CEILING DIFFUSER	TITUS	TDC	ALUMINUM	FLANGE	HORIZONTAL	OBD	-
ER1	EXH. REGISTER	TITUS	350RS	ALUMINUM	FLANGE	HORIZONTAL	_	_

N.T.S.

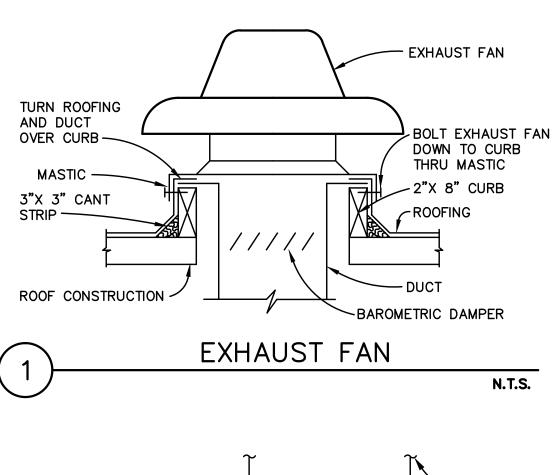

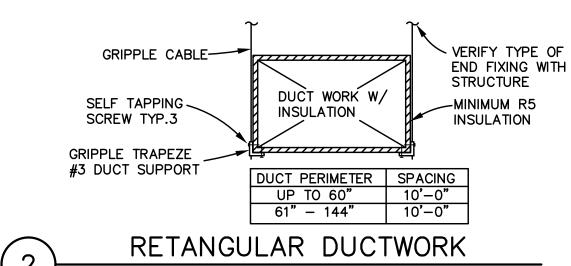

GRIPPLE SUPPORTS

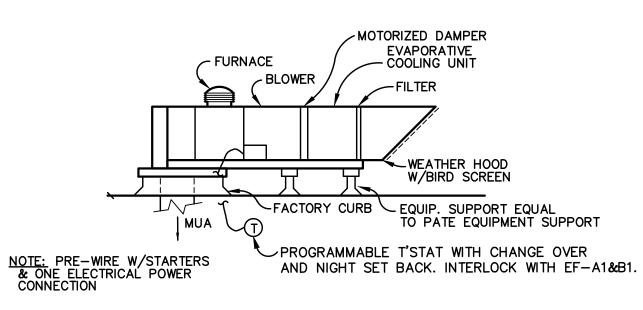

7	MAKE-UP FURNACE	
		<b>N.T.S.</b>

CINCLE			WORK SYMBOLS
SINGLE	DOUBLE	ABBR.	DESCRIPTION
<del>}                                    </del>	7	•	RECTANGULAR DUCT
ک	8	•	ROUND DUCT
+ +		•	45 DEG. TAP: USE AT BRANCH DUCTS ONLY
7-1-4		•	DUCT SPLIT W/DAMPER: USE AT ELBOWS AND TEES: PROPORTION DUCT AREAS BY CFM'S
<del> </del>		•	CURVED ELBOW-MIN. RADIUS R: 1.5 WIDTH
<del> </del>		•	90 DEG. ELBOW WITH SINGLE RADIUS TURNING VANES
<del>}</del>		•	FLEXIBLE DUCT CONNECTION
<del>}                                    </del>	Z	FD	FIRE DAMPER
<del>}                                    </del>		BD	BALANCING DAMPER (USE O.B.D. UNLESS NOTED OTHERWISE)
+		•	SPIN-IN FLEX DUCT TAKE-OFF W/DAMPER
•	$\boxtimes$	SA	SUPPLY AIR
•		EXH	EXHAUST AIR
•		RA	RETURN AIR
•	M	REL	RELIEF AIR
•	<u> </u>	OSA	OUTSIDE AIR
•	ŒΣ	Т	THERMOSTAT X: UNIT OR ZONE NUMBER
•			POINT OF CONNECTION
<b>SD</b>			SMOKE DUCT DETECTOR

AIR BALANCE SCHEDULE					
OSA CFM	UNIT NO.		EXH CFM	UNIT NO.	
1500	RTU-A1	-	1500	EF-A1	
1	ı	1	ı	ı	
1500	_	TOTAL	1500	_	

MAVEN JOD #13EMDU04
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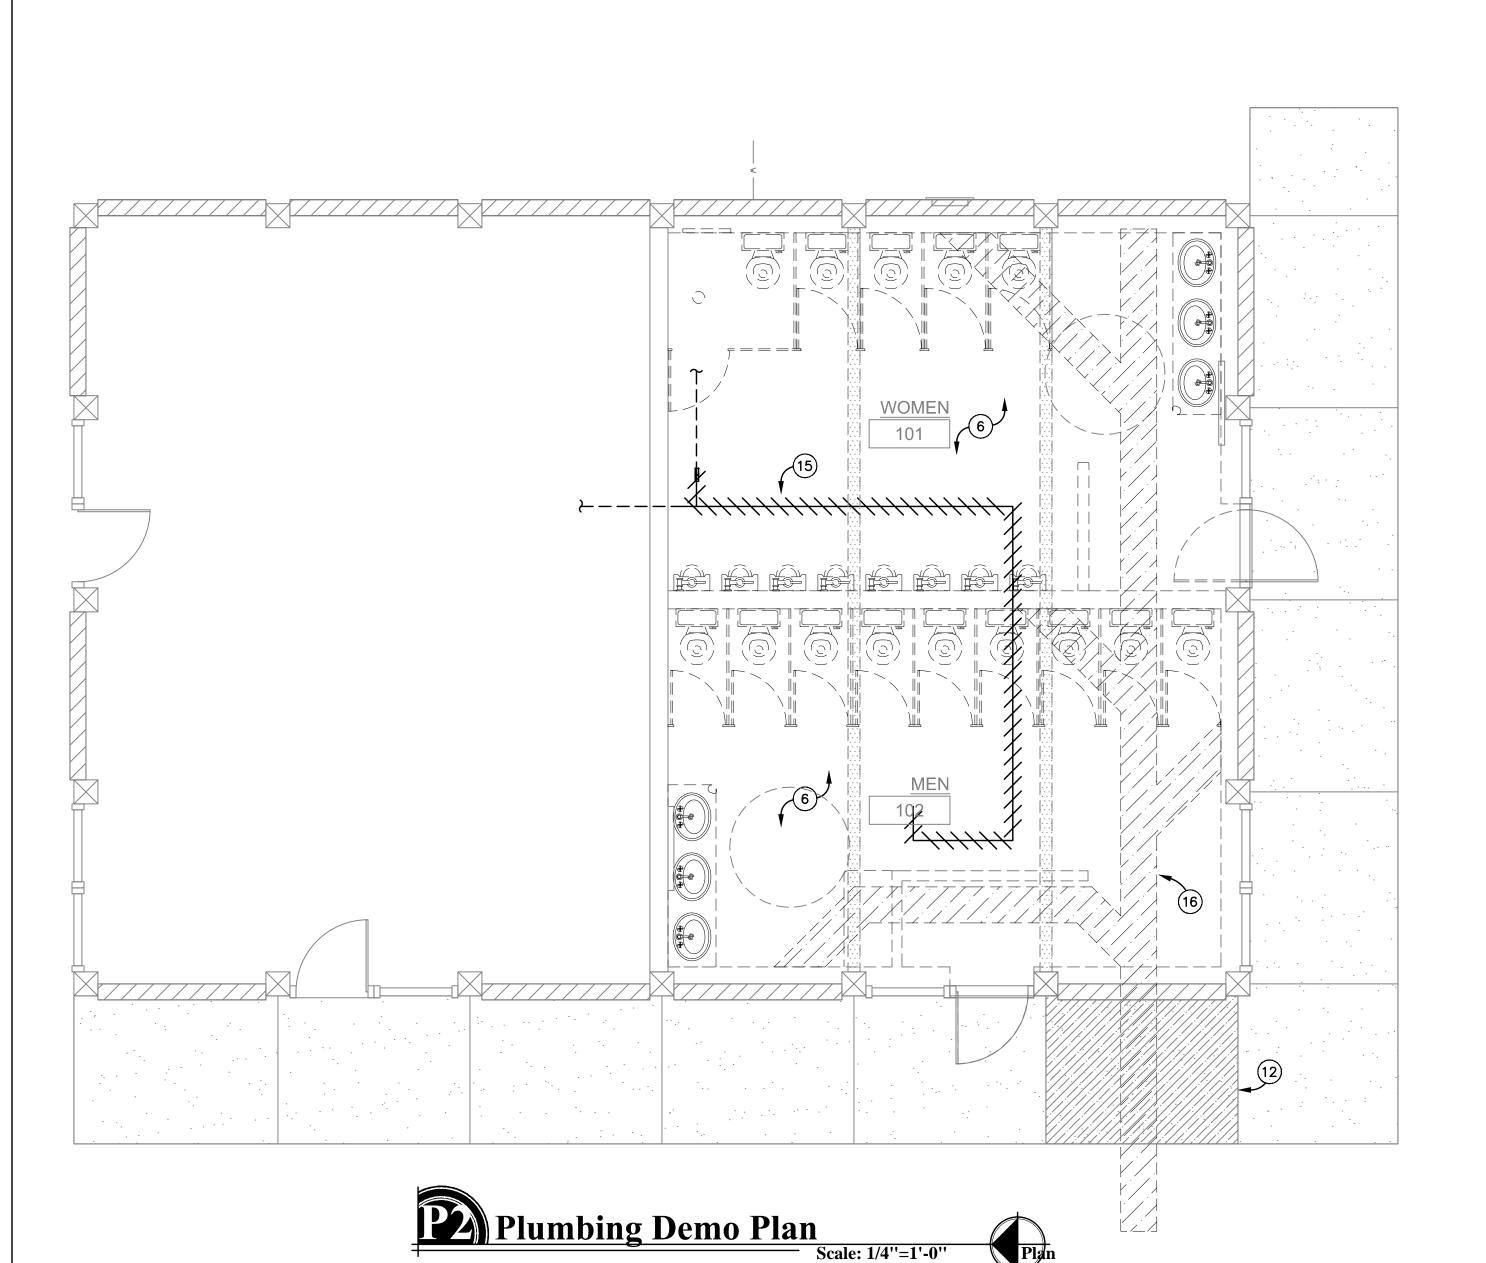
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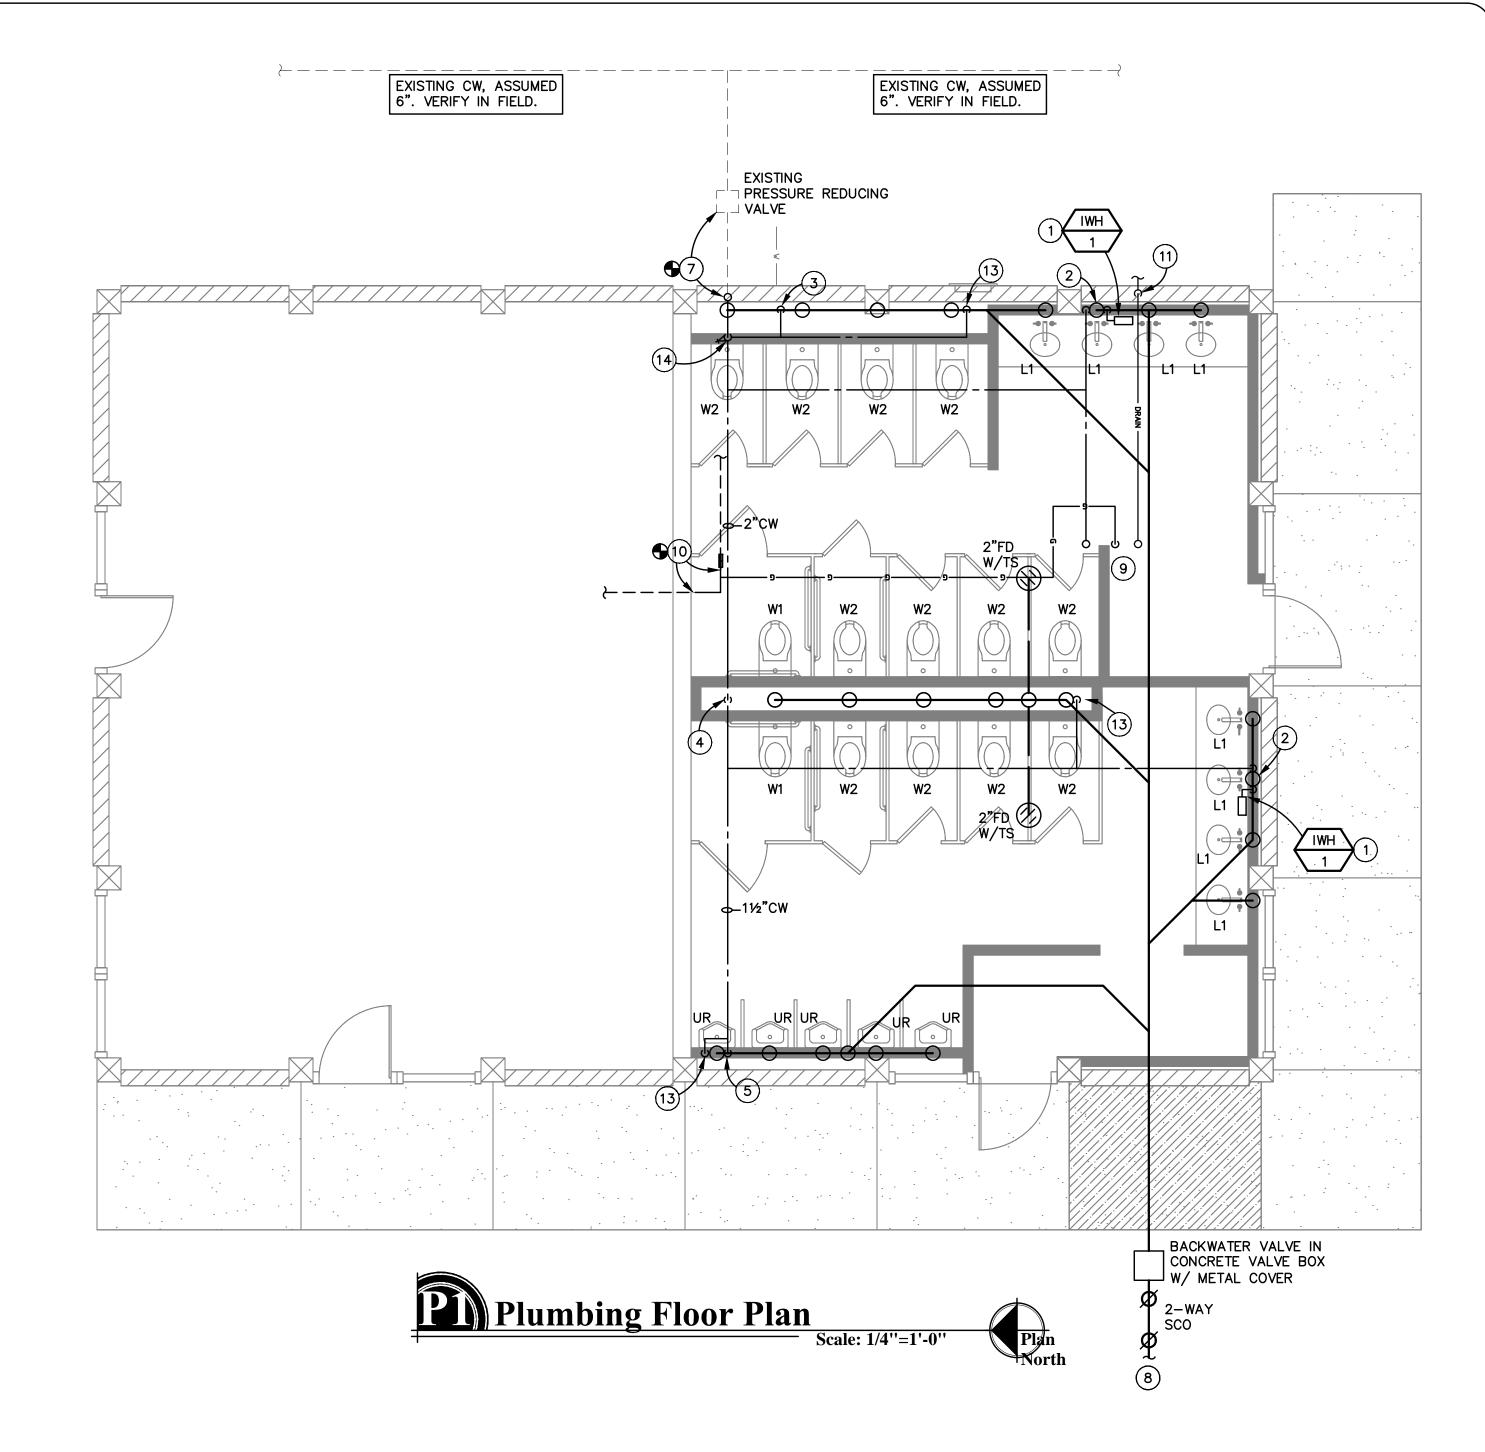
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DR DRAWN BY AJW CHECKED BY KJH DATE July 10, 2015 SCALE AS NOTED

JOB NO. 670





#### **GENERAL NOTES:**

- 1. EXACT LOCATION OF PLUMBING FIXTURES SHALL BE DETERMINED FROM ARCHITECTURAL DRAWINGS.
- 2. BEFORE SUBMITTING BID, THE PLUMBING CONTRACTOR SHALL REVIEW THE ARCHITECTURAL DRAWINGS AND INCLUDE IN HIS BID AN AMOUNT TO FURNISH AND INSTALL ANY FIXTURES WHICH ARE SHOWN IN ADDITION TO FIXTURES SHOWN ON THE PLUMBING DRAWINGS.
- 3. CONTRACTOR SHALL VERIFY INVERT ELEVATIONS OF SEWERS TO WHICH NEW WASTE LINES ARE TO BE CONNECTED BEFORE MAKING UP OR INSTALLATION OF NEW WASTE SYSTEM.
- 4. CONTRACTOR SHALL VERIFY AND COORDINATE LOCATION OF ALL PLUMBING LINES WITH DUCTWORK AND ELECTRICAL SERVICES.
- 5. THE INSTALLATION OF ALL VALVES, UNIONS, THERMOMETERS, GAUGES, OR OTHER INDICATING OR RECORDING EQUIPMENT, OR SPECIALTIES REQUIRING FREQUENT READING, REPAIRS, ADJUSTMENT, INSPECTION, REMOVAL OR REPLACEMENT SHALL BE CONVENIENTLY AND ACCESSIBLY LOCATED WITH REFERENCE TO THE FINISHED BUILDING.
- 6. ALL VENTS THROUGH ROOF SHALL BE 10'-0" REMOVED FROM ALL AIR INTAKES, EVAPORATIVE COOLERS, ETC.
- 7. WHERE POSSIBLE, TIE VENTS TOGETHER SO THAT A MINIMUM NUMBER TERMINATE THROUGH THE ROOF.
- 8. WATER CLOSETS IN PUBLIC TOILET ROOMS SHALL CENTER ON THE FINAL LAYOUT OF TOILET PARTITIONS.
- 9. CONTRACTOR SHALL NOT CUT HOLES IN STRUCTURAL MEMBERS WITHOUT FIRST SECURING WRITTEN APPROVAL FROM THE ARCHITECT.
- 10. CONTRACTOR SHALL INSTALL DIELECTRIC UNIONS AT CONNECTIONS OF DISSIMILAR
- 11. CONTRACTOR SHALL ROUGH-IN ALL WASTES AND SUPPLIES TO SPECIAL EQUIPMENT ACCORDING TO MANUFACTURERS SHOP DRAWINGS AND MAKE FINAL CONNECTIONS. ALL SUPPLIES SHALL BE VALVED.
- 12. ASSUMED WATER PRESSURE-CONTRACTOR SHALL VERIFY ACTUAL WATER PRESSURE PRIOR TO CONSTRUCTION. IF PRESSURE IS LESS THAN 50 PSI CONTRACTOR SHALL CONTACT THE ENGINEER FOR PIPE SIZING EVALUATION. IF PRESSURE EXCEEDS 80 PSI. A PRESSURE REDUCING VALVE SHALL BE PROVIDED. PIPING VELOCITY SHALL NOT EXCEED 8 FEET PER SECOND.

### FIELD VERIFICATION NOTES:

- 1. THE PLUMBING CONTRACTOR SHALL VISIT THE SITE PRIOR TO BID TO FIELD VERIFY ALL EXISTING CONDITIONS WHICH MAY AFFECT HIS BID. THE FOLLOWING ITEMS SHALL BE VERIFIED.
- 1.A. EXACT PLACEMENT, SIZE, CAPACITY, MANUFACTURER, AND CONDITION OF ALL EXISTING PLUMBING EQUIPMENT WITHIN SCOPE OF WORK, WHETHER SPECIFICALLY
- SHOWN OR NOT. 1.B. SIZE AND LOCATION OF ALL EXISTING WASTE, VENT AND WATER PIPING.
- 2. ALL REFERENCES ON THESE DRAWINGS TO EXISTING EQUIPMENT, WATER, WASTE, AND VENT PIPING ARE FOR REFERENCE ONLY. IT IS THE RESPONSIBILITY OF THE CONTRACTOR TO VERIFY ALL THESE ITEMS PRIOR TO BID AND INCLUDE IN HIS BID ANY AND ALL AMOUNTS REQUIRED TO ACCOMMODATE EXISTING CONDITIONS.
- 3. NO ALLOWANCES WILL BE MADE AFTER THE PROJECT HAS BEEN AWARDED FOR FAILURE TO VERIFY EXISTING CONDITIONS.
- 4. ANY DISCREPANCIES WHICH MAY AFFECT THE CONTRACTORS BID SHALL BE BROUGHT TO THE ATTENTION OF THE ENGINEER AND ARCHITECT FOR DIRECTION

#### PIPING MATERIALS

SANITARY WASTE AND VENT SYSTEMS

<u>PIPING:</u>
ABS CONFORMING TO ASTM D 2661.

DOMESTIC WATER SYSTEM

PIPING:
TYPE "L" HARD DRAWN COPPER, CONFORMING TO ASTM B-88. TYPE "K" HARD DRAWN COPPER, CONFORMING TO ASTM B-88. TYPE "K" SOFT DRAWN COPPER, CONFORMING TO ASTM B-88.

FUEL GAS SYSTEM

BLACK STEEL PIPE, SCHEDULE 40 BLACK STEEL CONFORMING TO ASTM A-53, GRADE A OR B, SEAMLESS OR WELDED PIPE.

#### **KEYED NOTES:**

- 1. 34"CW TO IWH. PROVIDE 1/2"HW TO EACH L1.
- 2. 34"CW DOWN IN WALL. PROVIDE 1/2"CW TO EACH L1 AND 3/4"CW TO IWH.
- 3. 2"CW DOWN IN WALL. PROVIDE 11/4"CW TO EACH W2 W/ SHOCK ABSORBER.
- 4. 2"CW DOWN IN WALL. PROVIDE 11/4"CW TO EACH W1 AND W2 W/ SHOCK ABSORBER.
- 5. 11/2"CW DOWN IN WALL. PROVIDE 1"CW TO EACH UR W/ SHOCK ABSORBER.
- 6. ALL EXISTING PLUMBING FIXTURES TO BE REMOVED. CAP ALL WASTE IN FLOOR AND WATER IN CEILING.
- 7. UPSIZE EXISTING 11/2"CW TO 21/2" AND CONNECT NEW CW. VERIFY EXACT LOCATION IN
- 8. EXTEND AND CONNECT NEW WASTE TO EXISTING. VERIFY EXACT LOCATION AND INVERT IN FIELD.
- 9. 1/2"CW AND 3/4"GAS TO AND 3/4"DRAIN DOWN FROM RTU.
- 10. CONNECT NEW 3/4"GAS TO REGULATOR. 11. 34"DRAIN DOWN IN WALL TO TERMINATE AT EXTERIOR.
- 12. PORTION OF EXISTING SIDEWALK TO BE REMOVED AND REPLACED. REFER TO ARCH.
- 13. SHOCK ABSORBER. SEE DETAIL FOR SIZING.
- 14. 21/2"SOV IN WALL BEHIND NEW ACCESS PANEL ALL DISTRIBUTION SHALL BE DOWNSTREAM.
- 15. REMOVE ALL EXISTING GAS AS SHOWN BACK TO MAINLINE. SEE GAS SCHEMATIC SHT P2.0 FOR REPLACEMENT SIZING.
- 16. EXISTING FLOORING TO BE TRENCHED FOR NEW WASTE LINES AS SHOWN. SEE ARCH

MAVEN Job #15EMBU84
Tel: (480) 303-0180 ENGINEERING Fax: (480) 303-0184 2245 West University Drive, Suite 10 Tempe, Arizona 85281 Note: Any changes made to final bid documents due to field changes will

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DR

DRAWN BY KEF CHECKED BY DATE July 10, 2015 SCALE AS NOTED JOB NO. 670

1. SCOPE
THE WORK SPECIFIED UNDER THIS CONTRACT INCLUDES THE FURNISHING OF ALL LABOR, MATERIALS, TOOLS, TRANSPORTATION, SERVICES, PERMITS, INSPECTION FEES, ETC., REQUIRED IN THE COMPLETE INSTALLATION OF PLUMBING WORK AS SPECIFIED HEREIN AND SHOWN ON ACCOMPANYING DRAWINGS AND AS REQUIRED BY THE CONDITIONS AT THE SITE. THE GENERAL AND SPECIAL CONDITIONS ARE HEREBY MADE A PART OF THIS SECTION. IN ADDITION, WORK IN THESE SECTIONS ARE GOVERNED BY ALL PROVISIONS OF THE CONTRACT DOCUMENTS.

SUBMIT SHOP DRAWINGS AND ALL DATA REQUIRED IN ACCORDANCE WITH DETAILED REQUIREMENTS OF DIVISION 1, GENERAL REQUIREMENTS, FOR ALL WORK PROVIDED UNDER DIVISION 15.

RECORD DRAWINGS PROVIDE RECORD DRAWINGS WHICH SHALL CLEARLY SHOW ALL DIFFERENCES BETWEEN THE CONTRACT WORK AS DRAWN AND INSTALLED. PIPING MAINS BELOW SLAB AND/OR GRADE AND ALL BRANCH LINES BELOW SLAB OR GRADE IN EXCESS OF 5 FT. IN LENGTH SHALL BE DIMENSIONED FROM COLUMNS OF ANY PERMANENT STRUCTURE. ALSO, SHOW ALL WORK ADDED TO THE CONTRACT WHICH IS NOT SHOWN ON THE CONTRACT DRAWINGS.

4. EQUIPMENT LIST AND MAINTENANCE MANUAL MAINTENANCE MANUAL SHALL INCLUDE ALL AVAILABLE MANUFACTURERS' OPERATION AND MAINTENANCE INSTRUCTIONS TOGETHER WITH THE RECORD DRAWINGS HERE IN BEFORE SPECIFIED AND ALL OTHER DIAGRAMS AND INSTRUCTIONS NECESSARY TO PROPERLY OPERATE AND MAINTAIN THE EQUIPMENT. THE MANUAL SHALL ALSO INCLUDE THE NAME, ADDRESS, AND PHONE NUMBER OF THE GENERAL CONTRACTOR AND ALL SUBCONTRACTORS INVOLVED IN ANY OF THE WORK SPECIFIED

5. CODES, PERMITS, FEES, INSPECTIONS, RULES & REGULATIONS
THE CONTRACTOR MUST COMPLY WITH ALL STATE AND MUNICIPAL BUILDING AND SAFETY LAWS, ORDINANCES AND REGULATIONS, RELATING TO BUILDING AND PUBLIC HEALTH AND SAFETY. ALL WORK SHALL BE IN CONFORMANCE WITH THE GOVERNING CITY CODES.

NATURAL GAS: CONTRACTOR MUST, AT HIS OWN EXPENSE, SUBMIT ALL NECESSARY DRAWINGS TO SOUTHWEST GAS.

COMPLETE ALL SAW CUTTING, EXCAVATION AND BACKFILL AS NECESSARY FOR THE INSTALLATION OF UNDERGROUND PIPING. COMPACT AND TAMP BACKFILL TO ORIGINAL GRADE AND REMOVE EXCESS DIRT AS DIRECTED. NO WORK SHALL BE COVERED UNTIL PROPERLY TESTED AND APPROVED. ALL PAVEMENT, SIDEWALK, PIPING, ELECTRICAL CONDUIT, ETC., CAUSED TO BE CUT OR DAMAGED BY THIS SECTION SHALL BE RESTORED TO ORIGINAL CONDITION BY WORKMEN QUALIFIED AND ACTIVE IN THE TRADES INVOLVED.

7. ELECTRIC WIRING ALL POWER WIRING IS INCLUDED IN ELECTRICAL DRAWINGS.

WARRANT THE SYSTEM, LABOR, MATERIALS AND EQUIPMENT FOR ONE (1) YEAR AFTER COMPLETION AND ACCEPTANCE. REPLACE OR REPAIR ALL DEFECTIVE WORKMANSHIP, EQUIPMENT, AND MATERIALS AT NO ADDITIONAL COST TO THE OWNER.

PROVIDE ALL LABOR, MATERIALS, EQUIPMENT, AND SERVICES NECESSARY TO FURNISH AND INSTALL COMPLETE PLUMBING AND PIPING SYSTEMS AS INDICATED OR SPECIFIED. INSTALL AND DELIVER ALL SYSTEMS COMPLETE, IN PERFECT WORKING ORDER, AND IN FULL ACCORDANCE WITH THE INTENT AND MEANING OF THE DRAWINGS AND SPECIFICATIONS. THE WORK, IN GENERAL, CONSISTS OF, BUT IS NOT NECESSARILY LIMITED TO, THE FOLLOWING:

COMPLETE SANITARY PLUMBING SYSTEMS FOR THE BUILDING WITH CONNECTIONS FROM EXISTING LINE IN THE BUILDING. COMPLETE GAS SYSTEM PIPING AS INDICATED.

DDMESTIC WATER SYSTEM INCLUDING CONNECTION TO EXISTING STUB OUT, AND CONNECTIONS TO ALL PLUMBING FIXTURES AND EQUIPMENT.

ROUGH-IN AND FINAL CONNECTIONS OF WASTE AND WATER AND NATURAL GAS TO EQUIPMENT, CONDENSATE DRAIN PIPING, P-TRAPS, WASTE TUBING STOPS, FLEXIBLE TUBE RISERS, ETC. AS REQUIRED.

VALVED DUTLETS AND CONNECTIONS TO ALL HEATING, AIR CONDITIONING, OR ELECTRICAL EQUIPMENT WITH LOCATION AS REQUIRED.

INSULATION INCLUDING DOMESTIC HOT WATER SUPPLY PIPING EQUAL TO ARMAFLEX 3" THICK RUBBER SELF-SEAL PIPE

FUEL GAS SYSTEM, INCLUDING METER, SERVICE LINE, AND VALVED CONNECTIONS TO ALL EQUIPMENT USING SAME.

PLUMBING SPECIALTIES, INCLUDING CLEAN-DUTS, DRAINS, FIXTURE SUPPORTS, INTERCEPTORS, ETC.

PLUMBING EQUIPMENT AS SPECIFIED AND SCHEDULED.

PLUMBING FIXTURES AS SPECIFIED.

ADEQUATE SUPERVISION OF ERECTION, BALANCING, ADJUSTMENTS AND INSTRUCTIONS FOR PROPER OPERATION AND

STERILIZATION OF POTABLE WATER SYSTEM.

1<u>O. APPROVED MANUFACTURERS</u>
SPECIFICATION HEREIN BY BRAND NAME IS INTENDED TO ESTABLISH A STANDARD OF QUALITY. FURTHER, THIS EQUIPMENT HAS BEEN CHECKED AS TO SIZE AND WEIGHT REQUIREMENTS AND SPACE ALLOCATION HAS BEEN MADE ACCORDINGLY.

SUBMITTAL OF EQUIPMENT BY OTHER MANUFACTURERS IS NOT ACCEPTABLE.

MANUFACTURERS INDICATE A STANDARD OF QUALITY, OTHER MANUFACTURES MUST BE PRIOR APPROVED AS AN EQUAL. SANITARY WASTE VENT AND STORM DRAINAGE: ABS CONFORMING TO ASTM D 2661.

DOMESTIC WATER: TYPE "L" HARD DRAWN COPPER, CONFORMING TO ASTM B-88, TYPE "K" HARD DRAWN COPPER CONFORMING TO ASTM B-88, TYPE "K" SOFT DRAWN COPPER CONFORMING TO ASTM B-88.

NATURAL GAS: PIPE, BLACK STEEL PIPE, SCHEDULE 40 BLACK STEEL CONFORMING TO ASTM A-53, GRAD A OR B,

GENERAL: WRAP ALL GAS PIPING INSTALLED BELOW GRADE OR EXPOSED TO WEATHER IN ACCORDANCE WITH MANVILLE SPECIFICATION 220. PROVIDE CATHODIC PROTECTION FOR GAS PIPING INSTALLED BELOW GRADE.

CLEAN DUTS: INTERIOR CONCRETE AND TILE FLOORS: "JR SMITH 4020". INTERIOR FINISHED WALLS: "JR SMITH 4402". EXTERIOR AREAS: "JR SMITH 4250".

FLOOR DRAINS: TOILET ROOMS AND FINISHED AREAS: "J. R. SMITH #2005-A".

BALL VALVES: NIBCO #S-585-70, 150# SOLDER JOINT FOR ALL LINES UP TO 2" IN DIAMETER.

CHECK VALVES: NIBCO #S-413-Y, 150# SOLDER JOINT FOR ALL VALVES UP TO 2" IN DIAMETER.

GLOBE VALVES: NIBCO #S-235-Y, 150# SOLDER JOINT FOR ALL VALVES UP TO 2" IN DIAMETER.

FIXTURES: USE POLISHED CHROME PLATED, ADJUSTABLE BRASS P-TRAPS AND WASTE ARMS WITH WALL ESCUTCHEONS AT ALL EXPOSED LOCATIONS. USE POLISHED CHROME PLATED FAUCETS WITH REMOVABLE TRIP, BRASS BODY AND BRASS HANDLES. FIXTURES AND SUPPLY FITTING SHALL BE AS SPECIFIED. PROVIDE DIAPHRAGM TYPE POLISHED CHROME PLATED FLUSH VALVES WITH INTEGRAL VACUUM BREAKERS AND SCREW DRIVER STOPS. PROVIDE FIXTURE STOPS AND VALVES AHEAD OF ALL EQUIPMENT OR FIXTURES. AFTER FIXTURES ARE SET IN PLACE AND SECURED TO WALLS, CAULK ALL AROUND BETWEEN FIXTURES AND WALL WITH EITHER "DOW CORNING #780" OR G. E. CONSTRUCTION SEALANT" WHITE SILICONE CAULKING COMPOUND.

SEAMLESS WELDED PIPE.

12. INSTALLATION
THE ENTIRE PLUMBING SYSTEM SHALL BE INSTALLED IN A NEAT, WORKMANLIKE, FINISHED, AND SAFE MANNER. CONCEAL ALL PIPING IN FINISHED AREAS UNLESS NOTED OTHERWISE. ALL PIPING SHALL BE ADEQUATELY SUPPORTED AND INSTALLED PARALLEL WITH THE BUILDING WALLS. THE ENTIRE INSTALLATION SHALL BE SUBJECT TO THE ARCHITECT'S APPROVAL.


13. TESTS
TEST WATER PIPING TO 100 PSI AND HOLD FOR 4 HOURS.

TEST SEWER AND VENT PIPING WITH A 10 FOOT HEAD OF WATER FOR 4 HOURS. TEST FUEL GAS SYSTEM TO 50 PSI AIR PRESSURE AND HOLD FOR 4 HOURS.

REPAIR ALL LEAKS UNTIL SYSTEMS ARE WATERTIGHT.

END OF SECTION



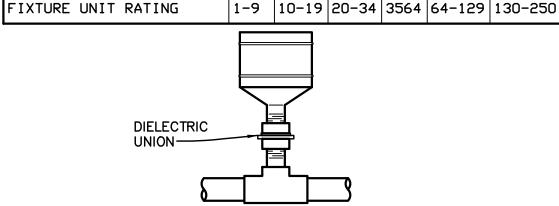

1. CONTRACTOR SHALL FURNISH & INSTALL SHOCK ABSORBERS ON ALL FLUSH VALVE OPERATED FIXTURES OR FIXTURES W/QUICK CLOSING VALVES.


2. WHEN WATER PRESSURE IN THE LINE IS OVER 65 PSI, INSTALL THE NEXT

3. CONTRACTOR SHALL PIPE AIR CHAMBERS 12" LONG & (2) PIPE SIZES LARGER THAN SUPPLY LINE AT ALL ISOLATED FIXTURES OR BATTERY OF FIXTURES NOT REQUIRING SHOCK ABSORBERS.

4. SIZE OF SHOCK ABSORBERS REQUIRED ON BATTERY OF FIXTURES SHALL BE BASED ON FIXTURE UNIT VALVES OF FLUSH VALVE OPERATED FIXTURES ONLY.

5. SHOCK ABSORBERS MANUFACTURED BY SIOUX CHIEF, ZURN, JOSAM OR WADE EQUAL TO LIST ABV. ARE APPROVED.

## SHOCK ABSORBER DETAIL

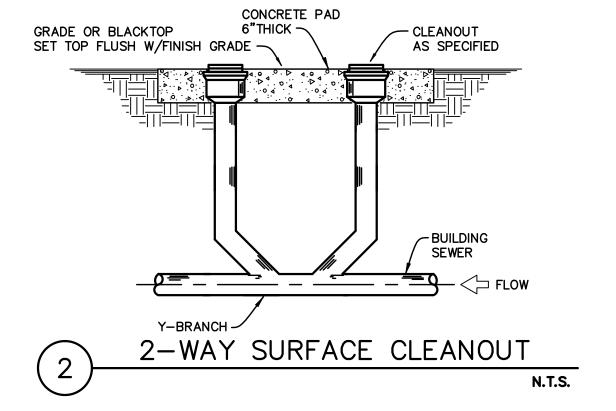

	PLUMBING S	SYMBOL	LIST
SYMBOL	DESCRIPTION	SYMBOL	DESCRIPTION
—GW—	GREASE WASTE (GW)	•	POINT OF CONNECTION
	EXISTING (E)	A	SHUT OFF VALVE (GATE)
	SOIL WASTE LINE (W)	1	CHECK VALVE
	VENT LINE (V)		UNION
	COLD WATER (C.W.)	— ऐ⊢—	LUBRICATED PLUG VALVE
	HOT WATER (H.W.)		HOSE BIBB (H.B.)
—	HOT WATER RETURN	<b>—</b> —	BRANCH RISE OFF MAIN
— G —	GAS LINE	<b>Ø</b> S.C.O.	SURFACE CLEANOUT
—TW—	TEMPERED WATER	<b>Ø</b> F.C.O.	FLOOR CLEANOUT
—sw—	SOFT WATER	$\rightarrow$	GLOBE VALVE
	BUILDING SEWER		BALL VALVE
<b>Ø</b>	FLOOR DRAIN (F.D.)	-R.D.L	ROOF DRAIN LEADER
$\boxtimes$	FLOOR SINK (F.S.)	-0.D.L	OVERFLOW DRAIN LEADER
•	ROOF DRAIN (R.D.)	— CD —	CONDENSATE DRAIN LINE
0	OVFR FLOW DRAIN	-ICW-	INDUSTRIAL COLD WATER

NOTE: ONLY THOSE SYMBOLS SHOWN ON THE DRAWING APPLY

DESCRIPTION

HANDICAP WATER CLOSET

WALL MOUNTED

FLUSH VALVE

WATER CLOSET

WALL MOUNTED

FLUSH VALVE

WALL MOUNTED

FLUSH VALVE

OVAL SELF RIMMING

LAVATORY

VITREOUS CHINA

FLOOR DRAIN

INSTANTANEOUS

WATER HEATER

	FLOMDING 3	TWIDOL	LIST
SYMBOL	DESCRIPTION	SYMBOL	DESCRIPTION
—GW−	GREASE WASTE (GW)	•	POINT OF CONNECTION
	EXISTING (E)	\  \  \  \  \  \  \  \  \  \  \  \  \  \	SHUT OFF VALVE (GATE)
	SOIL WASTE LINE (W)	1	CHECK VALVE
	VENT LINE (V)		UNION
	COLD WATER (C.W.)	<b>│</b>	LUBRICATED PLUG VALVE
	HOT WATER (H.W.)		HOSE BIBB (H.B.)
	HOT WATER RETURN	<del></del>	BRANCH RISE OFF MAIN
— в —	GAS LINE	<b>Ø</b> S.C.O.	SURFACE CLEANOUT
-TW-	TEMPERED WATER	<b>Ø</b> F.C.O.	FLOOR CLEANOUT
-sw-	SOFT WATER	<u></u>	GLOBE VALVE
———	BUILDING SEWER		BALL VALVE
0	FLOOR DRAIN (F.D.)	-R.D.L	ROOF DRAIN LEADER
$\boxtimes$	FLOOR SINK (F.S.)	-0.D.L	OVERFLOW DRAIN LEADER
•	ROOF DRAIN (R.D.)	— CD —	CONDENSATE DRAIN LINE
0	OVER FLOW DRAIN	-ICW-	INDUSTRIAL COLD WATER
110	TC		

PLUMBING FIXTURE SCHEDULE

FITTING & CAPACITY

OPTIMA #8111-1.28

1.28 GAL PER FLUSH

OPTIMA #8111-1.28

1.28 GAL PER FLUSH

OPTIMA #8186

1.0 GAL PER FLUSH

"SLOAN'

#EBF-650-BDT

W/ MIXING VALVE

"J.R.SMITH"

TRAP SEAL

#2692

31 AMPS

"SLOAN'

FIXTURE SPECIFICATIONS

MANUFACTURER

AND

MODEL NUMBER

"AMERICAN STANDARD"

MODEL#

AFWALL 3351.001

'AMERICAN STANDARD'

MODEL#

AFWALL 3351.001

MERICAN STANDARD

MAYBROOK

#6581.015

MERICAN STANDAR

AQUALYN #0476.028

WHÏTE

"J.R.SMITH

#2005-A


STIEBEL ELTRON

MINI 3.5

#232099

2" — WCO WCO L1	wco L1U	WCO (TYP)  BACKWATER VALVE  2-WAY SCO VALVE
<u> </u>		× *

Waste & Vent Schematic

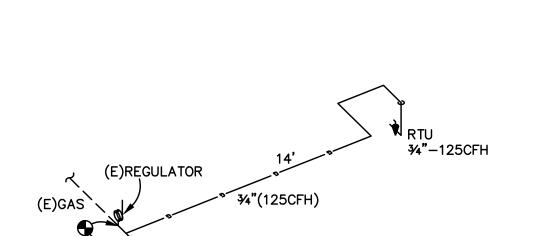

SIZING BASED ON 2000 IFGC TABLE 402(2) WITH A MAXIMUM CONNECTED LOAD OF 185 CFH AND A TOTAL LENGTH OF 20' FEET.

Scale: N.T.S.

8.0 PSI DROP  PIPE SIZE GPM FU (FT) FU (FV)  1/2" 3 3				
½"     3     3     -       ¾"     8     11     -       1"     18     25     -       1¼"     30     55     14		8.0	PSI DROP	)
11/4" 30 55 14	PIPE SIZE	<u>GPM</u>	FU (FT)	<u>FU (FV)</u>
11/4" 30 55 14	1/2"	3	3	_
11/4" 30 55 14	3/4"	8	11	-
1¼"       30       55       14         1½"       44       103       35         2"       77       259       135         2½"       120       479       365         3"       170       748       739	1"	18	25	-
1½"       44       103       35         2"       77       259       135         2½"       120       479       365         3"       170       748       739	1 <i>1</i> ⁄4"		55	14
2"       77       259       135         2½"       120       479       365         3"       170       748       739	1½ <b>"</b>			
2½" 120 479 365 3" 170 748 739	2"			
<b>3"</b> 170 748 739	21/2"	120	479	365
	3"	170	748	739

ACCESSORIES/

REMARKS

JR SMITH #0210 SERIES

WALL SUPPORT

W/ TOTO #534 SEAT

JR SMITH #0210 SERIES

WALL SUPPORT

W/ TOTO #534 SEAT

JR SMITH #0615

WALL SUPPORT

1/4 TURN ANGLE STOPS & RISER TAILPIECE

P-TRAP

SQUARE TOP

32°F RISE @ .75 GPM FLOW RAT

120V/1ø

FIXTURE CONNECTIONS

1/2"

3/4"

H.W. WASTE VENT

2"

11/2"

11/2"

(E)GAS

(60CFH)

D.T.D.G	60 PSI		
BLDG. HEIGHT:	20		
60.00 PSI PRE	SSURE IN MAIN		
	SSURE REQUIRED AT	FURTHEST	FIXTURE
40.00 PSI SUB			
	SSURE DROP THRU EX	KISTING ME	TER
10.00 PSI DRO	P THRU RPPBFP		
23.00 PSI SUB			
	P FOR ELEVATION		
	OWABLE FOR PIPE F	RICTION	
TOTAL LENGTH OF I	WTR SYSTEM		40
EQUIVALENT FEET (	OF PIPE ALLOWED FO	)R	
	TTINGS, ETC.		13.2
TOT. DEVELOPED LI	ENGTH OF WTR SYSTE	CM=	53.2
*****	** *** ******* **	*****	**** *****
	TION LOSS =	=	27.0 PSI/100'
* ALLOWABLE FRIC			
	** *** ******* **	*****	**** *****
	** *** ******* **	*****	**** *****
	** *** ******* **	*****	**** *****
	** *** ****** ** 2 FU =	***** ** 16 FU	
******			
******* ****** 8 LAV	2 FU =	16 FU	
****** 8 LAV 14 WC	2 FU = 10 FU =	16 FU 140 FU	
****** 8 LAV 14 WC	2 FU = 10 FU =	16 FU 140 FU	
****** 8 LAV 14 WC	2 FU = 10 FU = 5 FU =	16 FU 140 FU 25 FU	

WATER CALCULATION

Tel: (480) 303-018	A	Job #15EMB084
	MAVEN ENGINEERING	Tel: (480) 303-018

DRAWN BY

CHECKED BY

DATE July 10, 2015

SCALE AS NOTED

JOB NO.

KEF

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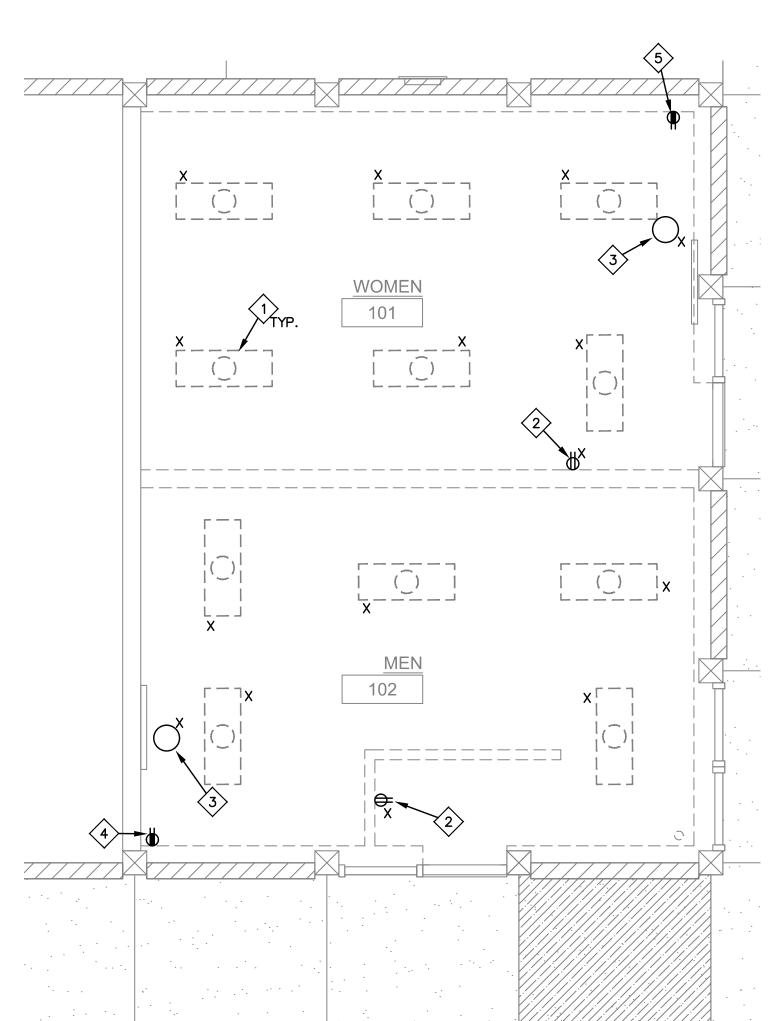
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No. 24488

**EXPIRES 03/31/18** 

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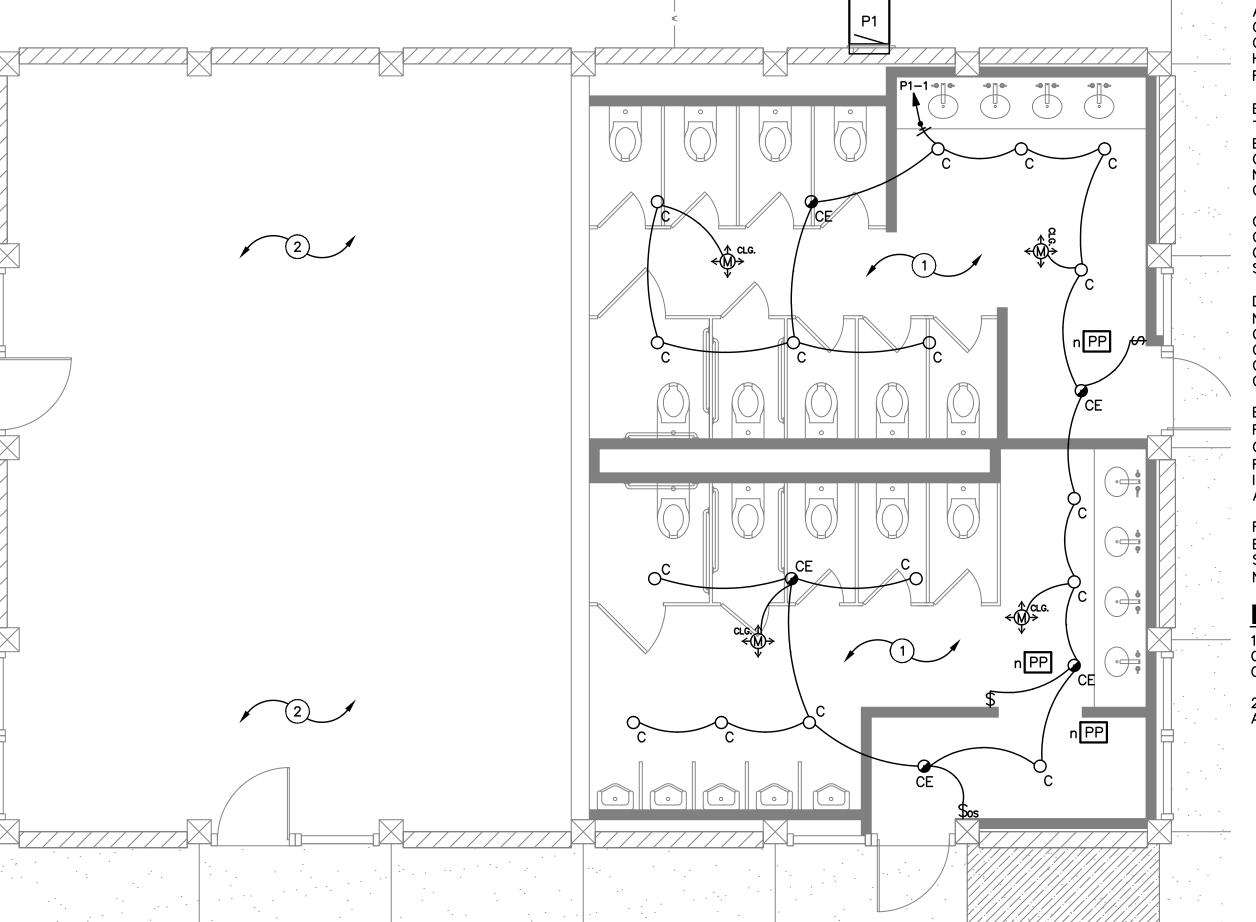


**Scale:** 1/4''=1'-0''

### KEYED NOTES:

- 1. DEMOLISH EXISTING SURFACE MOUNTED LIGHTS. 2. DEMOLISH EXISTING DRINKING FOUNTAIN OUTLET. CONTRACTOR TO VERIFY EXISTING CIRCUIT AND REUSE OR SPARE OUT AS NEEDED.
- 3. DEMOLISH EXISTING WATER HEATER. CONTRACTOR TO VERIFY EXISTING CIRCUIT AND REUSE AS NEEDED.
- 4. DEMOLISH EXISTING COUNTER TOP GFCI RECEPTACLE CONTRACTOR TO VERIFY EXISTING CIRCUIT

5. REMOVE EXISTING OUTLET AND PROVIDE NEW COUNTER TOP GFCI RECEPTACLE. CONTRACTOR TO VERIFY EXISTING CIRCUIT AND REUSE. SEE SHEET



#### LIGHTING

#### **GENERAL NOTES:**

A. PRIOR TO ROUGH-IN, THE ELECTRICAL CONTRACTOR SHALL COORDINATE THE EXACT LOCATION OF ALL LIGHT FIXTURES: TO INCLUDE MOUNTING HEIGHTS AND LOCATIONS. ALL CONFLICTS SHALL BE REPORTED TO THE ENGINEER/ARCHITECT.

B. THE ELECTRICAL CONTRACTOR SHALL (PRIOR TO THEIR BID) a) VISIT THE SITE AND FIELD VERIFY ALL EXISTING CONDITIONS AND b) TAKE ALL CONSIDERATIONS INTO ACCOUNT AT THE TIME OF BID. NO CONSIDERATIONS WILL BE GRANTED THE CONTRACTOR AFTER THE BID IS ACCEPTED.

C. THE ELECTRICAL LIGHTING INSTALLATIONS SHALL CONFORM TO ALL STATE AND LOCAL SEISMIC AND CODE REQUIREMENTS REGARDING LIGHT FIXTURE

D. ALL ELECTRICAL METALLIC TUBING (EMT), RIDGED NON-METALLIC CONDUITS, "SEAL TIGHT" TYPE CONDUITS AND ALL OTHER CONDUITS THAT DO NOT CONTAIN A CODE SIZED GROUND WIRE SHALL HAVE A CODE SIZED BOND WIRE INSTALLED WITH THE CIRCUIT CONDUCTORS.

E. ALL FIXTURES INSTALLED OUTDOORS SHALL BE RATED FOR DAMP/WET LOCATIONS AS REQUIRED. THE CONTRACTOR SHALL COORDINATE DAMP/WET LOCATION RATING PER NEC ARTICLE 410.10(A). ALL INSTALLATIONS SHALL CONFORM TO NEC ARTICLE 410, ALL SUB ARTICLES.

F. ALL FLUORESCENT FIXTURES THAT UTILIZE DOUBLE ENDED LAMPS AND CONTAIN BALLAST(S) THAT CAN BE SERVICED IN PLACE SHALL BE CODE COMPLIANT WITH N.E.C. 410.130(G)

#### KEYED NOTES: #

1. PROVIDE NEW CAN LIGHTING IN THIS AREA CONNECT CONNECT TO EXISTING LOCAL AREA LIGHTING

2. EXISTING LIGHTING & POWER TO REMAIN IN THIS



Catalog Number nLIGHT LOW VOLTAGE SWITCH SENSOR SWITCH WSX PDT SA WH SENSOR SWITCH LINE VOLTAGE WALL SWITCH DUAL TECH VACANCY SENSOR \$<sub>os</sub> nLIGHT POWER PACK-MULTI VOLT nLIGHT RECESSED MOUNT DUAL TECH MOTION SENSOR

FIXTURE / ITEM IDENTIFIED WITH LETTER: 'E' - INDICATES EXISTING TO REMAIN. 'N' - INDICATES NEW TO MATCH EXISTING. 'R' - INDICATES EXISTING TO BE RELOCATED. 'X' - INDICATES EXISTING TO BE REMOVED.

**B2** Electrical Demo Plan

			LUMINA	IRE SCHEDULE				
CALLOUT	SYMB0L	LAMP	MODEL	DESCRIPTION	BALLAST	MOUNTING	INPUT WATTS	VOLTS
С	0	18.4W LED	LITHONIA LIGHTING LDN6-40/10-6AR-120	6" LED DOWNLIGHT, 4000K, 1000LUMENS, STANDARD DISTRIBUTION WITH CLEAR SEMI SPECULAR RELFECTOR.	ELECTRONIC	RECESSED	18.4	120V 1P 2W
CE	•	18.4W LED	LITHONIA LIGHTING LDN6-40/10-6AR-120-EL	6" LED DOWNLIGHT, 4000K, 1000LUMENS, STANDARD DISTRIBUTION WITH CLEAR SEMI SPECULAR RELFECTOR. PROVIDE EMERGENCY BATTERY BACK UP 90 MIN. MINIMUM.	ELECTRONIC	RECESSED	18.4	120V 1P 2W

MAVEN Job #15EMB084
Tel: (480) 303-0180 ENGINEERING Fax: (480) 303-0184 2245 West University Drive, Suite 10 Tempe, Arizona 85281

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DRAWING

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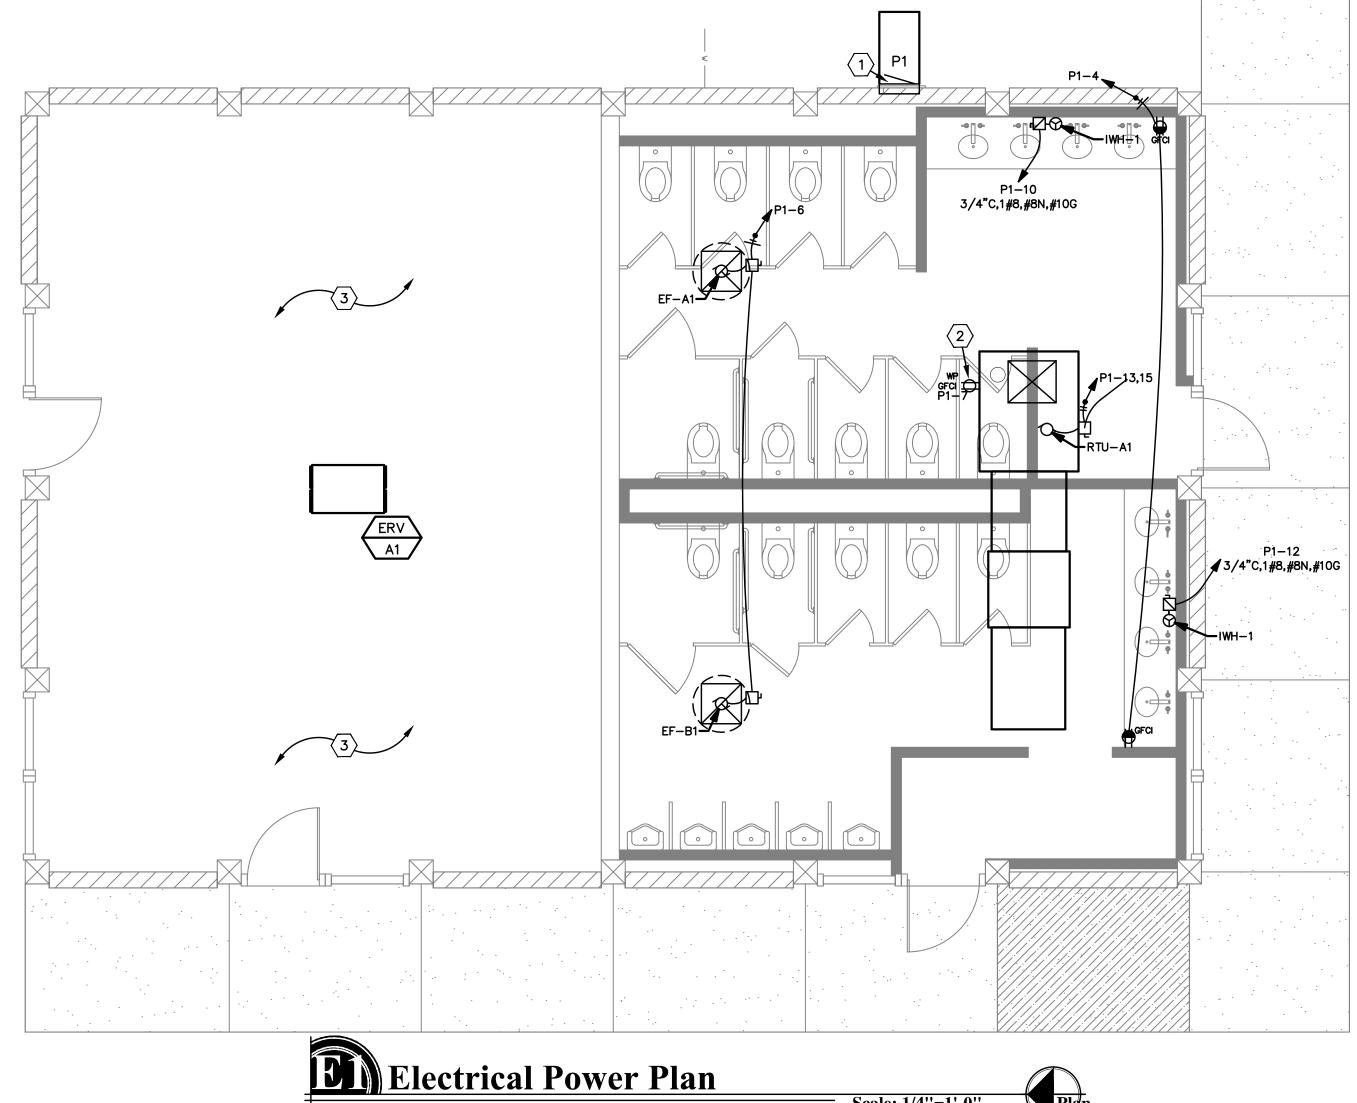
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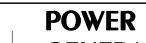
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EXPIRES: 09/30/16

SSOCi

DRAWN BY ERC CHECKED BY KJH DATE July 10, 2015 SCALE AS NOTED JOB NO. 670





### **GENERAL NOTES:**

A. ALL EXTERIOR DISCONNECTS SHALL BE W.P. TYPE.

B. ALL RECEPTACLES WITHIN 6'-0" OF A SINK TO BE GFCI RATED.

C. REFER TO MECHANICAL AND PLUMBING PLANS FOR EXACT SIZE, LOCATION, AND ELECTRICAL REQUIREMENTS FOR ALL MECHANICAL AND PLUMBING EQUIPMENT. PROVIDE ELECTRICAL SERVICE AS REQUIRED FOR EACH ITEM.

D. ELECTRICAL CONTRACTOR RESPONSIBLE FOR COORDINATING EXACT LOCATION, QUANTITIES, AND INSTALLATION REQUIREMENTS OF ELECTRICAL EQUIPMENT IN

F. ALL EXTERIOR RECEPTACLES SHALL BE W.P./GFCI TYPE.

G. ALL ELECTRICAL SWITCHGEAR EQUIPMENT SHOWN IS BASED ON SIEMENS BRAND EQUIPMENT U.N.O.

H. ALL ELECTRICAL PANEL BOARDS SHALL MAINTAIN 3'-0" INFRONT WORKING CLEARANCE REFER TO ONE-LINE FOR DETAILS.

I. PER NEC 430.102 A DISCONNECTING MEANS SHALL BE PROVIDED FOR A MOTOR IN ACCORDANCE WITH NEC 430.102(B)(1) OR (B)(2).


J. ALL 125VOLT, 15/20 AMP RECEPTACLES IN GARAGE SHALL BE GFCI TYPE PER NEC 210.8(B)(8)

#### **KEYED NOTES**: (#)

1. EXISTING PANEL BOARD MAINTAIN 3'-0" INFRONT WORKING CLEARANCE REFER TO ONE-LINE FOR DETAILS.

2. PROVIDE MAINTENANCE RECEPTACLE WITHIN 25' OF ALL MECHANICAL EQUIPMENT UNLESS EXISTING RECEPTACLES ARE PRESENT PER NEC 210.63.

3. EXISTING LIGHTING & POWER TO REMAIN IN THIS AREA.

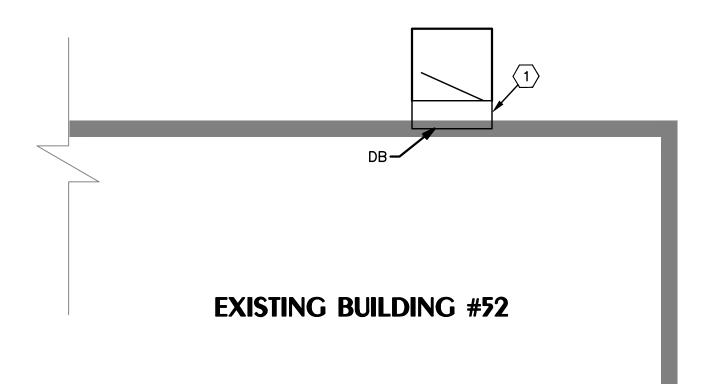

				GEN.	ERAL	EQUIP	PMENT	SCHE	CDULE		
CALLOUT	SYMB0L	NEMA	VOLTS	CALCULATED AMPS	KVA	CALC. LOAD KVA	MCA	MOCP	CIRCUIT	WIRE CALLOUT	NOTE 1
EF-A1	<b>♡</b> □	NEMA 3R	120V 1P 2W	5.8	0.7	0.87			P1-6	3/4"C,1#12,#12N,#12G	ON TIME CLOCK
EF-B1	<b>♂</b> □	NEMA 3R	120V 1P 2W	5.8	0.7	0.87			P1-6	3/4"C,1#12,#12N,#12G	ON TIME CLOCK
IWH-1	<b>♥</b> ~☑		120V 1P 2W	31	3.72	3.72			P1-10	3/4"C,1#8,#8N,#10G	
IWH-1	<b>⊗</b> ^Z'		120V 1P 2W	31	3.72	3.72			P1-12	3/4"C,1#8,#8N,#10G	
RTU-A1	<b>♡</b> □	NEMA 3R	240V 2P 2W	4.9	1.18	1.47	8.6	20	P1-13,15	3/4"C,2#12,#12G	PROVIDE 30A/2P NEMA 3R FUSED DISCONNECT, FUSED PER MANUFACTUROR'S RECOMMENDATION

Scale: 1/4''=1'-0''

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EXPIRES: 09/30/16

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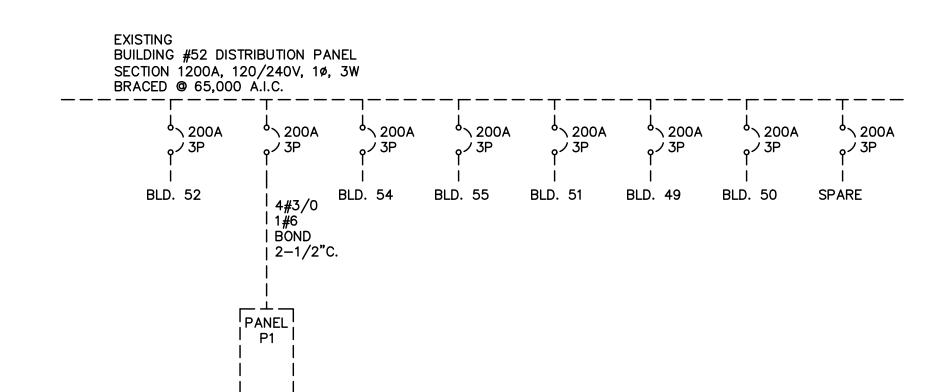
DRAWN BY ERC CHECKED BY KJH DATE July 10, 2015 SCALE AS NOTED

DRAWING:

								F	AULT	CURRI	ENT SC.	HEDUI	,E								
DEVICE	FAULT	AIC	L-N		UTILITY			FED	FROM				FEEL	ER			TOTAL	DIREC	TLY CONNEC	CTED MOTOR	R LOAD
		RATING	VOLTS	FAULT	X	R	DEVICE	FAULT	X	R	SIZE	X / 1000'	R / 1000'	LENGTH	X	R	FAULT	KVA	FAULT	X	R
DB	51,611	65,000	120V	51,502	0.002285	0.000457					(3)#600kcmil	0.013	0.0077		0	0	109				
P1	10,557	22,000	120V	10,448	0.007001	0.009104	DB	51,502	0.002285	0.000457	#3/0	0.042	0.077	112'-4"	0.0047	0.0086	109	6.57	109	1.063	0.2659

ROOM							TS 240	/120	V 2P 3V	AIC 22,000		
l	М	OUNTING	FLUSH			BUS	AMPS	200		MAIN BKR 200		
l	F	ED FROM	I DB			NEU	TRAL 1	00%		LUGS STANDARD		
	N	OTE NEI	MA-3R									
Ī		CKT				KVA	LOAD		СКТ		KVA	LOAD
ļ	#	BKR	CIRCUIT D	ESCRIPTION		A	В	#	BKR	CIRCUIT DESCRIPTION	A	В
l		20/1	RR LIGHTI	NG		0.386		2	20/1	W.OUTSIDEGFCI	0.18	1
l		20/1	SPARE				0	4	20/1	RECEPTACLE		0.36
ļ	5	20/1	SPARE		_	0		6	20/1	EF-A1, EF-B1	1.39	1
١		20/1	1	E GFCI RECEPTACI	.E		0.36	8	20/1	SPARE		0
ŀ		20/1	SPARE SPARE			0	0	10		IWH-1	3.72	7 70
ı		20/1 20/2	RTU-A1			0.588	1 -	12	40/1 30/2	IWH-1   AC	2	3.72
	15	20/2	10-41			0.566	0.588		130/2	AC	2	2
		20/2	"230V OU	ITI FT IN"		1	0.000	18	20/1	OUTSIDE LIGHTS	1	-
	19		2507 55	TEET III			1	20		POWER POLES	1	1.08
İ										TOTAL CONNECTED KVA BY PHAS	E 10.3	9.11
İ										TOTAL CONNECTED AMPS BY PHAS	E 85.6	75.9
İ			1		CONN. KVA	CALC. K\	/A			CONN. KVA CALO	C. KVA	-
l				LIGHTING	1.39		(125%)			CONTINUOUS 0 0	(12	5%)
ı				LARGEST MOTOR			(125%)			HEATING 0 0	(100	
l				OTHER MOTORS			(100%)			NONCONTINUOUS 7.44 7.44	(100	•
l				RECEPTACLES	3.98		50%>10)	)		KITCHEN EQUIP 0 0	(N/	
1						·	·			NONCOIN/DIVERSE 0 0	(N/	'A)

\* E.C. TO VERIFY USED BREAKERS TO REMAIN FOR EXISTING SPACE.



### PARTIAL ONE-LINE DIAGRAM

#### GENERAL NOTES :(1) (1)

- A. DASHED LINES INDICATE EXISTING EQUIPMENT. SOLID LINES INDICATE NEW EQUIPMENT U.N.O.
- B. ALL NEW ELECTRICAL GEAR TO MATCH EXISTING EQUIPMENT U.N.O.
- C. PER NEC 210.4(B), ALL MULTIWIRE BRANCH CIRCUITS ARE TO BE PROVIDED WITH A DEVICE THAT WILL DISCONNECT POWER TO ALL UNGROUNDED CONDUCTORS SIMULTANEOUSLY AT POINT OF ORIGIN.

A. SWITCHBOARD COMPONENTS, INCLUDING OVERCURRENT PROTECTIVE DEVICES SHALL BE FULLY RATED FOR THE AVAILABLE FAULT CURRENT SHOWN.

B. PROVIDE ARC FLASH AND SHOCK HAZARD WARNING

SYSTEM WITHOUT THE PRIOR APPROVAL OF THE DESIGN

#### **PANEL SCHEDULE NOTES:**

A. A.I.C. RATING SHOWN ON PANEL SCHEDULES ARE THE MINIMUM RATING FOR NEW AND REPLACEMENT OVERCURRENT PROTECTIVE DEVICES. EACH DEVICE SHALL BE FULLY RATED AT AFC AS SHOWN ON

B. ALL PANEL BOARDS SHALL HAVE A TYPE WRITTEN DIRECTORY IDENTIFYING EACH NUMBERED CIRCUIT PLACED IN A DIRECTORY HOLDER INSIDE THE DOOR.

C. THE CONTRACTOR SHALL PERMANENTLY MARK WITH PERMANENT MARKER THE CIRCUIT IDENTIFICATIONS ON THE COVERPLATES OF RECEPTACLES, EQUIPMENT, AND LIGHTING JUNCTION BOXES. (STICK ON LABELS NOT ACCEPTABLE)

**ONE-LINE NOTES:** 

IDENTIFICATION PER NEC ARTICLE 110.16

C. "NO DESIGN CHANGES MAY BE MADE TO THE ENGINEER AND THE ELECTRICAL INSPECTOR."

ONE-LINE DIAGRAM.

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DRAWN BY CHECKED BY KJH SCALE AS NOTED

WORK LISTED ELSEWHERE: THE FOLLOWING ITEMS OF WORK, EVEN IF DESCRIBED IN THIS SECTION SHALL BE EXECUTED UNDER OTHER SECTIONS. FURNISHING AND INSTALLING MOTORS AND CONTROLS. FURNISHING HOLE CUTTING IN PRE-CAST STRUCTURAL CONCRETE.

CODES AND ORDINANCES: INSTALL ALL WORK IN ACCORDANCE WITH THE NATIONAL ELECTRICAL CODE AND ITS LATEST REVISIONS WITH THE REGULATIONS OF ANY AND ALL STATE AND LOCAL CODES AND ORDINANCES STANDARD SPECIFICATIONS OF THE POWER

ALL WORK INCLUDED SHALL COMPLY WITH ALL STATE AND LOCAL RULES AND REGULATIONS. FURNISH TO THE OWNER ALL CERTIFICATES OF INSPECTION AND APPROVAL AS REQUIRED.

PRIOR TO SUBMITTING PROPOSAL, THE BIDDER SHALL EXAMINE ALL GENERAL CONSTRUCTION DRAWINGS AND VISIT CONSTRUCTION SITE TO BECOME FAMILIAR WITH EXISTING CONDITIONS UNDER WHICH HE WILL HAVE TO OPERATE AND WHICH WILL IN ANY WAY AFFECT THE WORK UNDER THIS CONTRACT. NO SUBSEQUENT ALLOWANCE WILL BE MADE IN THIS CONNECTION ON BEHALF OF THE CONTRACTOR

PRIOR TO ORDERING ANY MATERIALS OR DOING ANY WORK, VERIFY THE DIMENSIONS AT THE SITE; CORRECTNESS OF DIMENSIONS WILL BE THIS CONTRACTOR'S RESPONSIBILITY. NO EXTRA CHARGES OR COMPENSATION WILL BE ALLOWED FOR DIFFERENCES BETWEEN ACTUAL DIMENSIONS AND DIMENSIONS INDICATED ON THE DRAWINGS. IMMEDIATELY REPORT DIFFERENCES TO THE ARCHITECT AND DO NOT PROCEED WITH WORK UNTIL THE ARCHITECT RENDERS HIS DECISION.

HANGERS: FURNISH AND INSTALL ALL UNISTRUT, HANGERS, SUPPORTS, ETC., REQUIRED FOR WORK UNDER THIS DIVISION. SUPPORT CONDUIT FROM BUILDING STRUCTURE, NOT FROM CEILING SUPPORTS. BRANCH CIRCUIT CONDUIT 3/4" AND SMALLER MAY BE RUN

FINAL LOCATION OF SURFACE FEATURES: SHALL BE ACCOMPLISHED IN THE FIELD, SUBJECT TO THE APPROVAL OF THE ARCHITECT. THE LOCATION OF ALL SWITCHES, FIXTURES, PANELS, ETC., AND THEIR PROXIMITY AND RELATIONSHIP TO ALL VISIBLE FEATURES OF EQUIPMENT FURNISHED BY OTHER TRADES, SHALL BE MADE KNOWN TO THE ARCHITECT. IN CASE OF CONFLICT BETWEEN TRADES, OR BETWEEN A TRADE AND THE ARCHITECT, THE DECISION OF THE ARCHITECT SHALL BE FINAL AND HIS INSTRUCTIONS IN THESE

STANDARD OF MATERIAL AND WORKMANSHIP: ALL MATERIALS SHALL BE NEW AND SHALL CONFORM TO UL STANDARDS IN EVERY CASE WHERE SUCH A STANDARD HAS BEEN ESTABLISHED AND SHALL BEAR THE UL LABEL. ALL WORK SHALL BE PERFORMED IN ACCORDANCE WITH THE BEST ACCEPTED STANDARDS OF GOOD WORKMANSHIP AND SHALL PRESENT A NEAT APPEARANCE WHEN

ALL CUTTING NECESSARY FOR INSTALLATION OF THE WORK AND REPAIR OF ALL DAMAGE TO WORK UNDER OTHER SECTIONS, SHALL BE INCLUDED IN WORK SPECIFIED UNDER THIS SECTION INCLUDING PATCHING, FLASHING AND SEALING ALL ROOF PENETRATIONS

CONTRACTOR SHALL REPAIR ANY DAMAGE DONE BY HIMSELF OR HIS WORKMEN AND SHALL COORDINATE HIS WORK WITH THAT OF OTHER PARTIES. CUTTING, PATCHING, AND PROVIDING ANY OPENINGS, LINTEL, OR SUPPORTS REQUIRED FOR INSTALLATION OF THE WORK SHALL BE INCLUDED IN THIS SECTION.

ALL EXPOSED ELECTRICAL EQUIPMENT, CONDUIT, FLUSH PANEL FRONTS, TRANSFORMERS, SWITCHES, SWITCHBOARDS, PANELS AND SIMILAR ITEMS SHALL BE PAINTED AS SPECIFIED UNDER THE PAINTING SECTION OF ARCH. SPECIFICATIONS. SUPERVISE ALL PAINTING OF ELECTRICAL EQUIPMENT.

2 BASIC MATERIALS AND METHODS:

CUTTING AND PATCHING

GENERAL: ALL CONDUCTORS SHALL BE COPPER.

ALL INTERIOR BRANCH WRING SHALL BE TYPE "THW-2", "THHN-2" OR "THWN-2", 600 VOLT AND A MINIMUM OF #12 EXCEPT FOR CONTROL WRING WHICH SHALL BE STRANDED AND A MINIMUM OF #14.

WIRE #8 AND LARGER SHALL BE STRANDED. WIRE #2 AND LARGER, OR AS NOTED, SHALL BE TYPE "XHHW-2" WITH CROSS LINK

MANUFACTURERS SHALL BE GENERAL CABLE, OKONITE, ROME CABLE, ANACONDA, GENERAL ELECTRIC, KAISER OR SOUTHWIRE. INSTALLATION: IMC CABLE MAY BE USED WHERE CONCEALED ONLY IN ACCESSIBLE SPACES AND ONLY WITH WRITTEN PERMISSION FROM THE OWNER PRIOR TO INSTALLATION. ALL INSTALLATIONS SHALL COMPLY WITH NEC 330.

WIRE SINGLE PHASE EQUIPMENT AND LIGHTING SO THERE IS A MINIMUM OF IMBALANCE BETWEEN CURRENT CARRYING CONDUCTORS. CONDUCTORS SHALL BE CONTINUOUS AND OF SUCH LENGTHS THAT NO SPLICE OCCURS EXCEPT WITHIN OUTLET, JUNCTION OR PULLBOXES, SWITCH, CONDUIT FITTINGS, OR OTHER SIMILAR DEVICES IN EQUIPMENT. SPLICES SHALL JOIN CONDUCTORS SECURELY TOGETHER BOTH MECHANICALLY AND ELECTRICALLY. MAKE CONNECTIONS AND SPLICES FOR #10 WIRE AND SMALLER WITH BUCHANAN B-CAP, 3-M SCOTCHLOK OR IDEAL WING-NUT, PRE-

INSULATED WRE CONNECTORS (SIZES AS RECOMMENDED BY MANUFACTURER). MAKE CONNECTIONS AND SPLICES FOR #8 COMPRESSION TYPE CONNECTORS BY O.Z., BURNDY, BUCHANAN, T & B OR ILSCO. TAPE ALL SPLICES WITH PLASTIC SO INSULATION IS AT LEAST EQUIVALENT TO INSULATION OF CONDUCTORS. THOROUGHLY CLEAN ENDS BEFORE SPLICING. WHERE PLASTIC TAPE IS D AND THERE IS ANY DANGER OF INSULATION DAMAGE FROM PRESSURE OR JOINT AGAINST NON-CURRENT CARRYING METAL PARTS, USE FRICTION TAPE FOR ADDITIONAL PROTECTION.

ALL WIRING IN PANELBOARDS, CENTERS AND GUTTERS SHALL BE NEATLY ARRANGED. WIRE SHALL BE HELD BUNDLED BY TY-RAPS. WIRES SHALL BE CONNECTED TO CIRCUIT BREAKERS, SWITCHES AND OTHER DEVICES PERPENDICULAR TO TERMINAL LUGS. LIGHTING AND POWER CIRCUITS SHALL BE IDENTIFIED BY PANEL LETTER AND CIRCUIT NUMBER WITH BRADY WRAPAROUND CLOTH WIRE MARKERS AT ALL TERMINATIONS AND JUNCTIONS.

ALL BRANCH CIRCUIT AND FEEDER CONDUCTORS SHALL BE COLOR- CODED TO CONFORM TO THE EXISTING COLOR CODES. SOLID CONDUCTORS SHALL LOOP TIGHTLY AND COMPLETELY AROUND TERMINAL SCREWS ON ALL WIRING DEVICES. CONDUIT RACEWAYS:

CONDUIT SYSTEMS SHALL BE RIGID GALVANIZED METAL, INTERMEDIATE METAL CONDUIT (IMC), ELECTRICAL METALLIC TUBING (EMT), RIGID ALUMINUM, NON-METALLIC FIBER OR AS SPECIFIED HEREIN OR AS INDICATED ON THE PLANS. ALL SYSTEMS SHALL BE

RIGID STEEL CONDUIT SHALL BE HEAVY-WALLED, HOT-DIPPED, GALVANIZED OR SHERARIZED. USE RIGID STEEL CONDUIT IN CONCRETE SLABS, IN GRADE, IN EXPOSED LOCATIONS SUCH AS TUNNELS AND EQUIPMENT ROOMS, WHERE EXPOSED TO WEATHER AND WHERE BURIED IN EARTH. SCHEDULE 40 PVC NON-METALLIC CONDUIT MAY BE USED BURIED IN EARTH MINIMUM 24" BELOW GRADE. ALL CONDUIT EXTENDED UNDER DRIVEWAYS OR AREAS OF VEHICULAR USAGE SHALL BE GALVANIZED HEAVY WALL STEEL CONDUIT OR SCHEDULE 80 PVC NON-METALLIC CONDUIT, MINIMUM 30" BELOW GRADE. STEEL CONDUIT INSTALLED UNDERGROUND SHALL BE ENCASED IN TWO INCH MINIMUM, CONCRETE ENVELOPE OR COMPLETELY COVERED WITH HALF-LAPPED #50 SCOTCH-WRAP TOP OF UNDERGROUND CONDUITS SHALL NOT BE LESS THAN 24". PVC ELECTRICAL CONDUIT, UL LISTED MAY BE USED FOR UNDERGROUND SECTIONS OF LIGHTING CIRCUITS AND FEEDER RACEWAYS. ALL NON-METALLIC CONDUITS SHALL HAVE BOND WIRES, EXCEPT WHEN

IMC SHALL BE ZINC COATED STEEL TUBING. IMC MAY BE USED WHERE RIGID STEEL IS PERMITTED.

EMT SHALL BE ZINC—COATED. EMT MAY BE USED IN FURRED SPACES, IN METAL OR WOOD STUD WALLS IN EITHER EXPOSED OR CONCEALED FASHION AND WHERE NOT SUBJECT TO DAMAGE EXCEPT FOR BRANCH CIRCUITS AND FEEDERS OVER 100A. EMT SHALL BE REAMED AFTER CUTTING AND SHALL BE MADE TO BUTT IN THE CENTER OF THE COUPLING.

FLEXIBLE CONDUIT SHALL BE USED IN MINIMUM LENGTHS TO CONNECT TO MOTORS, RECESSED FIXTURES, TRANSFORMERS AND EQUIPMENT SUBJECT TO VIBRATION. IN EXTERIOR AND WET LOCATIONS, USE ANACONDA TYPE VA FLEXIBLE CONDUIT WITH APPLETON OR T & B WATER TIGHT CONNECTORS. FLEXIBLE CONDUIT CONNECTORS SHALL BE COMPRESSION OR CLAMP TYPE; SCREW ON TYPE

WHERE EXPOSED, INSTALL CONDUIT PARALLEL TO WALLS AND PARTITIONS; DO NOT CROSS WINDOW OPENINGS. WHERE SUSPENDED CEILING OCCURS, RUN CONDUIT CONCEALED ABOVE FURRED CEILING AND IN WALLS. ALL CONDUIT STUBBED-UP THROUGH ROOF SHALL BE FLASHED WITH A TYPE OF FLASHING APPROVED BY MANUFACTURER OF ROOFING MATERIALS AND INSTALLED IN ACCORDANCE WITH THE MANUFACTURER'S RECOMMENDATIONS. CONDUIT SHALL BE FIRMLY FASTENED WITHIN 3 FEET OF EACH OUTLET BOX, JUNCTION BOX, CABINET OR FITTING AND SHALL BE SUPPORTED AT LEAST EVERY 10 FEET.

EMT OR THREADLESS RIGID SHALL BE COMPRESSION TYPE, MACHINE STEEL INSULATED THROAT, APPLETON, RACO, T & B, OR TOMIC

BOXES SHALL BE FABRICATED FROM CODE GAUGE STEEL WITHOUT KNOCKOUTS AND A MINIMUM 14 GAUGE FRONT COVER. FINISH

SHALL BE GALVANIZED STEEL OR PHOSPHATE UNDERCOATING WITH 2 FINISH COATS; HAMMER GRAY OR BAKED ENAMEL. JUNCTION BOXES SHOWN OUTSIDE, FLUSH OR SURFACE MOUNTED, SHALL BE WATER TIGHT, ALL WELDED CONSTRUCTION WITH

PROVIDE CONTRAST PLASTIC EMBOSSING TAPE, ADHESIVE BACKED NAMEPLATES FOR ALL STARTERS AND DISCONNECT SWITCHES.PROVIDE LAMICOID NAMEPLATES FOR ALL DISTRIBUTION SWITCHES, BREAKERS, LIGHTING AND POWER PANELS, SIZE OF

FUSES SHALL BE HIGH-CAPACITY, CURRENT-LIMITING, LOW-PEAK OR DUAL ELEMENT AS INDICATED.

DUAL-ELEMENT FUSES SHALL BE USED FOR ALL MOTOR LOADS.

TYPE "R" FUSE SHALL BE USED FOR MOTOR LOADS AND WHERE INDICATED ON DRAWINGS.

FURNISH TO THE OWNER AT EACH SWITCHBOARD, 2 SETS OF SPARE FUSES FOR EACH SIZE USED BELOW 100 AMPS AND ONE SET

FUSES AS SPECIFIED ON THE DRAWINGS ARE SELECTED TO PROVIDE COMPLIANCE WITH SECTION 110-9, 110-10 AND 230-98 OF THE NATIONAL ELECTRICAL CODE. SUBSTATION OF FUSES BY OTHER MANUFACTURER'S (BUSSMAN, ECONOMY FUSE OR SHAWMUT) WILL BE CONSIDERED WHEN SHORT CIRCUIT CALCULATIONS AND FUSE CURVES ARE PROVIDED TO THE ENGINEER FOR REVIEW. ADDITIONALLY, THE CONTRACTOR SHALL PROVIDE CALCULATIONS TO SHOW THE PROPOSED FUSES PROVIDE FOR A SELECTIVELY COORDINATED DESIGN.

OUTLET BOXES SHALL BE STANDARD GALVANIZED STEEL TYPE MINIMUM 1.5" DEEP, SINGLE OR GANG STYLE, OF SIZE TO ACCOMMODATE DEVICE NOTED AND INSTALLED IN ACCORDANCE WITH ARTICLE 370 OF THE NEC. HANDY BOXES AND SECTIONAL SWITCH BOXES WILL NOT BE PERMITTED.

BOXES EXPOSED OUTDOORS SHALL BE CAST FERROUS ALLOY, TYPE FS UNILETS WITH SCREW HUBS OR EQUAL.

BOXES SHALL BE SECURELY AND RIGIDLY FASTENED TO THE STRUCTURE UPON WHICH THEY ARE MOUNTED OR SECURELY AND RIGIDLY EMBEDDED IN CONCRETE OR MASONRY.

PROVIDE FIXTURE STUDS AND PLASTER RINGS AS REQUIRED TO BRING ALL OUTLETS TO WITHIN 1/8" OR LESS OF FINISHED SURFACE. APPROVED MANUFACTURERS ARE: APPLETON, RACO, STEEL CITY OR BOWERS.

LIGHT SWITCHES: (COLOR SELECTION BY ARCH.) HUBBELL #1221-I 20A SINGLE POLE HUBBELL #1223-I 20A THREE WAY MANUFACTURERS SHALL BE HUBBELL, BRYANT OR SIERRA. RECEPTACLES:

ALL FUSES SHALL BE ON THE SAME MANUFACTURER.

HUBBELL #5362-I OR #5242 MOUNT WITH GROUND "U" SLOT DOWN FOR ISOLATED GROUND - HUBBELL #IG8300 (ORANGE)

PLATES SHALL BE S = POSTSC MOOTH PLASTIC TO MATCH RECEPTACLE AND OF ONE MANUFACTURER; BRYANT, SIERRA OR APPROVED EQUAL. COLOR MUST BE SELECTED BY ARCH.

DEVICE PLATES SHALL BE INSTALLED SO AS TO COMPLETELY SEAT AGAINST THE WALL SURFACE.

3 SERVICE AND DISTRIBUTION: LIGHTING PANELS:

IGHTING PANELS SHALL BE CIRCUIT BREAKER TYPE. CABINETS SHALL HAVE DOORS FASTENED TO TRIM WITH CONCEALED HINGES AND BE PROVIDED WITH FLUSH TYPE COMBINATION LATCH AND LOCK; THREE KEYS FOR EACH. ALL PANELS SHALL BE KEYED ALIKE. CABINETS AND TRIMS SHALL BE FACTORY PAINTED TWO FINISH COATS AND SHALL BE FLUSH OR SURFACE MOUNTED AS INDICATED. EACH CIRCUIT SHALL BE NUMBERED AND COMPLETELY IDENTIFIED BY MEANS OF A TYPEWRITTEN CARD PLACED IN DIRECTORY HOLDER ON INSIDE OF DOOR. ALL DIRECTORY HOLDERS SHALL BE SIX (6) INCHES WIDE. BEFORE INSTALLING, TIGHTEN ALL BOLTED CONNECTIONS THAT MAY HAVE BECOME LOOSE IN SHIPPING.

CABINETS SHALL BE WITHOUT KNOCKOUTS. ALL KNOCKOUTS SHALL BE CUT ON THE JOB.

STUB UP ON 3/4" CONDUIT INTO THE FURRED SPACE ABOVE FLUSH MOUNTED CABINETS FOR EACH TWO SPARE CIRCUITS OR SPACES; TO A MAXIMUM OF 5 CONDUITS.

ALL PANELBOARDS SHALL HAVE THE SIZE OF THE FEEDER AND CONDUIT STENCILED ON THE INSIDE OF THE DOOR. "DYMO" TAPE OR EQUIVALENT IS NOT ACCEPTABLE. SAFETY (DISCONNECT) SWITCHES:

SHALL BE HEAVY DUTY TYPE WITH COVER INTERLOCKS. PROVIDE ALL DISCONNECT SWITCHES REQUIRED BY CODE. SWITCHES FOR MOTOR APPLICATIONS SHALL BE HORSEPOWER RATED.

SWITCHES LOCATED OUTSIDE THE BUILDING SHALL HAVE NEMA TYPE 3R ENCLOSURES.

FURNISH AND INSTALL THE PROPER SIZE FUSES (DETERMINED FROM FULL LOAD NAMEPLATE READINGS ON MOTORS AND COMPENSATED FOR AMBIENT TEMPERATURE) IN ALL SAFETY SWITCHES WHETHER THEY BE FURNISHED BY THIS CONTRACTOR OR MOTOR WIRING:

ALL MOTORS WILL BE FURNISHED AND SET IN PLACE BY TRADE FURNISHED THE DRIVEN EQUIPMENT. FURNISH AND INSTALL ALL CONDUIT, WRING, CIRCUIT PROTECTIVE DEVICES, SWITCHES AND SUCH OTHER APPURTENANCES NECESSARY TO COMPLETE CONNECTION OF ALL MOTORS AND CONTROLS. THIS SHALL INCLUDE THE HIGH AND LOW VOLTAGE CONTROL WIRING. MOTORS AND CONTROLS FOR MECHANICAL EQUIPMENT SHALL BE WIRED IN ACCORDANCE WITH MANUFACTURER'S WIRING DIAGRAMS.

CONNECTIONS TO MOTOR STARTERS AND CONTROLS SHALL BE MADE WITH CONDUIT. FINAL CONNECTIONS TO MOTORS ON ADJUSTABLE BASES OR MOTORS SUBJECT TO EXCESSIVE VIBRATION SHALL BE MADE WITH FLEXIBLE CONDUIT, EXCEPT FOR OUTDOOR INSTALLATION IN WHICH CASE SEAL-TITE NEOPRENE COVERED FLEXIBLE CONDUIT WITH SEAL-TITE FITTINGS OR TYPE "SO" CORD WITH RUBBER GLAND WATER-TITE CORD GRIPS SHALL BE USED, BUT ONLY TO THE EXTENT OF MINIMUM LENGTHS REQUIRED FOR A CASE GROUND. REFER TO AIR CONDITIONING SECTION FOR SPECIFIC CONTROLS, SWITCHES, THERMOSTATS, ETC., FURNISHED FOR INSTALLATION UNDER THIS SECTION.

VERIFY HORSEPOWER RATINGS AND FULL LOAD CURRENTS OF MOTORS BEING SUPPLIED BY OTHER TRADES. ANY DISCREPANCY BETWEEN ACTUAL FULL LOAD CURRENTS OF MOTORS DELIVERED TO THE JOB SITE AND STANDARD FULL LOAD CURRENTS OF SINGLE PHASE AND THREE PHASE SQUIRREL CAGE INDUCTION MOTORS, (HORSEPOWER RATING AS LISTED) SHALL BE REPORTED TO THE ARCHITECT FOR CORRECTION AND DECISION BEFORE ANY AFFECTED WORK IS DONE.

THE NEUTRAL CONDUCTORS AND ALL OTHER EXPOSED NON CURRENT CARRYING METAL PARTS AS REQUIRED BY CODE SHALL BE GROUNDED. GROUNDING BUSHINGS SHALL BE USED AS REQUIRED AND SHALL BE O.Z. INSULATED TYPE BL OR APPROVED EQUAL. NO GROUNDING SHALL BE MADE TO GAS PIPING. WHERE EQUIPMENT OR DEVICES ARE SERVED BY NON-METALLIC DUCTS, ENCLOSURES SHALL BE GROUNDED BY MEANS OF A CODE SIZE BARE OR GREEN INSULATED EQUIPMENT GROUND WIRE INSTALLED IN THE DUCT WITH THE CURRENT CARRYING CONDUCTORS AND BE BONDED SECURELY IN EACH CABINET TERMINATING THE GROUND WIRE. COPPER JUMPERS SHALL BRIDGE FLEXIBLE CONDUIT AND BE INSTALLED IN THE CONDUIT. ALL SERVICE GROUNDS SHALL BE IN ACCORDANCE WITH THE UFER GROUND.

4 LIGHTING: LIGHTING FIXTURES:

FIXTURES SHALL BE FURNISHED COMPLETE WITH LAMPS OF PROPER WATTAGE AND BE UL LISTED IN ACCORDANCE WITH LIGHTING FIXTURE SCHEDULE. PROVIDE ALL FITTINGS, HANGERS, SUPPORTS, PLASTER FRAMES AND OTHER NECESSARY APPURTENANCE. FIXTURES SHOWN IN FIXTURE SCHEDULE WITH SAME LETTER DESIGNATION SHALL BE OF ONE MANUFACTURER AND BE IDENTICAL IN

ALL FLUORESCENT FIXTURES SHALL BE UL APPROVED AND HAVE PROTECTED BALLASTS, UL CLASS P RATED CBM APPROVED, ETL

FIXTURE MANUFACTURER SHALL PROVIDED THE PROPER BALLAST WITH THE FIXTURE TO PERMIT CONTINUOUS OPERATION WITHIN THE TEMPERATURE CONDITION OF THE INSTALLED LOCATION. VERIFY THE TYPE AND CONSTRUCTION OF ALL CEILINGS BEFORE SUBMITTING SHOP DRAWINGS OR ORDERING FIXTURES TO DETERMINE COMPATIBILITY. THE CONTRACTOR SHALL BE RESPONSIBLE FOR COORDINATION WITH THE CEILING SUPPLIER AND MODIFICATION NECESSARY FOR PROPER INSTALLATION OF THE FIXTURES WITHIN OR ON THE CEILINGS.

INCANDESCENT FIXTURES SHALL BE UL LISTED FOR THE APPLICATION AND BE PROVIDED WITH JUNCTION BOXES APPROVED FOR THROUGH WIRING. FLUSH OR RECESSED INCANDESCENT FIXTURES SHALL HAVE THERMAL PROTECTION AND SHALL BE IDENTIFIED AS

FLUORESCENT LAMPS SHALL BE T-8, RAPID-START, UNLESS OTHERWISE NOTED. ALL INCANDESCENT LAMPS SHALL BE 130 VOLTS

APPROVED MANUFACTURERS ARE: GENERAL ELECTRIC, SYLVANIA OR PHILLIPS.


FIXTURES SHALL BE WRED COMPLETE WITH COLOR-CODED WRES TO INDICATED POLARITY. WHITE FIXTURE WRE SHALL BE CONNECTED TO THE SHELL TERMINALS OF SOCKETS AND CONNECTED TO THE NEUTRAL WRE OF THE LIGHTING SYSTEM. INSTALL AND CONNECT LIGHTING FIXTURES ON ALL DESIGNATED OUTLETS IN BUILDING. NON-DESIGNATED OUTLETS SHALL BE EQUIPPED WITH FIXTURES SIMILAR TO LIKE AREAS.

LIGHTING FIXTURE INSTALLATION:

ALL FIXTURES SHALL BE TESTED BEFORE AND AFTER INSTALLATION AND SHALL SHOW FREE OF GROUNDS, SHORTS, ETC. ALL FIXTURES AND FIXTURE SUPPORTS SHALL BE CLEANED, PAINTED WHERE NECESSARY AND LEFT IN FIRST CLASS OPERATING CONDITION UPON COMPLETION OF THE WORK. THIS CONTRACTOR SHALL MAKE GOOD ALL BREAKAGE OF LAMPS, GLASS AND FIXTURE BOWLS OR OTHER DAMAGE OR ARRANGE FOR REPLACEMENT WITH THE ARCHITECT.

ALL FIXTURES SHALL BE PROPERLY SUPPORTED FROM CEILING STRUCTURE.

ALL FLUORESCENT FIXTURES RECESSED IN THE CEILING OR IN A GRID CEILING SHALL BE PROVIDED WITH EARTHQUAKE CLIPS.

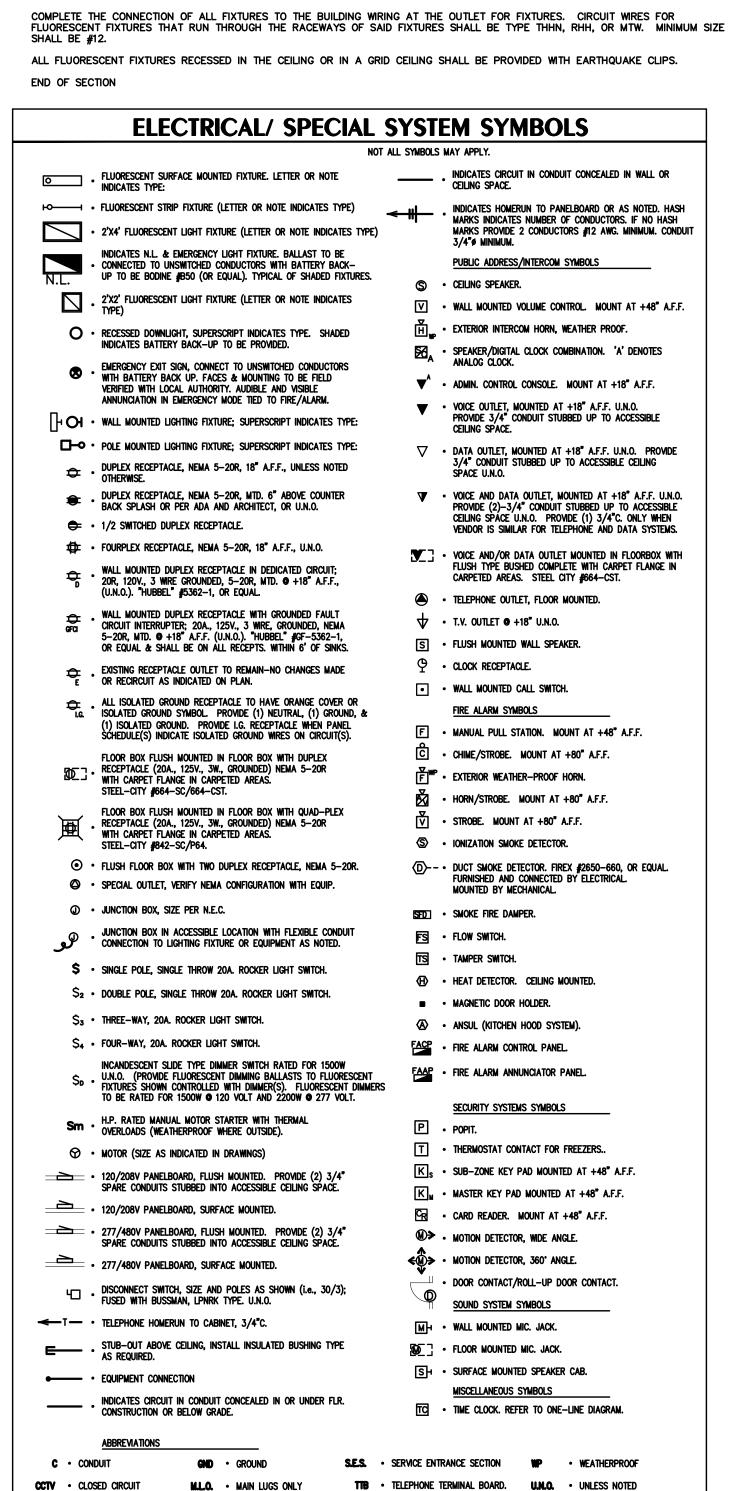

MAVEN Job #15EMBU84
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TELEPHONE MOUNTING

VP • VANDAL-PROOF

WG . WIRE GUARD.

M.C.B. • MAIN CIRCUIT BREAKER

**EDF** • ELECTRIC DRINKING

NATIONAL ELECTRICAL

Tempe, Arizona 85281 Note: Any changes made to final bid documents due to field changes will be billed hourly to the contractor.

ISOLATED GROUND

E.P. • EXPLOSION PROOF

REVISIONS

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